04: APARTMENT MIX CHANGED SINCE ENDORSEMENT.

26: GENERAL UPDATES TO STRUCTURE THROUGHOUT.

28: WESTERN FACADE ALCOVE WIDTH INCREASED TO 6M TO MIRROR THE EASTERN FACADE ALCOVE.

30: BALCONIES HAVE BEEN REMOVED FROM ALL BUT 4 APARTMENTS ON EACH HOTEL LEVEL & AC CONDENSER UNITS RELOCATED TO PENTHOUSE LEVEL PLANT AREA.

32: FRITTED PRIVACY GLAZING INCLUDED WHERE APARTMENTS OVERLOOK EACH OTHER.

34: SLAB OUTLINES RATIONALISED TO IMPROVE CONSTRUCTABILITY AND FACADE SHAPING. MINIMAL IMPACT TO BUILDING MASSING AND FORM.

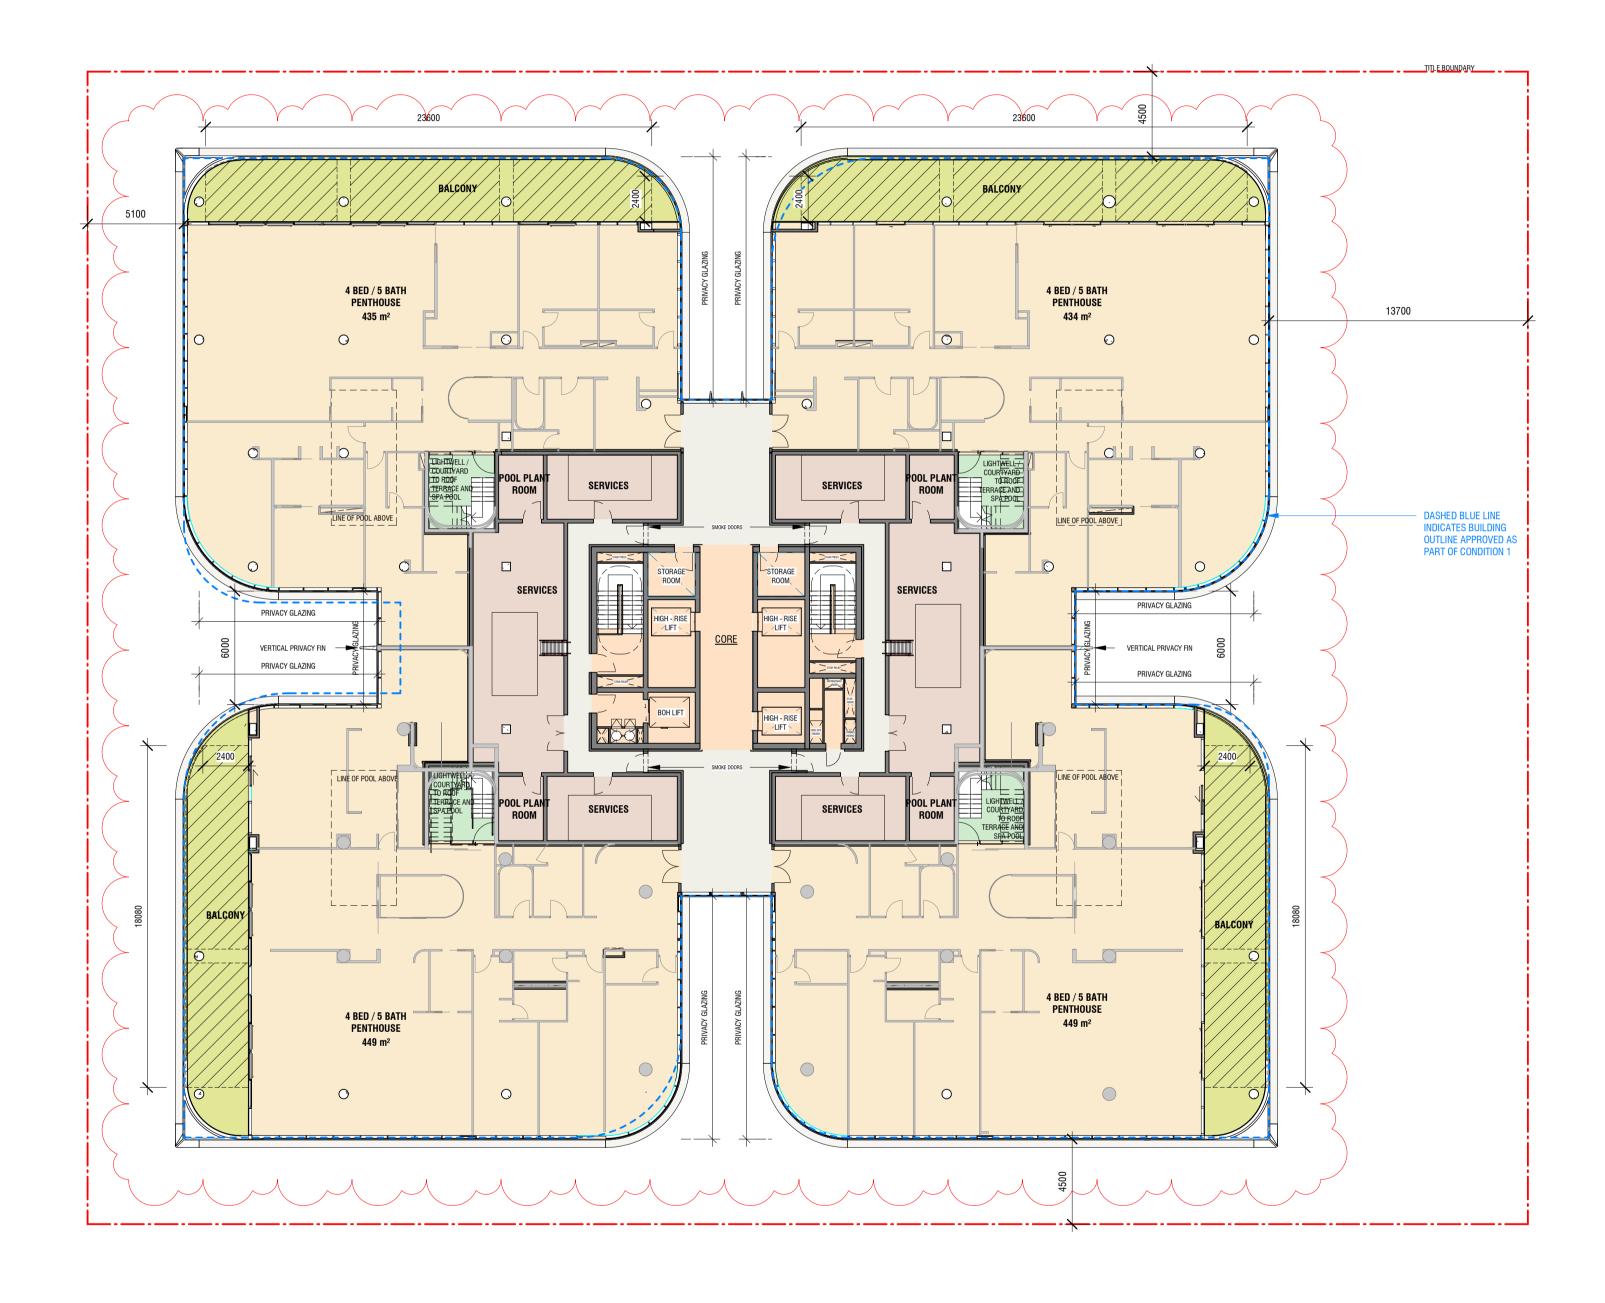
35: FACADE FINS DETAILING AND MODELLING UPDATED.

42: BUILDING OUTLINE APPROVED AS PART OF CONDITION 1 SHOWN ON PLANS

51: WESTERN SETBACK INCREASE NOTED

52: VERTICAL TRANSPORT ARRANGEMENT UPDATED.

City of Port Phillip
Advertised Plan
Planning Application No. 1033/2018/A
No. of Pages: 21 of 40



22: ROOF TERRACE LANDSCAPE, POOL LOCATION AND LIGHTWELL LOCATION UPDATED.

26: GENERAL UPDATES TO STRUCTURE THROUGHOUT.

27: GLASS CANOPY AND STRUCTURAL BEAMS ADDED TO PENTHOUSE TERRACES.

28: WESTERN FACADE ALCOVE WIDTH INCREASED TO 6M TO MIRROR THE EASTERN FACADE ALCOVE.

34: SLAB OUTLINES RATIONALISED TO IMPROVE CONSTRUCTABILITY AND FACADE SHAPING. MINIMAL IMPACT TO BUILDING MASSING AND FORM.

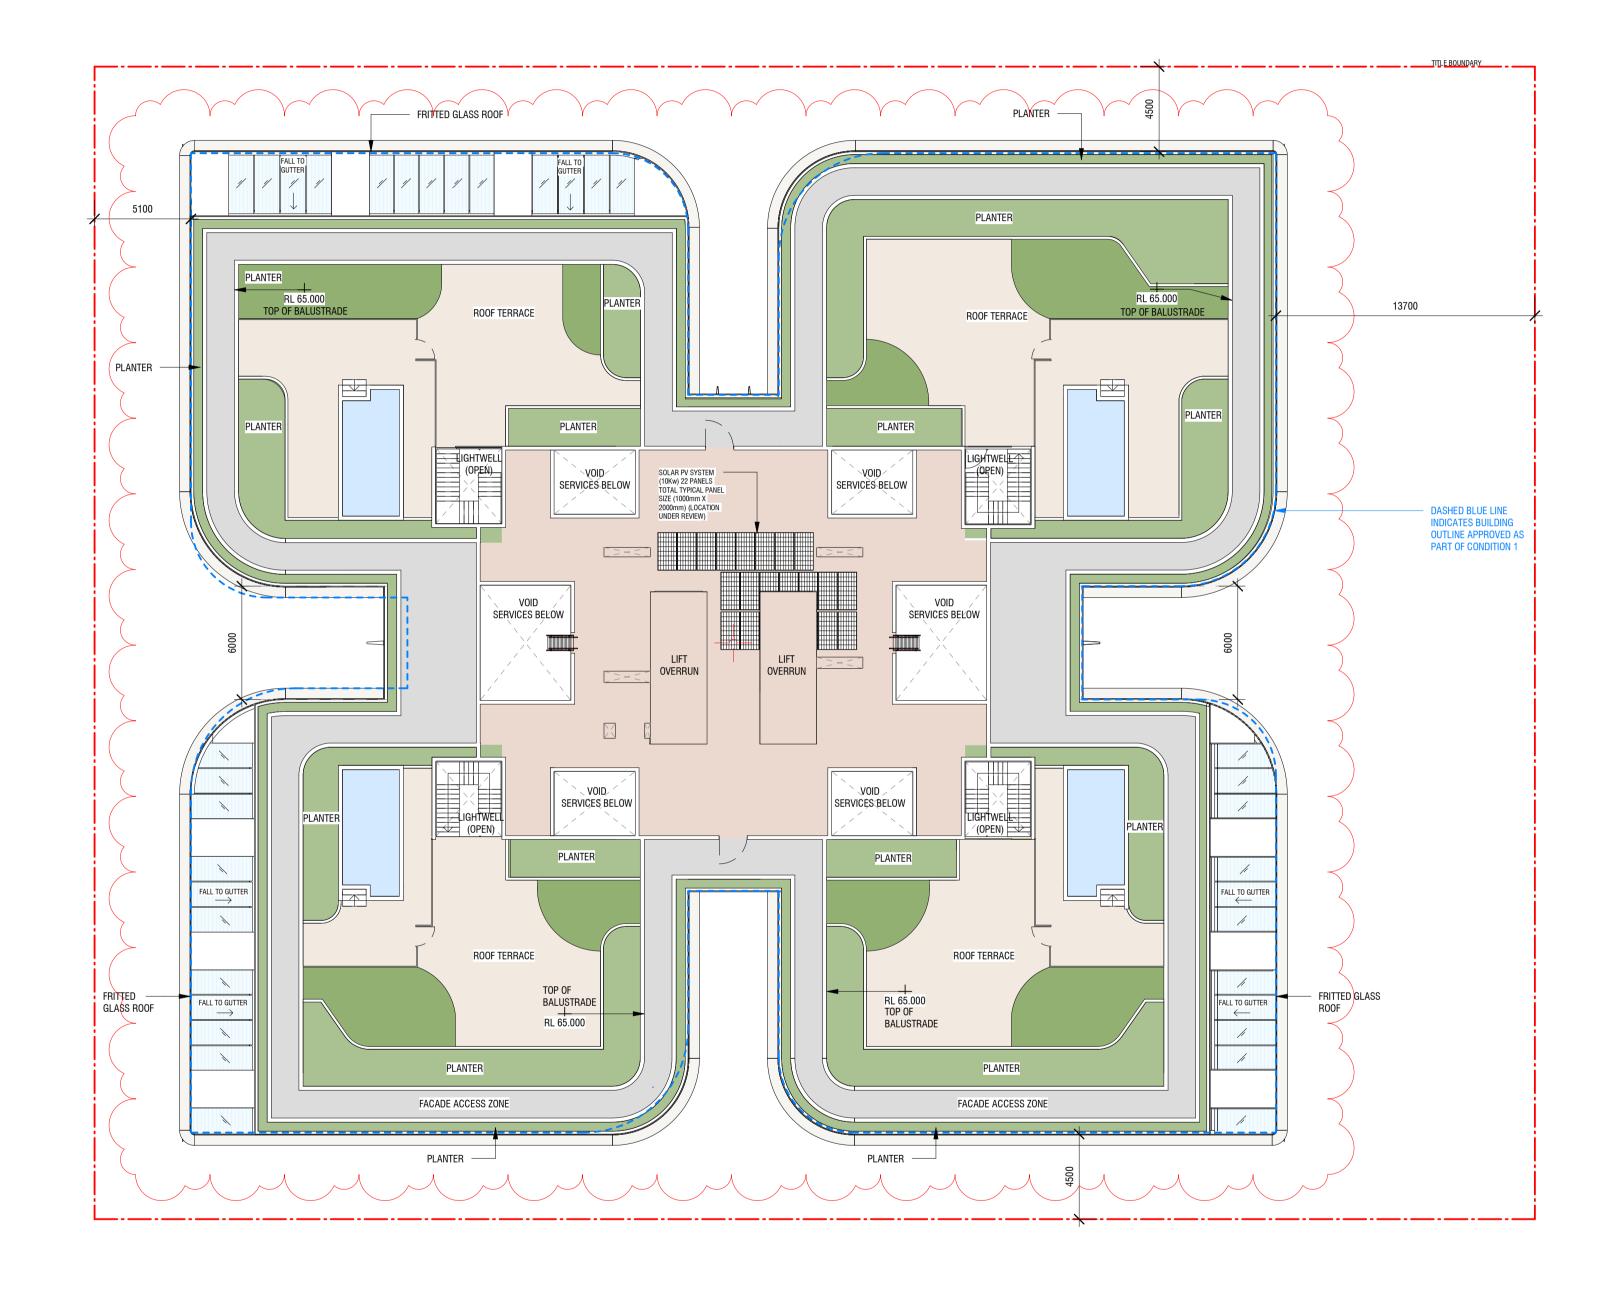
35: FACADE FINS DETAILING AND MODELLING UPDATED.

42: BUILDING OUTLINE APPROVED AS PART OF CONDITION 1 SHOWN ON PLANS.

51: WESTERN SETBACK INCREASE NOTED

52: VERTICAL TRANSPORT ARRANGEMENT UPDATED.

City of Port Phillip Advertised Plan Planning Application No. 1033/2018/A No. of Pages: 22 of 40



City of Port Phillip
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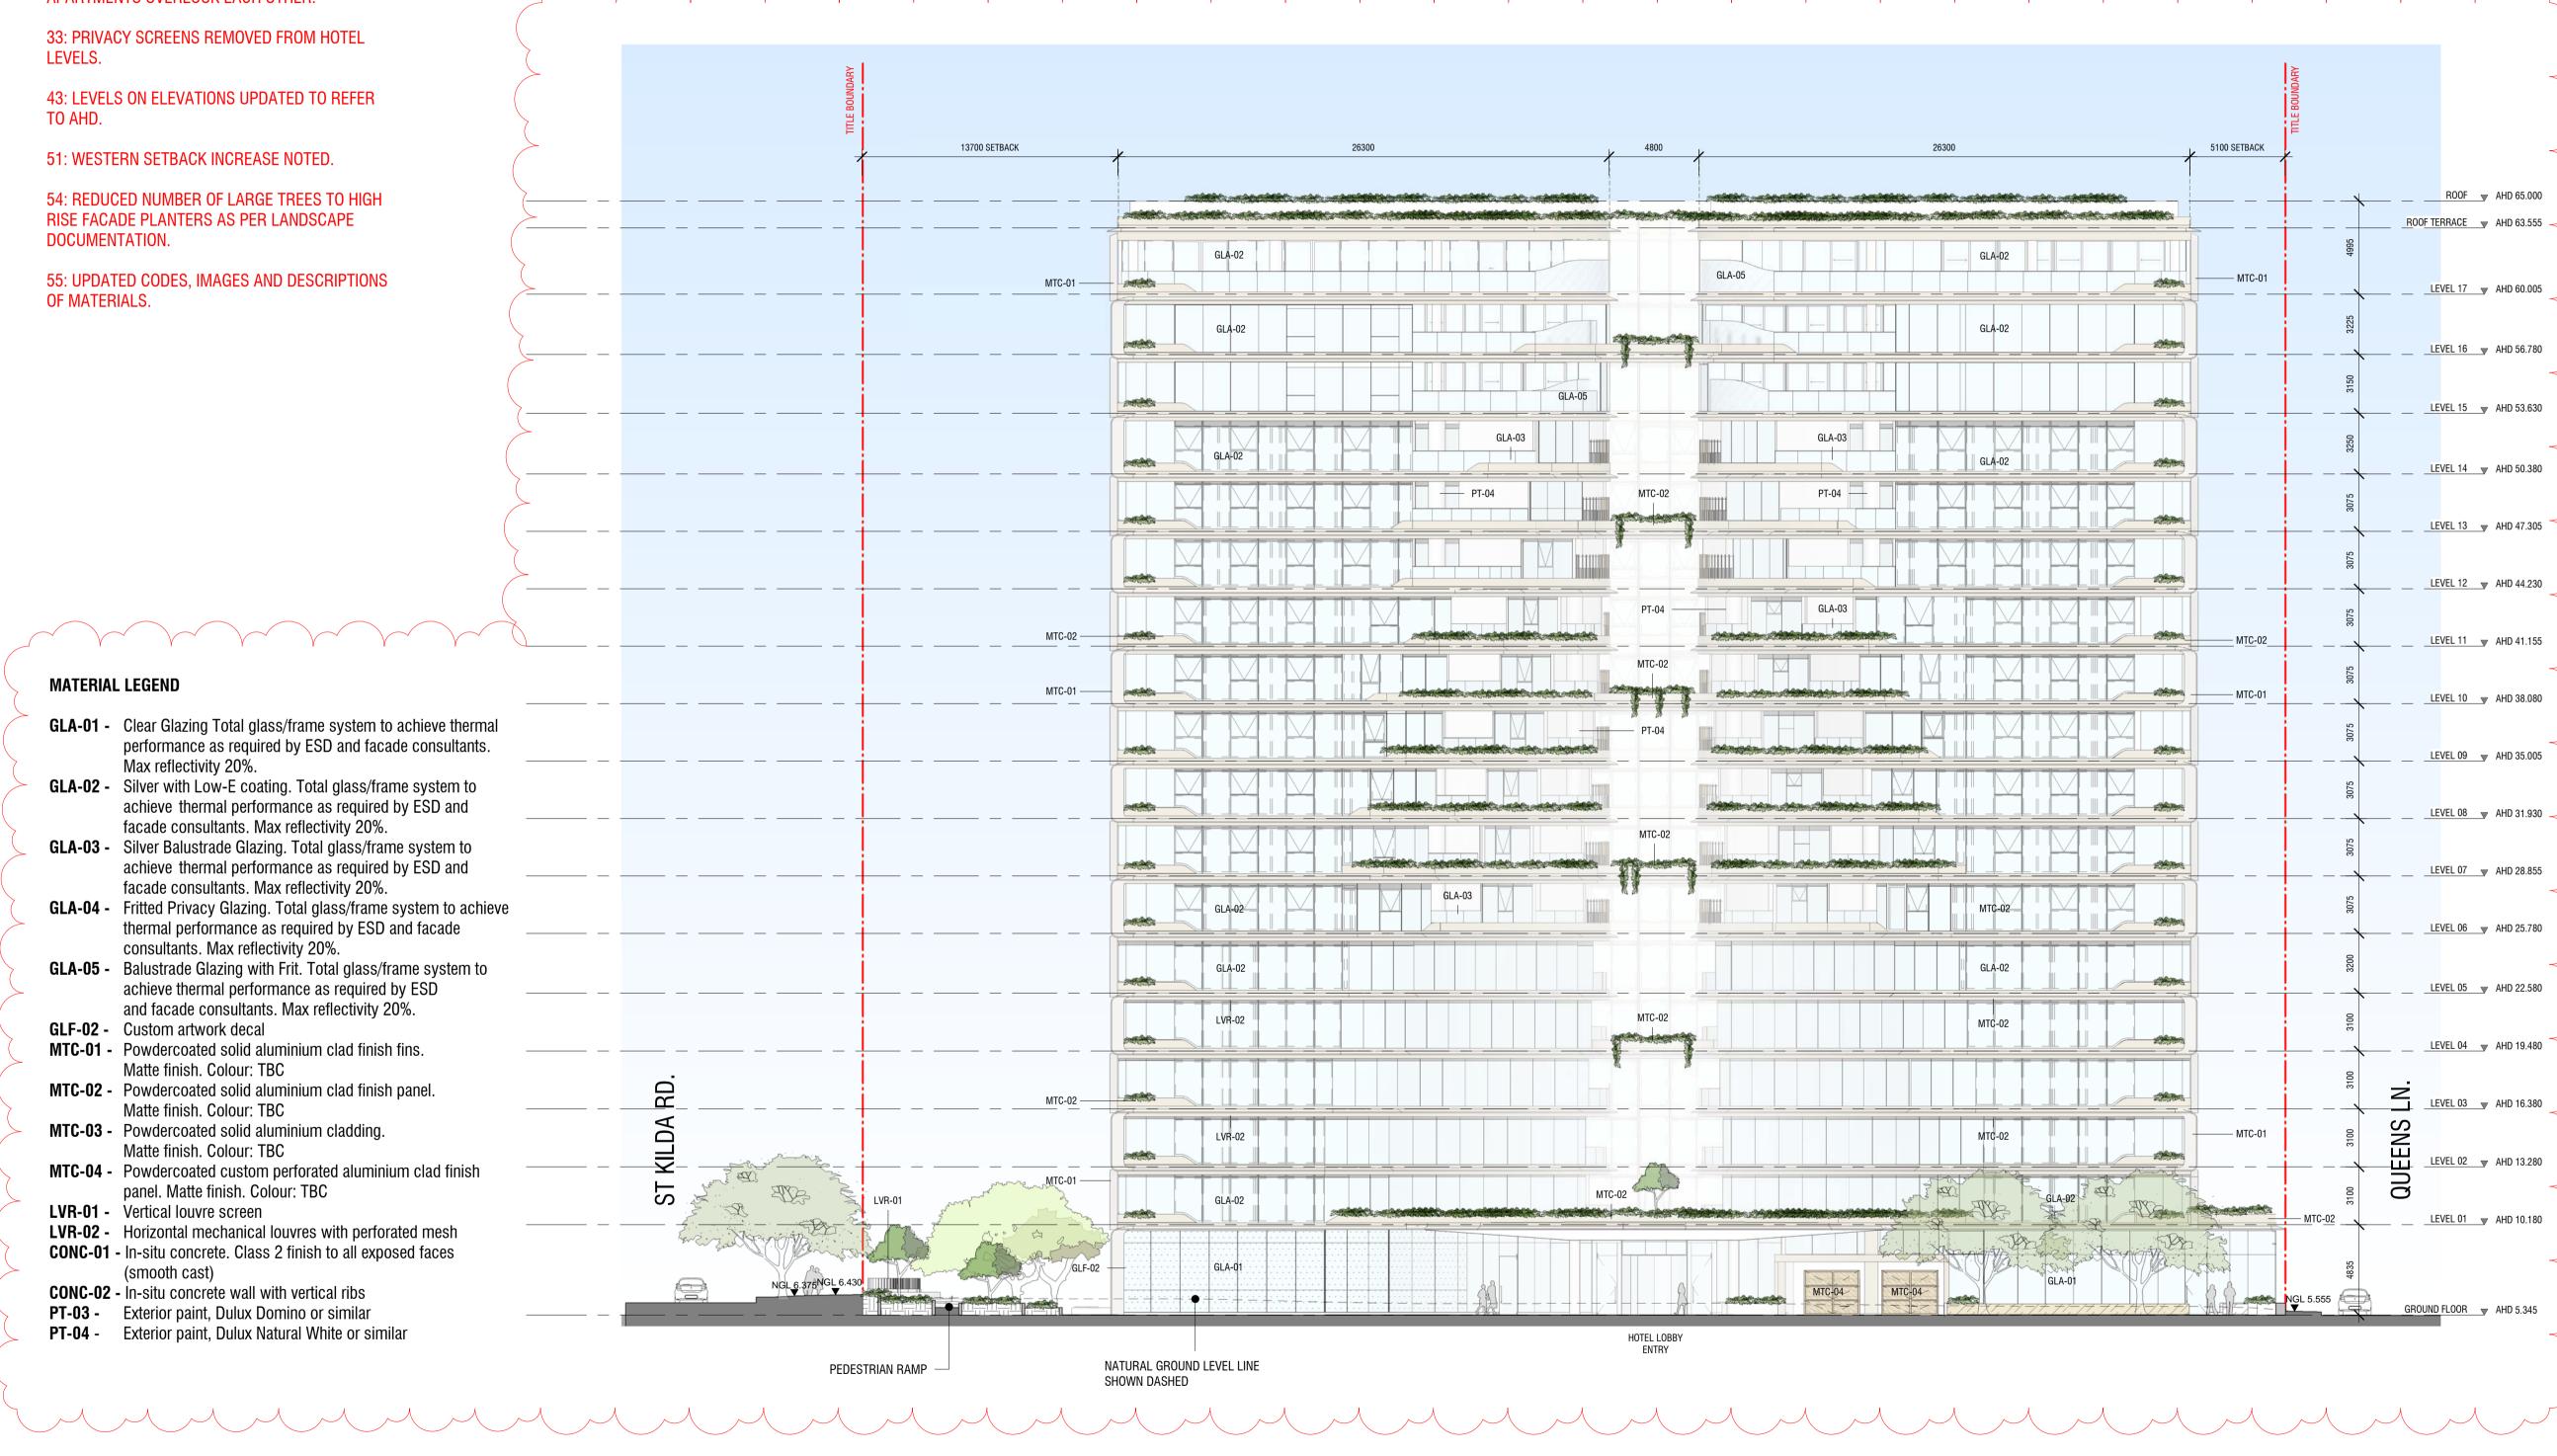
SUMMARY OF ARCHITECTURAL CHANGES:

1: DELETION OF LEVEL 01 PODIUM - LEVEL 01 NOW FORMS PART OF THE TOWER FORM AND IS THE FIRST LEVEL OF SERVICED APARTMENTS.

20: GROUND FLOOR LEVEL RAISED TO REDUCE DIFFERENTIAL TO STREET, AND IMPROVE CLEARANCE FOR CAR PARK RAMP ENTRY.

31: RESIDENTIAL PRIVACY SCREEN DESIGN AND DETAILING UPDATED.

32: FRITTED PRIVACY GLAZING INCLUDED WHERE APARTMENTS OVERLOOK EACH OTHER.



NORTH ELEVATION SCALE 1:200

472-474 ST KILDA RD

NORTH ELEVATION

Drawing Title:

TP-30-01

17/02/2023

Revision: Date:

As indicated @ A1

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City of Port Phillip SUMMARY OF ARCHITECTURAL CHANGES: Planning Application No. 1033/2018/A No. of Pages: 24 of 40 1: DELETION OF LEVEL 01 PODIUM - LEVEL 01

NOW FORMS PART OF THE TOWER FORM AND IS THE FIRST LEVEL OF SERVICED APARTMENTS.

20: GROUND FLOOR LEVEL RAISED TO REDUCE DIFFERENTIAL TO STREET, AND IMPROVE CLEARANCE FOR CAR PARK RAMP ENTRY.

31: RESIDENTIAL PRIVACY SCREEN DESIGN AND DETAILING UPDATED.

32: FRITTED PRIVACY GLAZING INCLUDED WHERE APARTMENTS OVERLOOK EACH OTHER.

33: PRIVACY SCREENS REMOVED FROM HOTEL LEVELS.

43: LEVELS ON ELEVATIONS UPDATED TO REFER TO AHD.

54: REDUCED NUMBER OF LARGE TREES TO HIGH RISE FACADE PLANTERS AS PER LANDSCAPE DOCUMENTATION.

55: UPDATED CODES, IMAGES AND DESCRIPTIONS OF MATERIALS.

MATERIAL LEGEND

GLA-01 - Clear Glazing Total glass/frame system to achieve thermal performance as required by ESD and facade consultants

Max reflectivity 20%. **GLA-02 -** Silver with Low-E coating. Total glass/frame system to achieve thermal performance as required by ESD and facade consultants. Max reflectivity 20%.

GLA-03 - Silver Balustrade Glazing. Total glass/frame system to achieve thermal performance as required by ESD and facade consultants. Max reflectivity 20%.

GLA-04 - Fritted Privacy Glazing. Total glass/frame system to achieve thermal performance as required by ESD and facade consultants. Max reflectivity 20%.

GLA-05 - Balustrade Glazing with Frit. Total glass/frame system to achieve thermal performance as required by ESD and facade consultants. Max reflectivity 20%.

GLF-02 - Custom artwork decal

MTC-01 - Powdercoated solid aluminium clad finish fins. Matte finish. Colour: TBC

MTC-02 - Powdercoated solid aluminium clad finish panel. Matte finish. Colour: TBC

MTC-03 - Powdercoated solid aluminium cladding. Matte finish. Colour: TBC

MTC-04 - Powdercoated custom perforated aluminium clad finish

panel. Matte finish. Colour: TBC

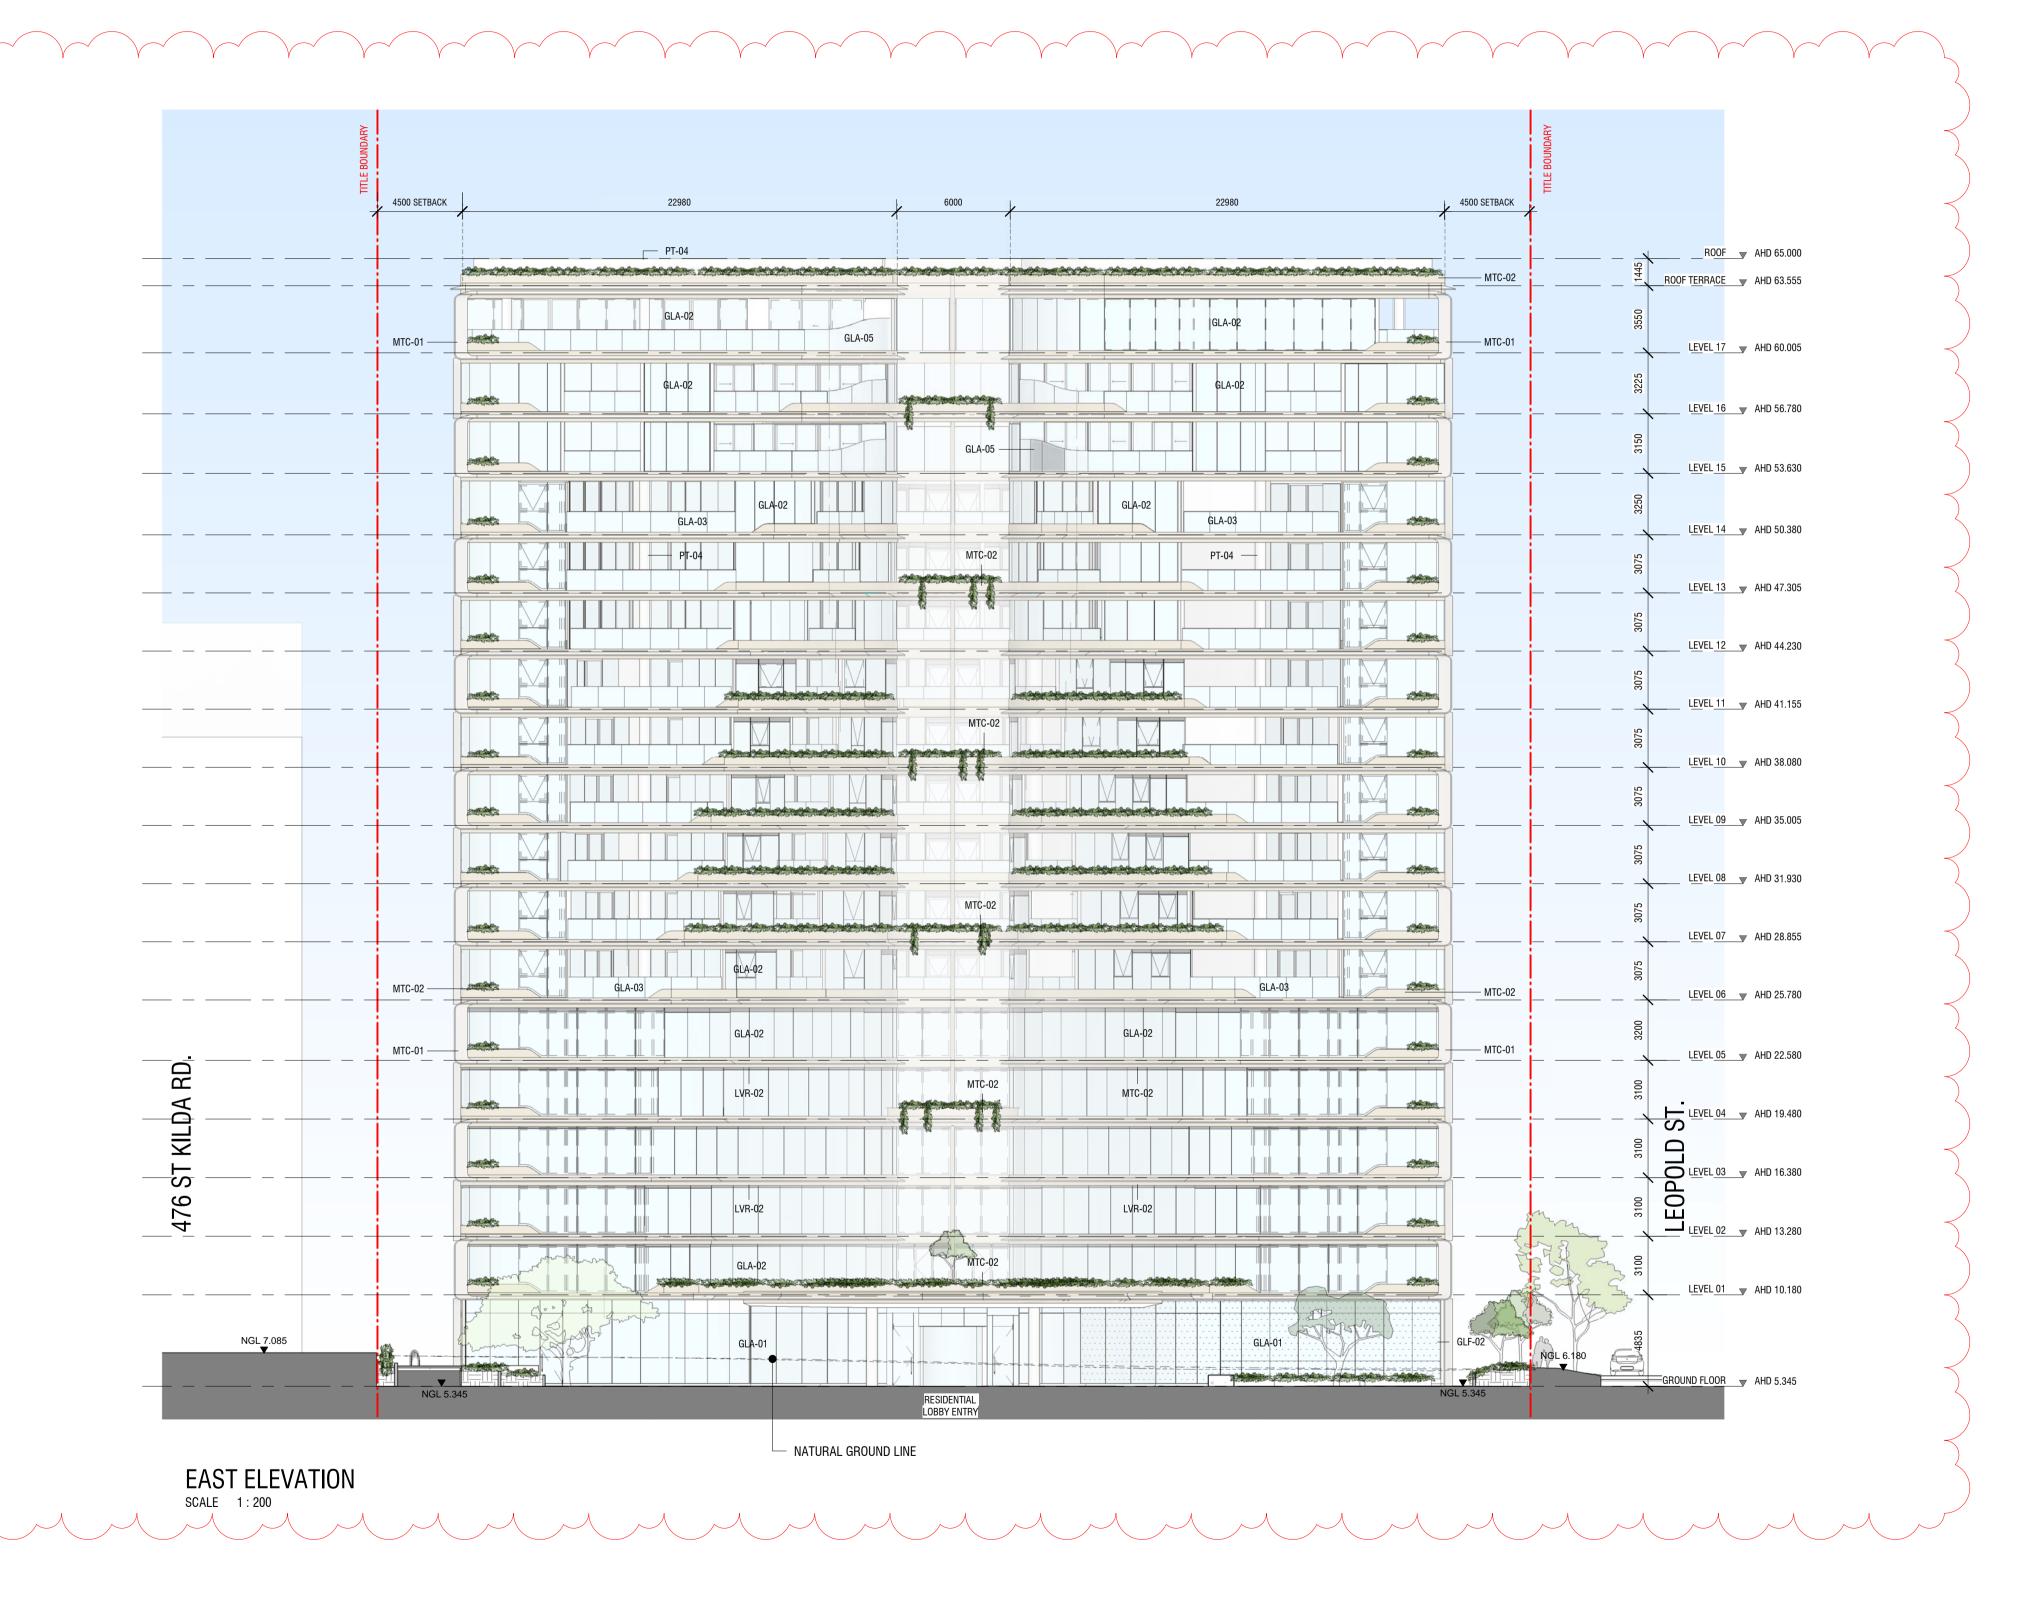
LVR-01 - Vertical louvre screen

LVR-02 - Horizontal mechanical louvres with perforated mesh CONC-01 - In-situ concrete. Class 2 finish to all exposed faces

(smooth cast)

CONC-02 - In-situ concrete wall with vertical ribs **PT-03 -** Exterior paint, Dulux Domino or similar

PT-04 - Exterior paint, Dulux Natural White or similar



Advertised Plan

472-474 ST KILDA RD

EAST ELEVATION

Drawing Title:

Drawing Number: **TP-30-02** Revision: Date: 17/02/2023

As indicated @ **A1**

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1: DELETION OF LEVEL 01 PODIUM - LEVEL 01 NOW FORMS PART OF THE TOWER FORM AND IS THE FIRST LEVEL OF SERVICED APARTMENTS.

19: PLANNING ADJUSTMENTS TO SERVICES AT GROUND FLOOR ALONG QUEENS LANE AND THE SOUTHERN LANEWAY.

20: GROUND FLOOR LEVEL RAISED TO REDUCE DIFFERENTIAL TO STREET, AND IMPROVE CLEARANCE FOR CAR PARK RAMP ENTRY.

31: RESIDENTIAL PRIVACY SCREEN DESIGN AND DETAILING UPDATED.

32: FRITTED PRIVACY GLAZING INCLUDED WHERE APARTMENTS OVERLOOK EACH OTHER.

33: PRIVACY SCREENS REMOVED FROM HOTEL LEVELS.

43: LEVELS ON ELEVATIONS UPDATED TO REFER TO AHD.

51: WESTERN SETBACK INCREASE NOTED.

53: LARGE FACADE PLANTERS REMOVED FROM SOUTHERN ELEVATION AS PER CONSULTANT ADVICE THERE WOULD BE INSUFFICIENT LIGHT FOR HEALTHY PLANT GROWTH.

54: REDUCED NUMBER OF LARGE TREES TO HIGH RISE FACADE PLANTERS AS PER LANDSCAPE DOCUMENTATION.

55: UPDATED CODES, IMAGES AND DESCRIPTIONS OF MATERIALS.

MATERIAL LEGEND

GLA-01 - Clear Glazing Total glass/frame system to achieve thermal performance as required by ESD and facade consultants. Max reflectivity 20%.

GLA-02 - Silver with Low-E coating. Total glass/frame system to achieve thermal performance as required by ESD and facade consultants. Max reflectivity 20%.

GLA-03 - Silver Balustrade Glazing. Total glass/frame system to achieve thermal performance as required by ESD and facade consultants. Max reflectivity 20%.

GLA-04 - Fritted Privacy Glazing. Total glass/frame system to achieve thermal performance as required by ESD and facade consultants. Max reflectivity 20%.

GLA-05 - Balustrade Glazing with Frit. Total glass/frame system to achieve thermal performance as required by ESD and facade consultants. Max reflectivity 20%.

GLF-02 - Custom artwork decal

MTC-01 - Powdercoated solid aluminium clad finish fins.

Matte finish. Colour: TBC

MTC-02 - Powdercoated solid aluminium clad finish panel.

Matte finish. Colour: TBC

MTC-03 - Powdercoated solid aluminium cladding.

Matte finish. Colour: TBC

MTC-04 - Powdercoated custom perforated aluminium clad finish

panel. Matte finish. Colour: TBC **LVR-01 -** Vertical louvre screen


LVR-02 - Horizontal mechanical louvres with perforated mesh

CONC-01 - In-situ concrete. Class 2 finish to all exposed faces

(smooth cast)

CONC-02 - In-situ concrete wall with vertical ribs
 PT-03 - Exterior paint, Dulux Domino or similar
 PT-04 - Exterior paint, Dulux Natural White or similar

City of Port Phillip
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SOUTH ELEVATION
SCALE 1: 200

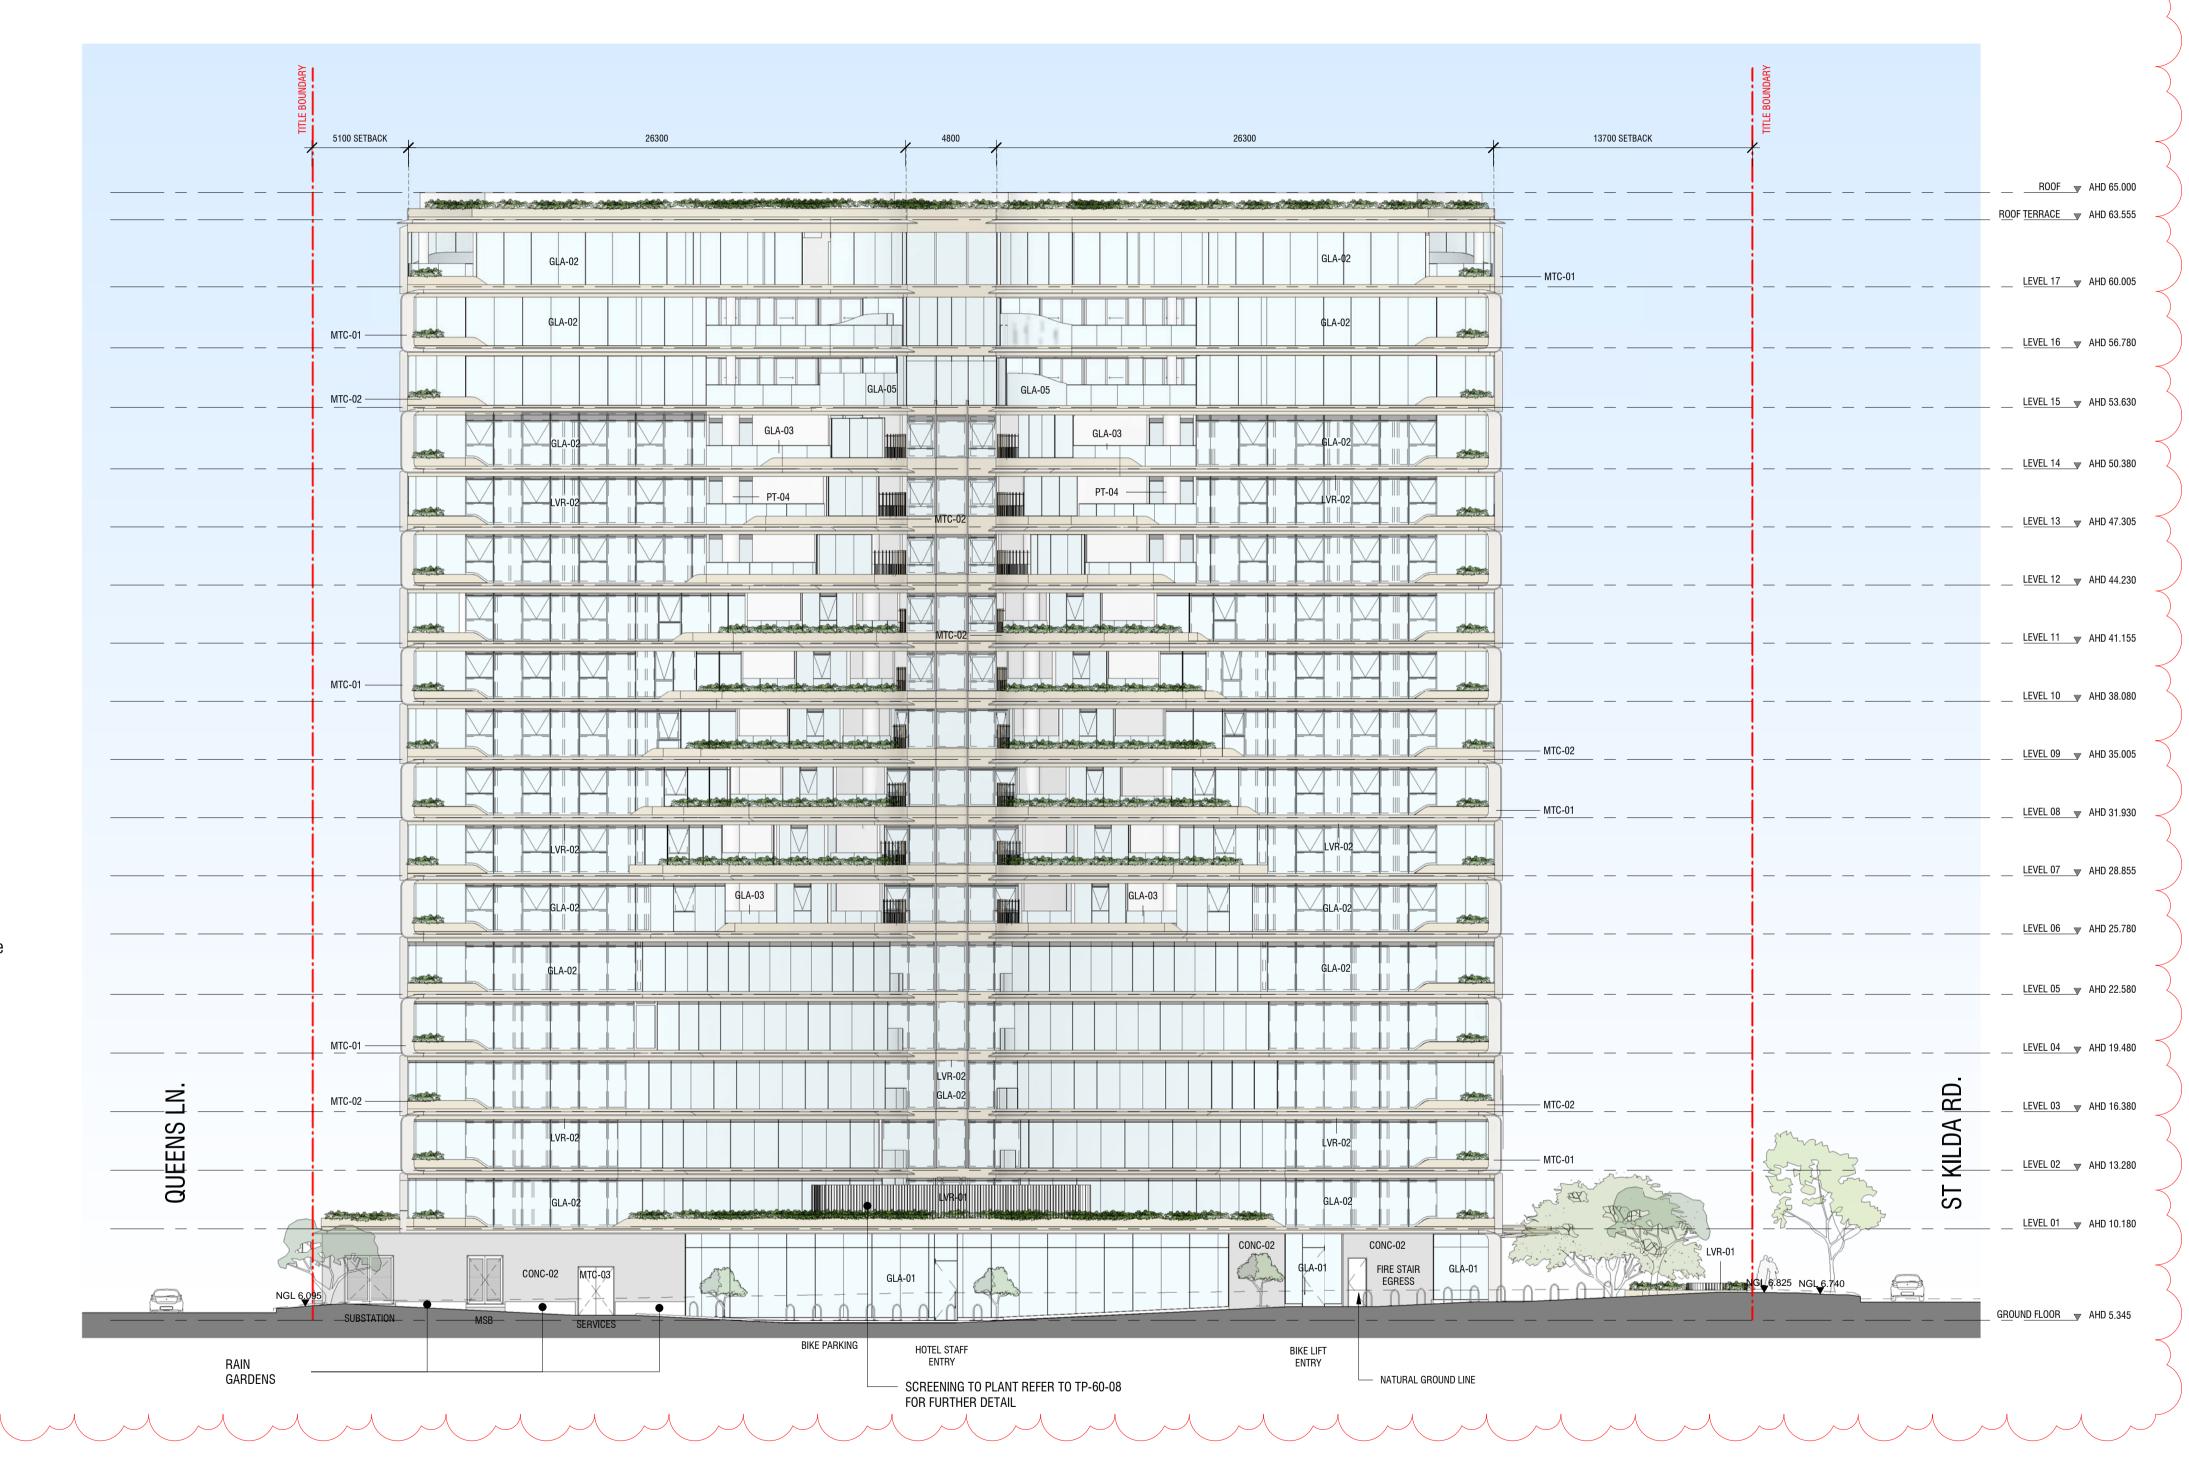472-474 ST KILDA RD

SOUTH ELEVATION

TP-30-03

Revision: Date: **17/02/2023**

As indicated @ A1

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COX

Version: 3, Version Date: 18/05/2023

1: DELETION OF LEVEL 01 PODIUM - LEVEL 01 NOW FORMS PART OF THE TOWER FORM AND IS THE FIRST LEVEL OF SERVICED APARTMENTS.

14: FRITTED GLASS REMOVED FROM WEST FACADE.

19: PLANNING ADJUSTMENTS TO SERVICES AT GROUND FLOOR ALONG QUEENS LANE AND THE SOUTHERN LANEWAY.

20: GROUND FLOOR LEVEL RAISED TO REDUCE DIFFERENTIAL TO STREET, AND IMPROVE CLEARANCE FOR CAR PARK RAMP ENTRY.

31: RESIDENTIAL PRIVACY SCREEN DESIGN AND DETAILING UPDATED.

32: FRITTED PRIVACY GLAZING INCLUDED WHERE APARTMENTS OVERLOOK EACH OTHER.

33: PRIVACY SCREENS REMOVED FROM HOTEL LEVELS.

43: LEVELS ON ELEVATIONS UPDATED TO REFER TO AHD.

54: REDUCED NUMBER OF LARGE TREES TO HIGH RISE FACADE PLANTERS AS PER LANDSCAPE DOCUMENTATION.

55: UPDATED CODES, IMAGES AND DESCRIPTIONS OF MATERIALS.

MATERIAL LEGEND

GLA-01 - Clear Glazing Total glass/frame system to achieve thermal performance as required by ESD and facade consultants. Max reflectivity 20%.

GLA-02 - Silver with Low-E coating. Total glass/frame system to achieve thermal performance as required by ESD and facade consultants. Max reflectivity 20%.

GLA-03 - Silver Balustrade Glazing. Total glass/frame system to achieve thermal performance as required by ESD and facade consultants. Max reflectivity 20%.

GLA-04 - Fritted Privacy Glazing. Total glass/frame system to achieve thermal performance as required by ESD and facade consultants. Max reflectivity 20%.

GLA-05 - Balustrade Glazing with Frit. Total glass/frame system to achieve thermal performance as required by ESD and facade consultants. Max reflectivity 20%.

GLF-02 - Custom artwork decal

MTC-01 - Powdercoated solid aluminium clad finish fins.

Matte finish. Colour: TBC

MTC-02 - Powdercoated solid aluminium clad finish panel. Matte finish. Colour: TBC

MTC-03 - Powdercoated solid aluminium cladding. Matte finish. Colour: TBC

MTC-04 - Powdercoated custom perforated aluminium clad finish

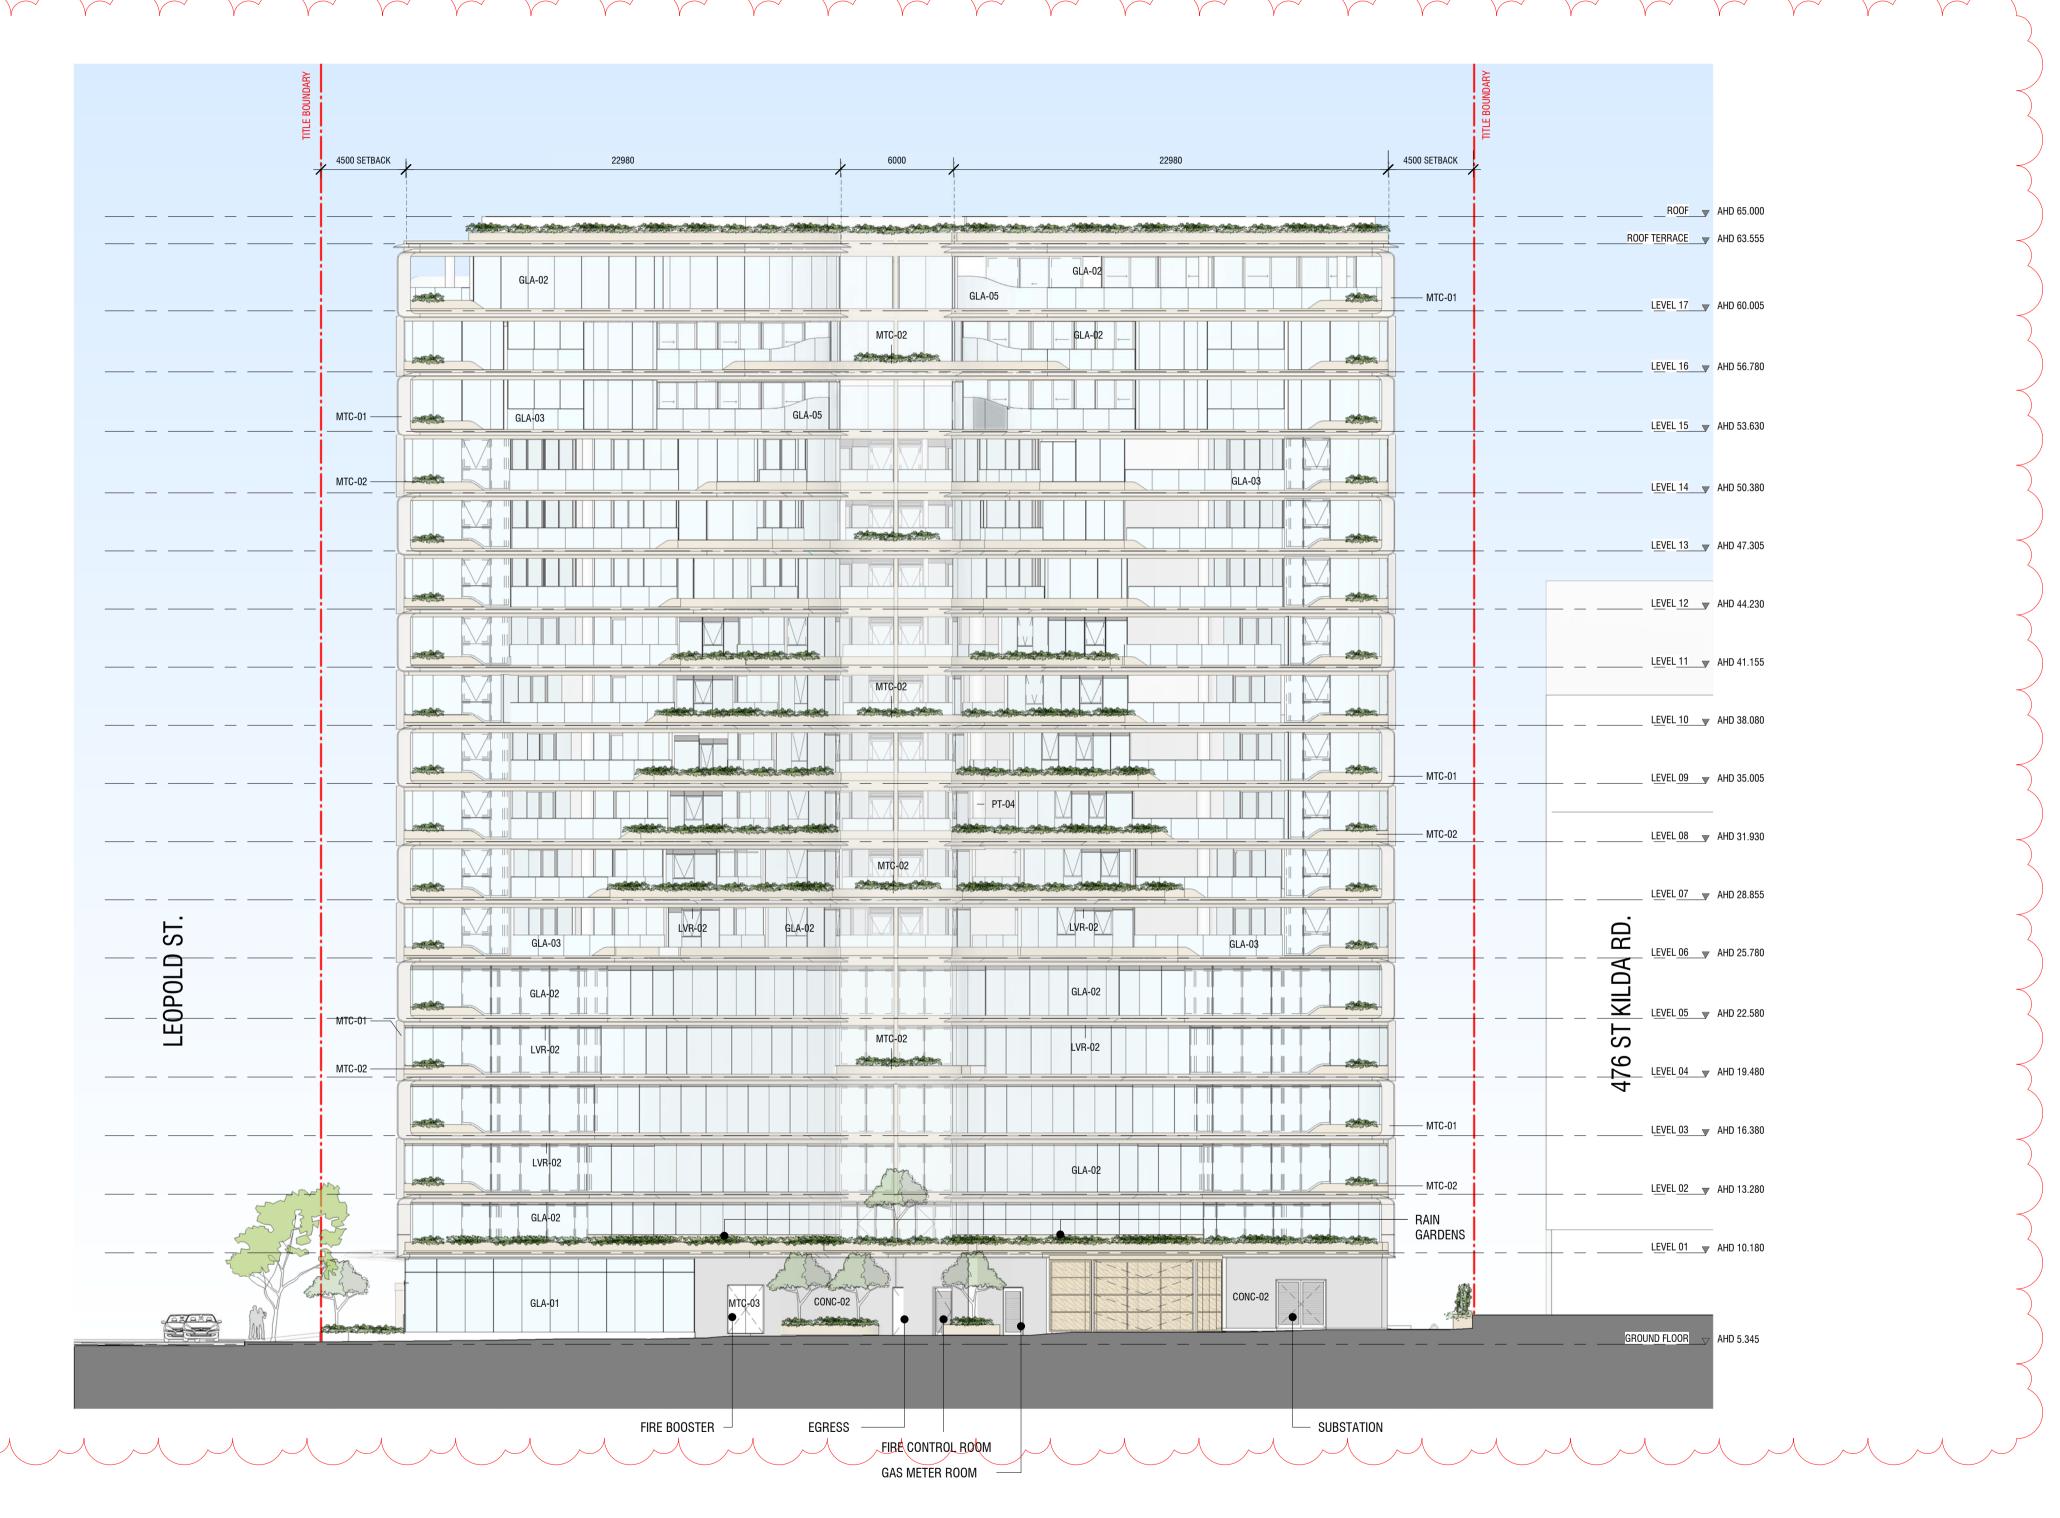
panel. Matte finish. Colour: TBC **LVR-01 -** Vertical louvre screen

LVR-02 - Horizontal mechanical louvres with perforated mesh

CONC-01 - In-situ concrete. Class 2 finish to all exposed faces (smooth cast)

CONC-02 - In-situ concrete wall with vertical ribs **PT-03 -** Exterior paint, Dulux Domino or similar

PT-04 - Exterior paint, Dulux Natural White or similar



City of Port Phillip Advertised Plan

Planning Application No. 1033/2018/A No. of Pages: 26 of 40

WEST ELEVATION SCALE 1:200

472-474 ST KILDA RD

Drawing Title: **WEST ELEVATION**

Drawing Number: **TP-30-04** Revision: Date: 10 17/02/2023

Scale: As indicated @ **A1**

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1: DELETION OF LEVEL 01 PODIUM - LEVEL 01 NOW FORMS PART OF THE TOWER FORM AND IS THE FIRST LEVEL OF SERVICED APARTMENTS.

19: PLANNING ADJUSTMENTS TO SERVICES AT GROUND FLOOR ALONG QUEENS LANE AND THE SOUTHERN LANEWAY.


20: GROUND FLOOR LEVEL RAISED TO REDUCE DIFFERENTIAL TO STREET, AND IMPROVE CLEARANCE FOR CAR PARK RAMP ENTRY.

44: VERTICAL LINE ADDED TO SHOW EXTENSION OF ARCHITECTURAL FEATURES IN RELATION TO SETBACK REQUIREMENTS.

49: RAINGARDENS ADDED ON GROUND FLOOR AND LEVEL 01.

51: WESTERN SETBACK INCREASE NOTED.

City of Port Phillip
Advertised Plan
Planning Application No. 1033/2018/A
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Project:

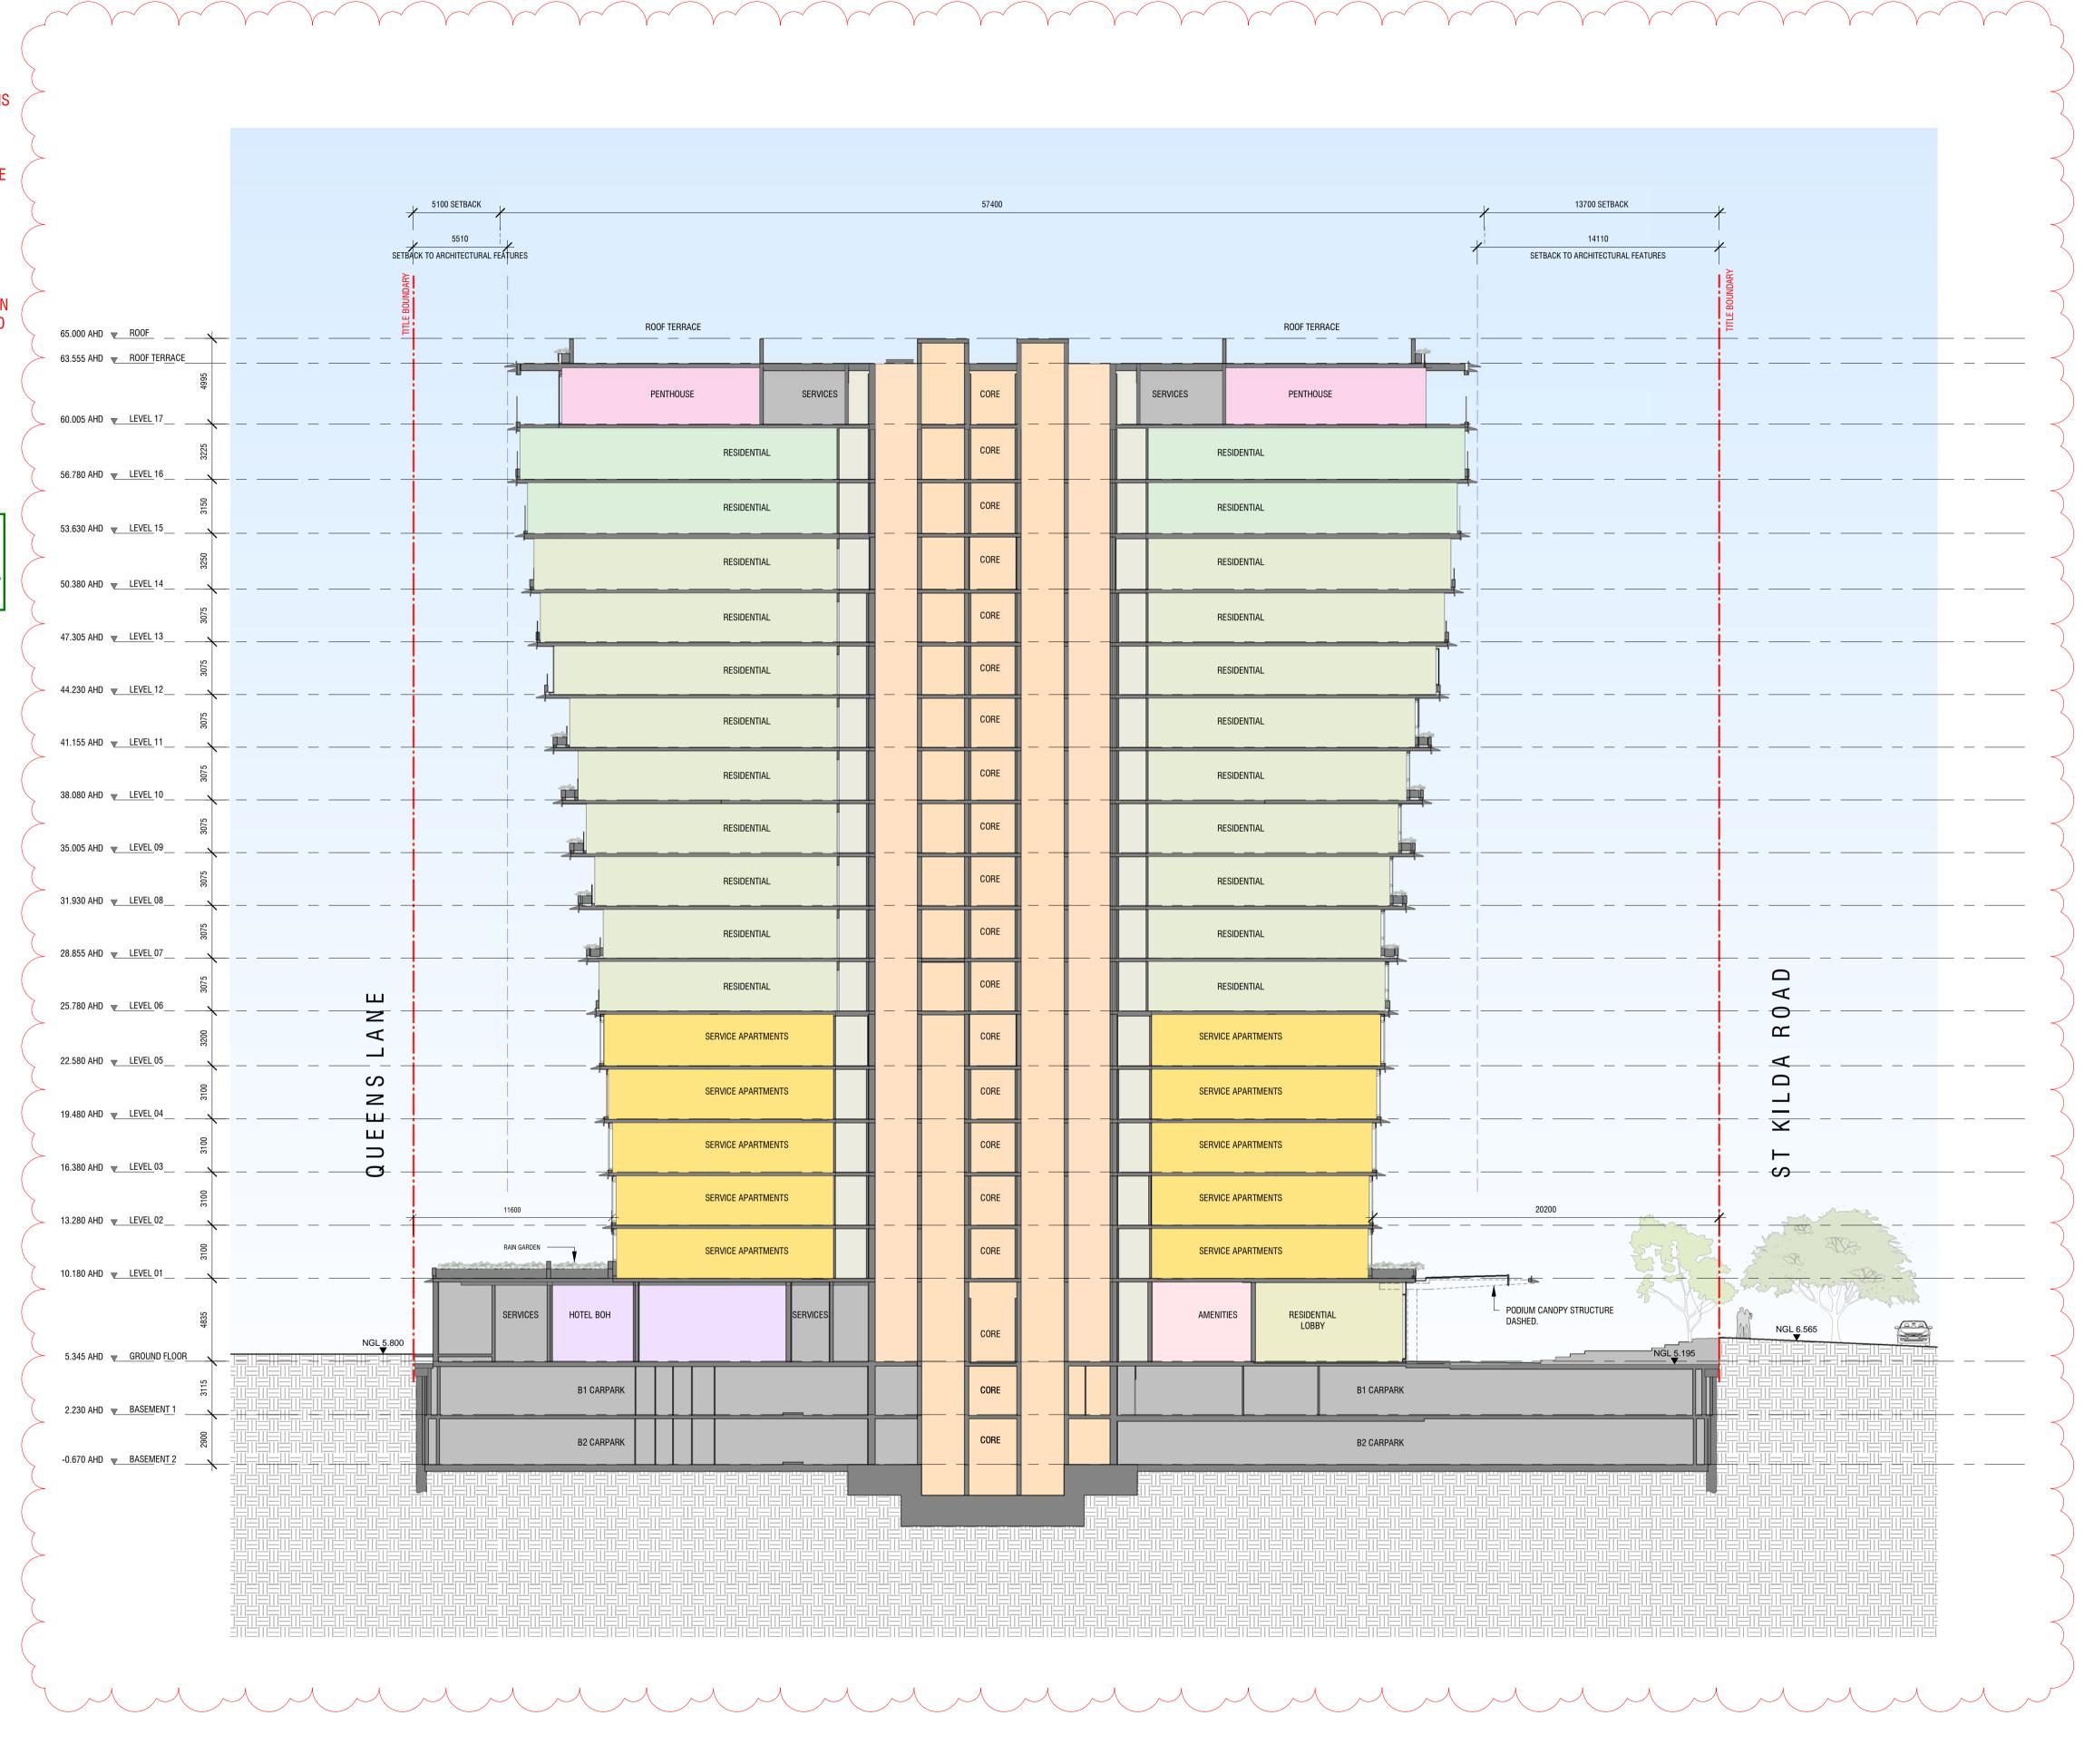472-474 ST KILDA RD

SECTION A-A

TP-40-01

7 17/02/2023

1:200 @ A1

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1: DELETION OF LEVEL 01 PODIUM - LEVEL 01 NOW FORMS PART OF THE TOWER FORM AND IS THE FIRST LEVEL OF SERVICED APARTMENTS.

19: PLANNING ADJUSTMENTS TO SERVICES AT GROUND FLOOR ALONG QUEENS LANE AND THE SOUTHERN LANEWAY.

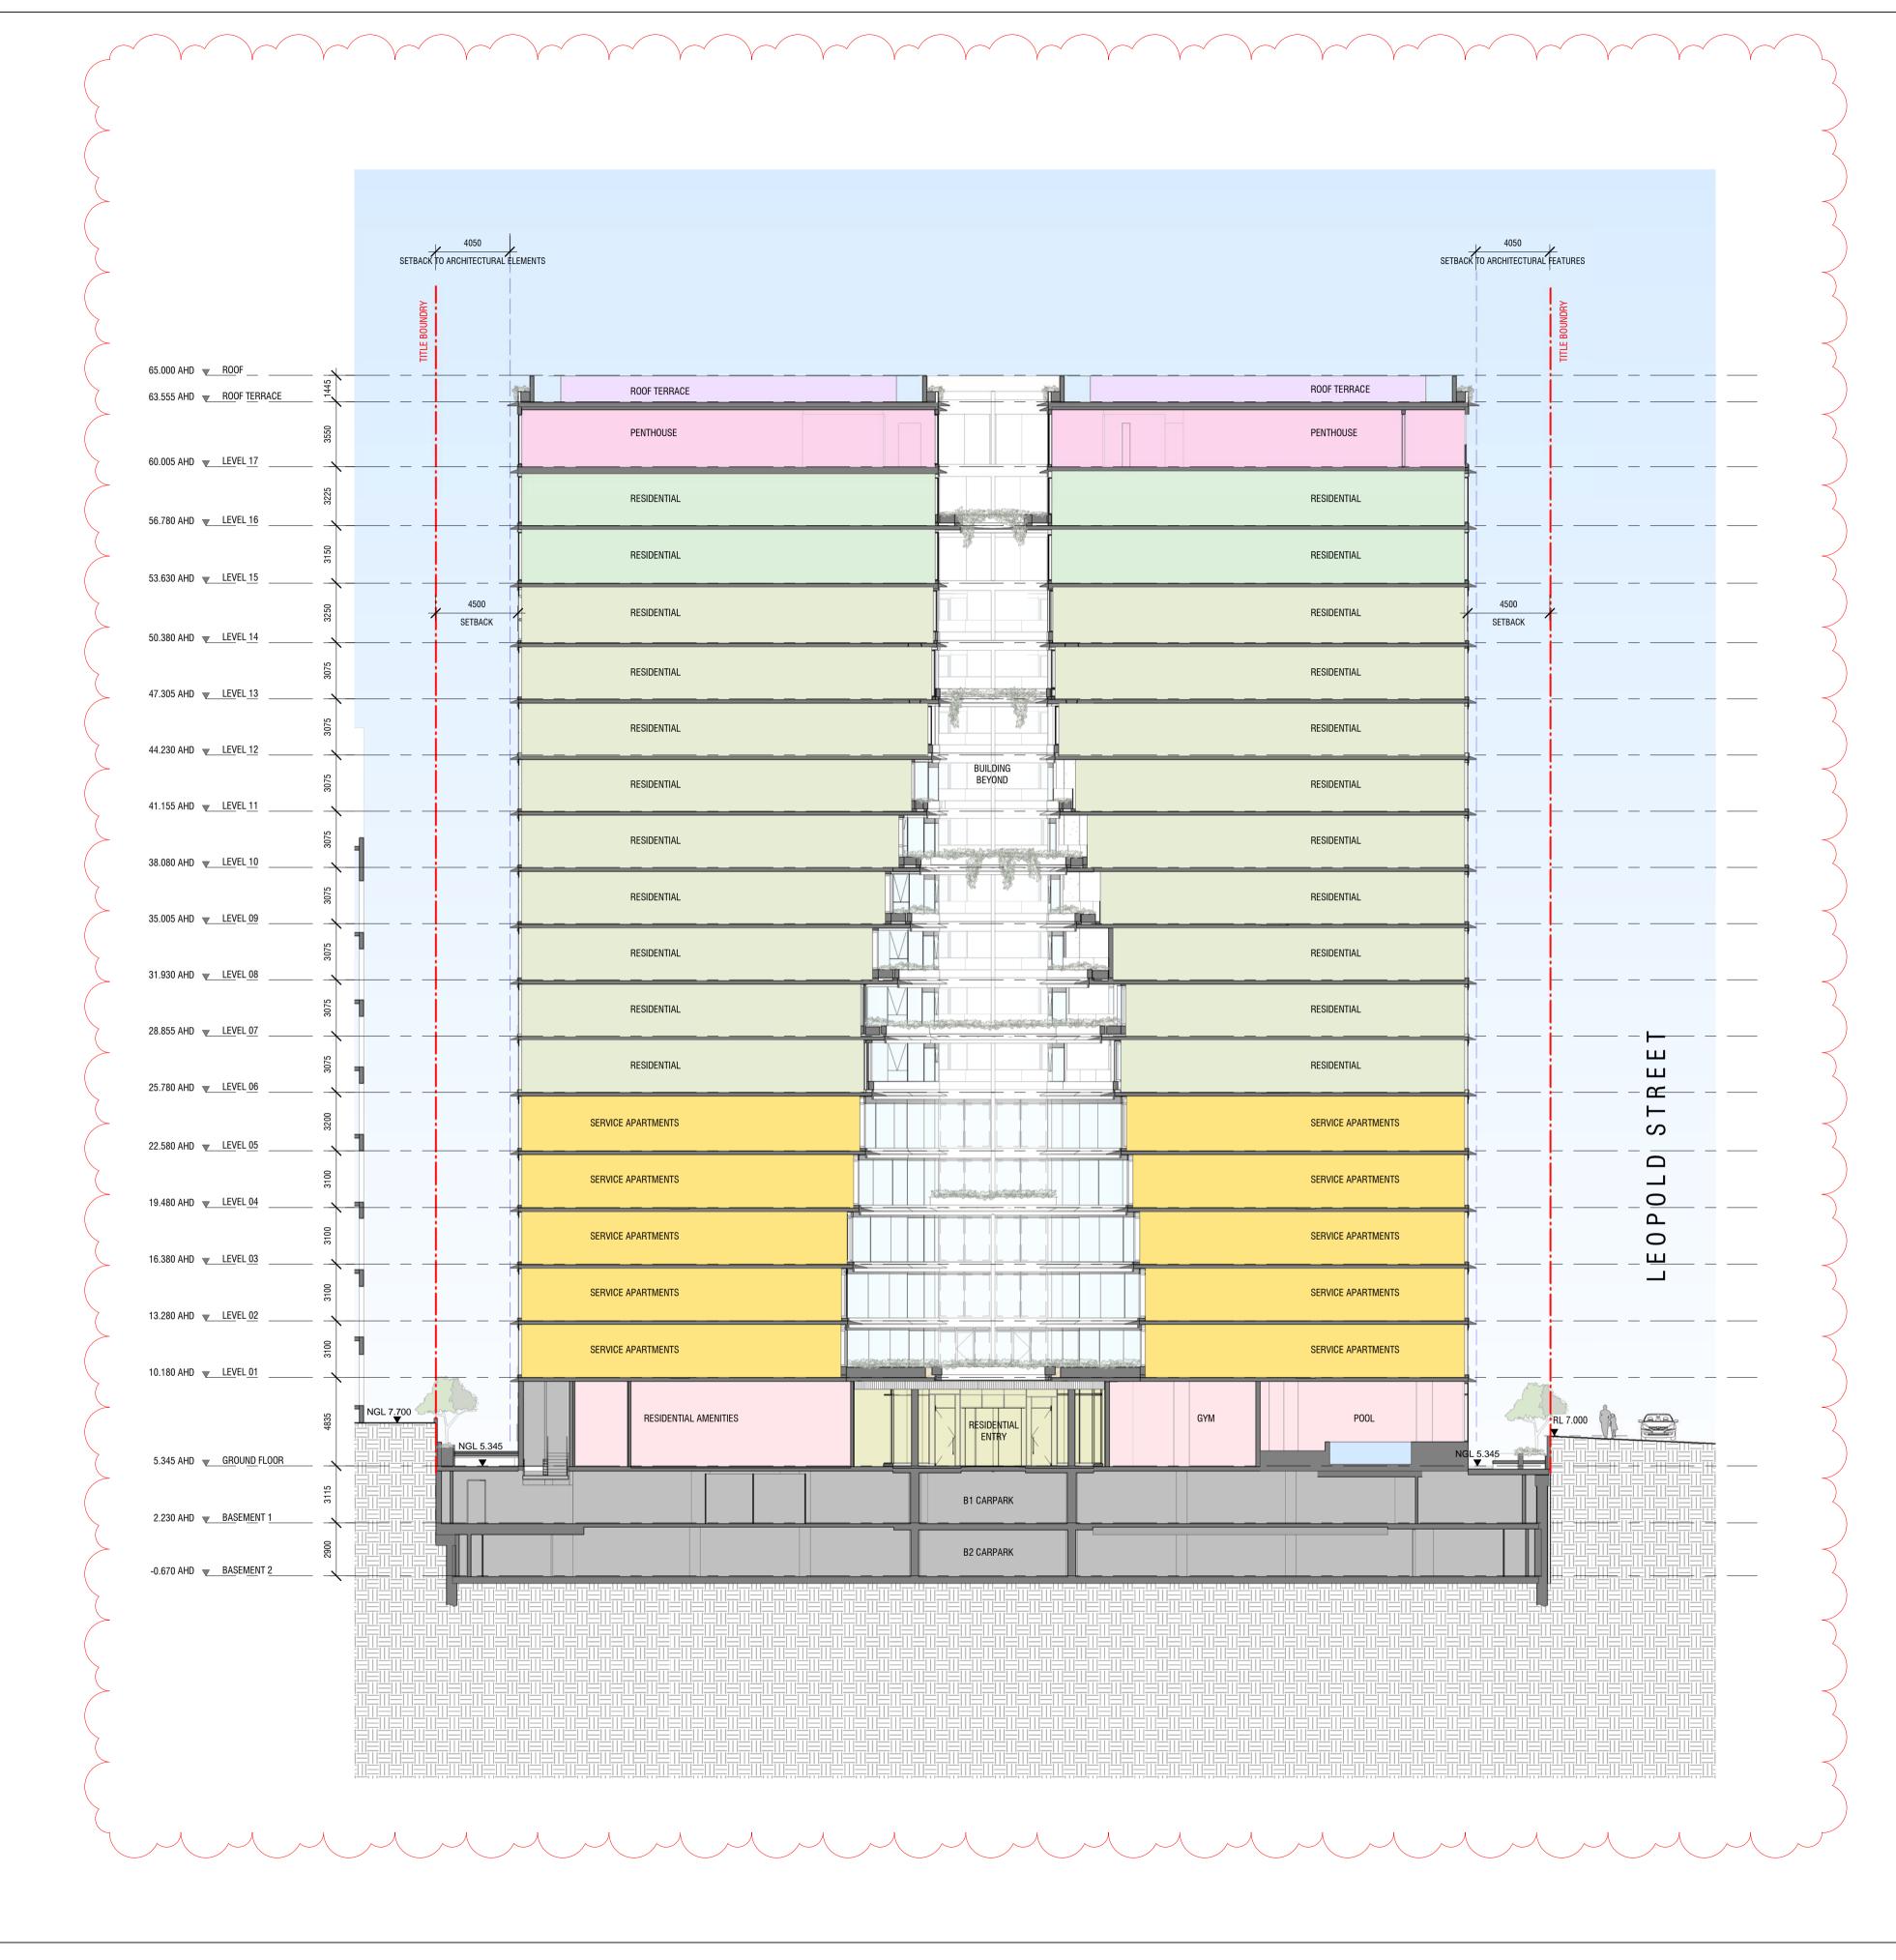
20: GROUND FLOOR LEVEL RAISED TO REDUCE DIFFERENTIAL TO STREET, AND IMPROVE CLEARANCE FOR CAR PARK RAMP ENTRY.

44: VERTICAL LINE ADDED TO SHOW EXTENSION OF ARCHITECTURAL FEATURES IN RELATION TO SETBACK REQUIREMENTS.

49: RAINGARDENS ADDED ON GROUND FLOOR AND LEVEL 01.

51: WESTERN SETBACK INCREASE NOTED.

City of Port Phillip
Advertised Plan
Planning Application No. 1033/2018/A
No. of Pages: 28 of 40



Project:

472-474 ST KILDA RD

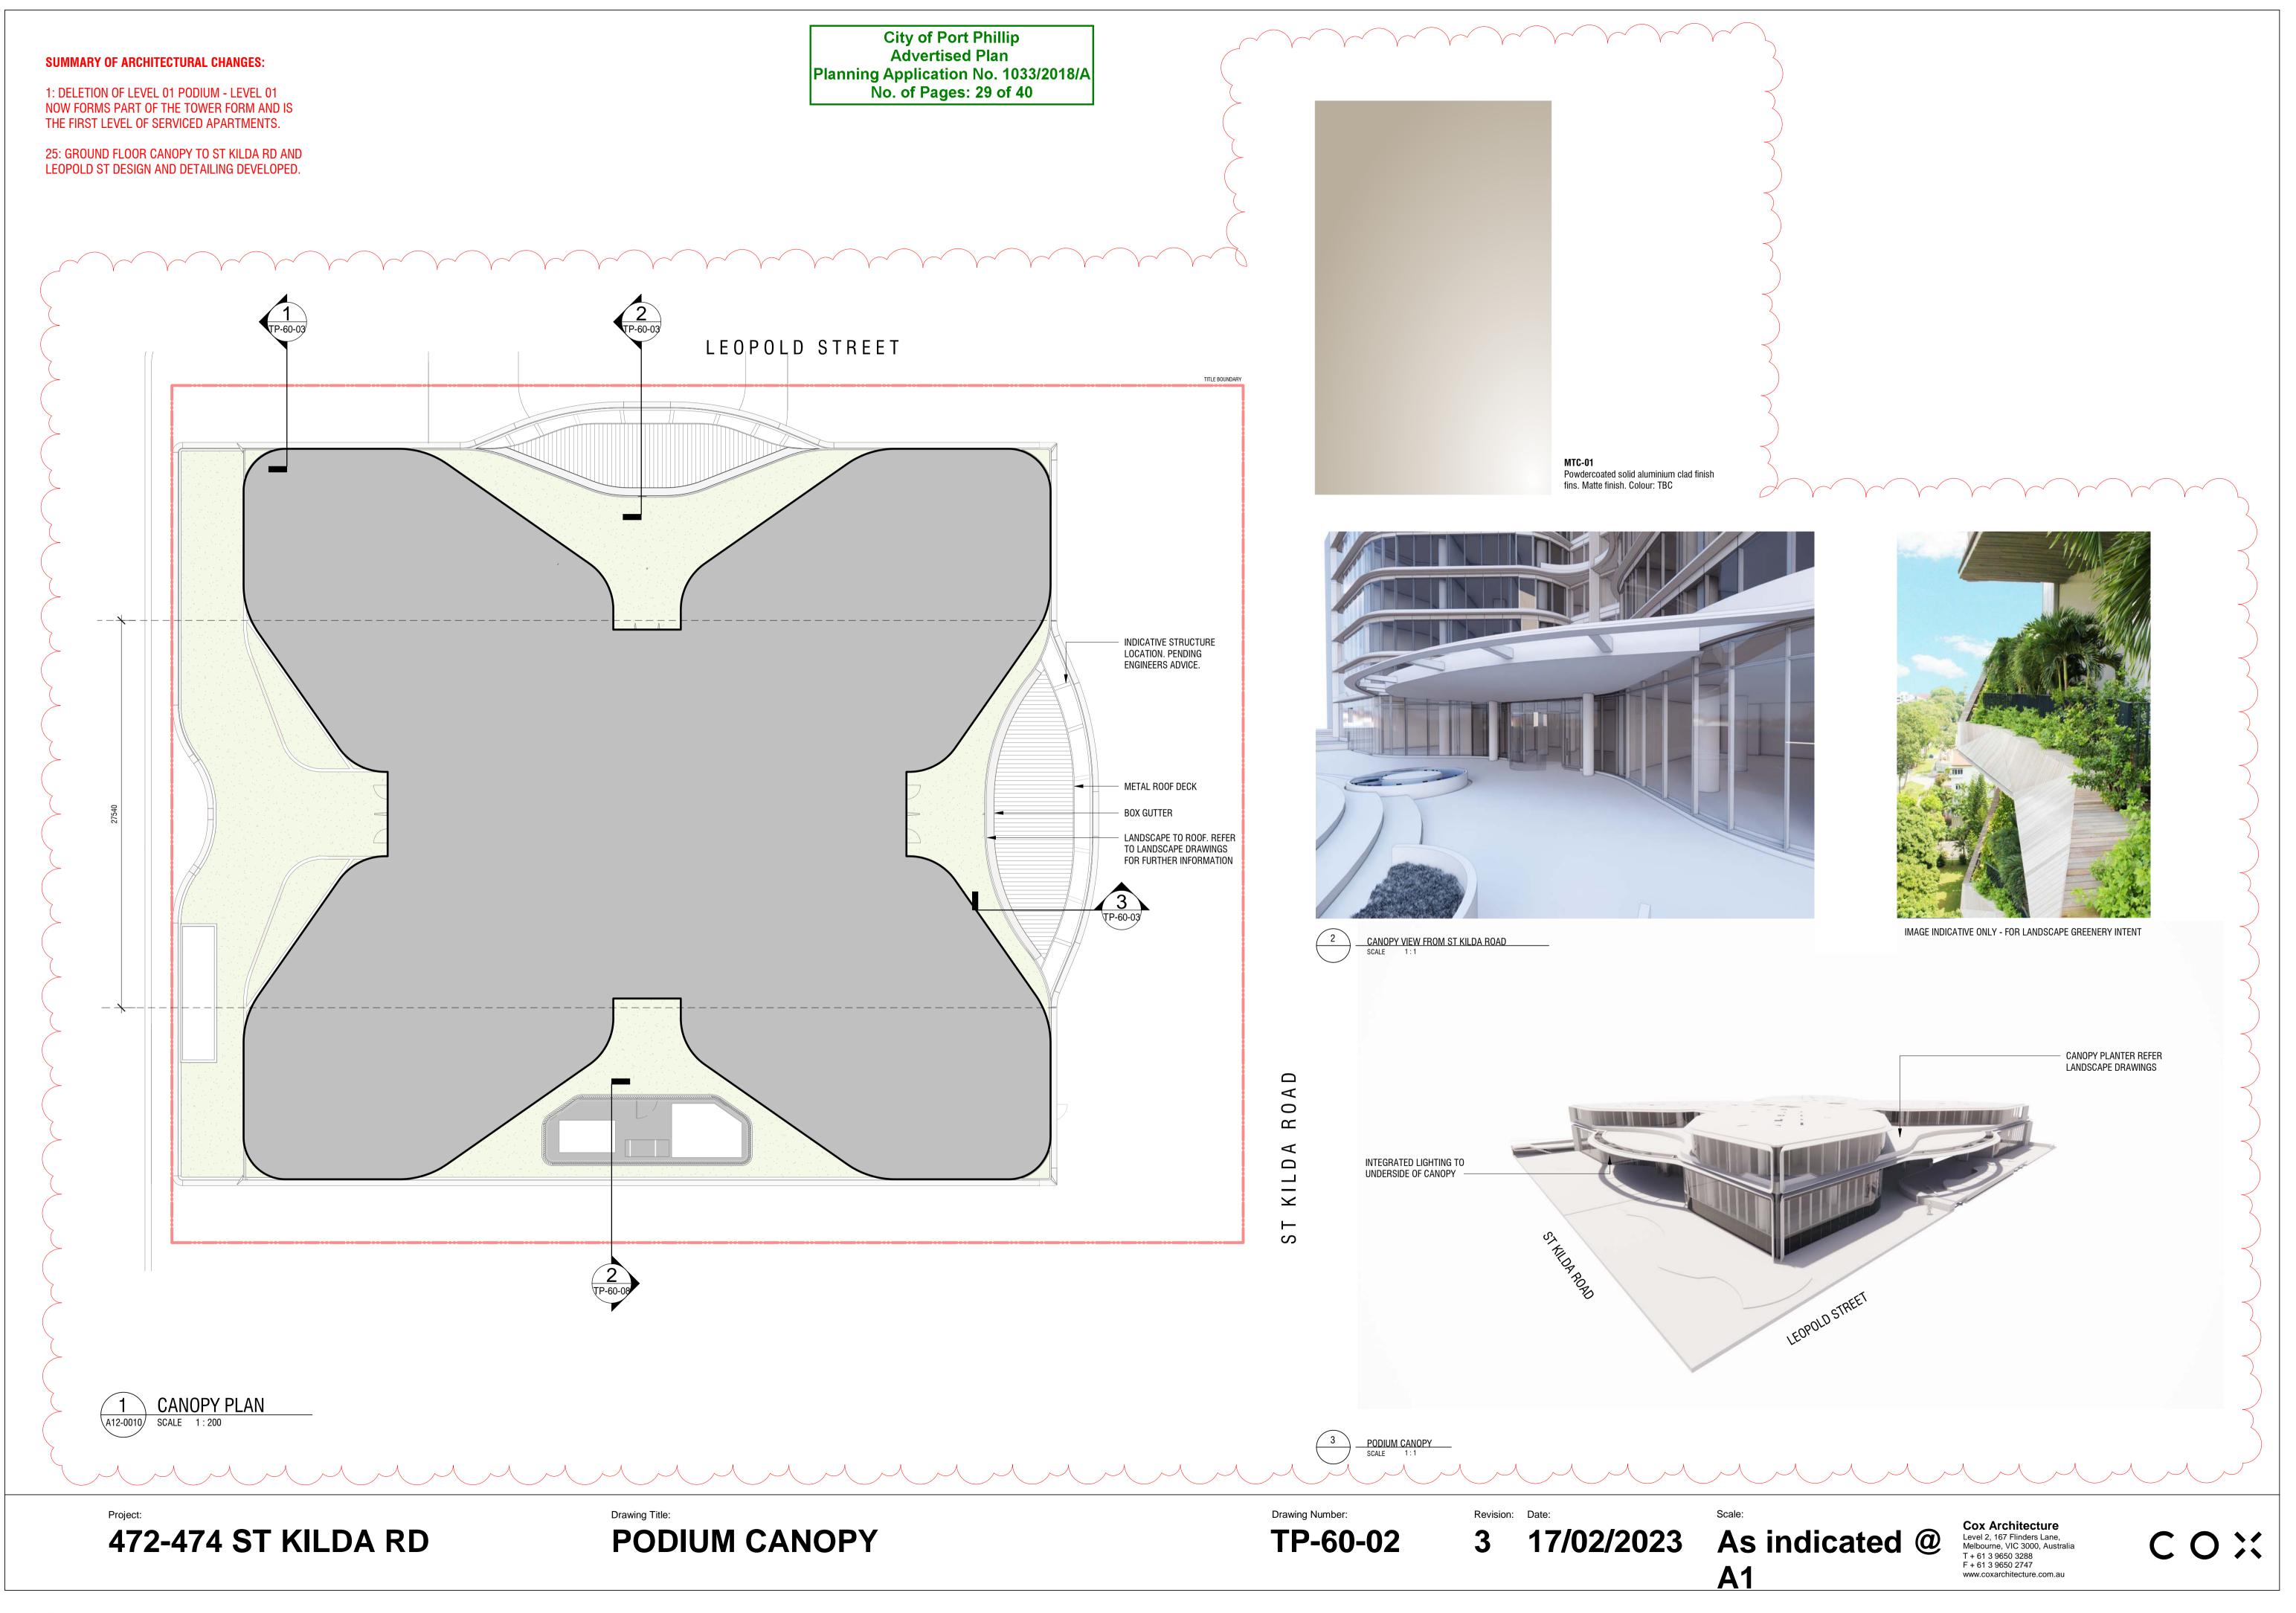
SECTION B-B

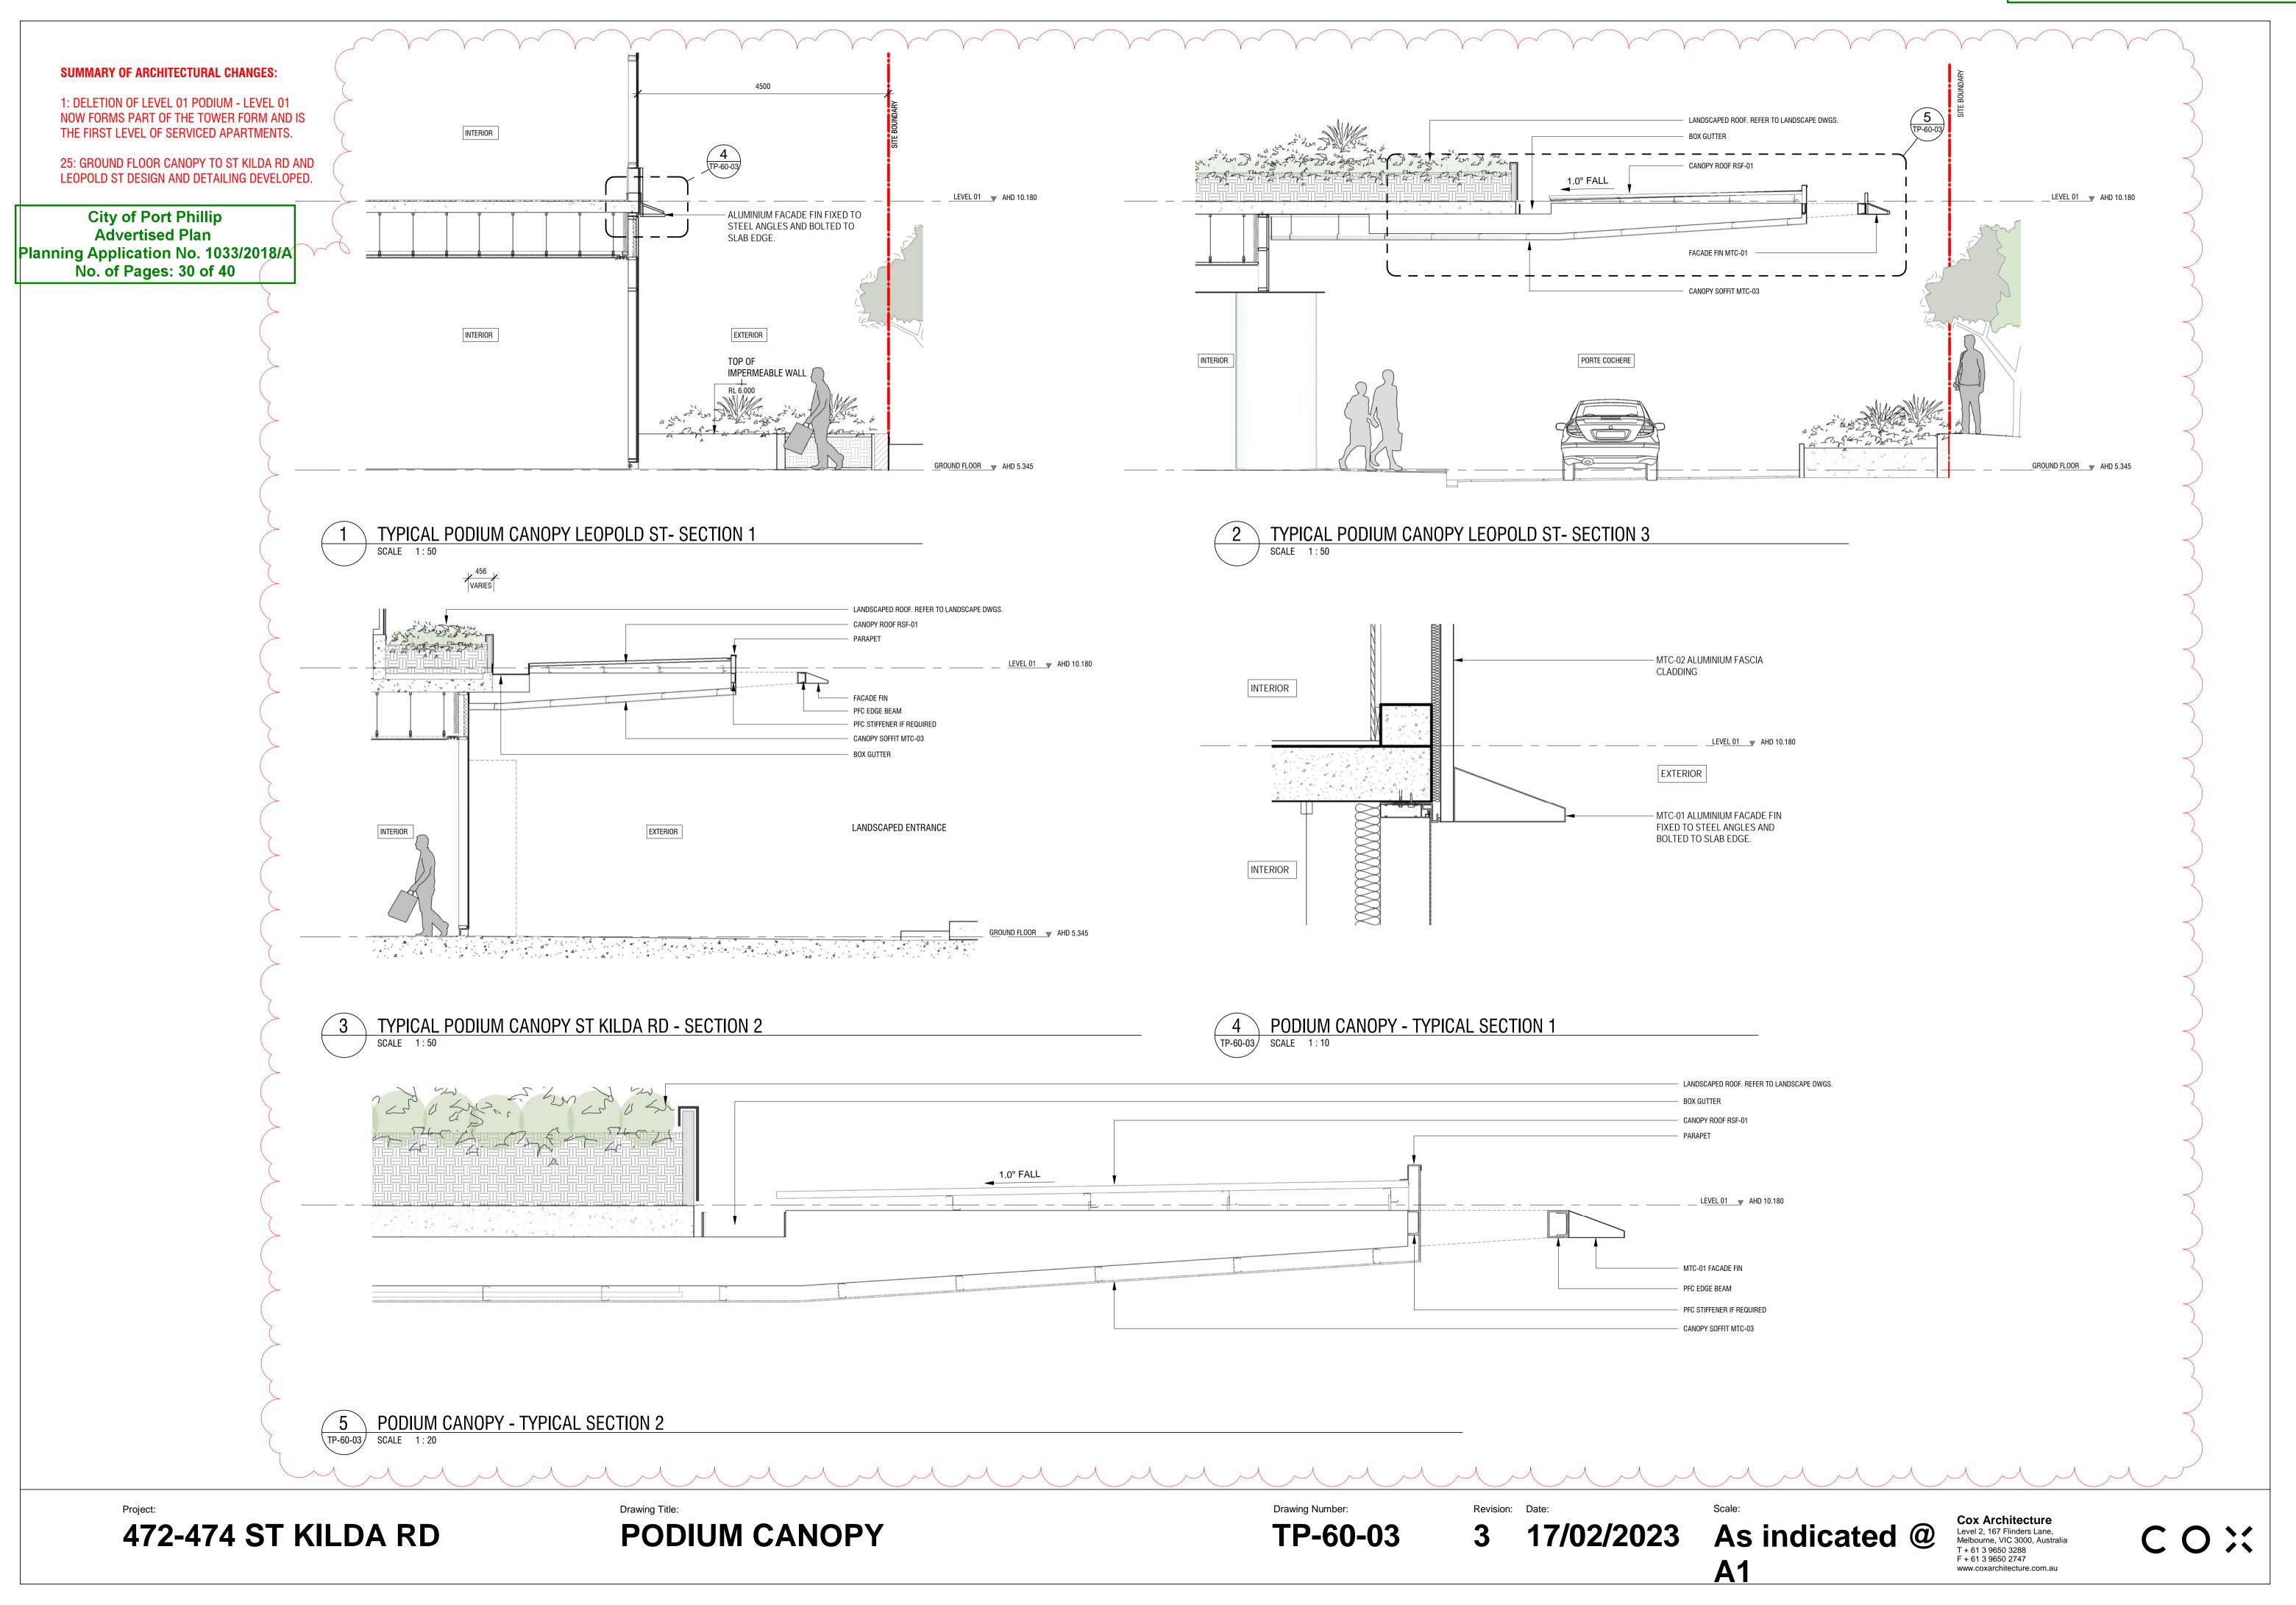
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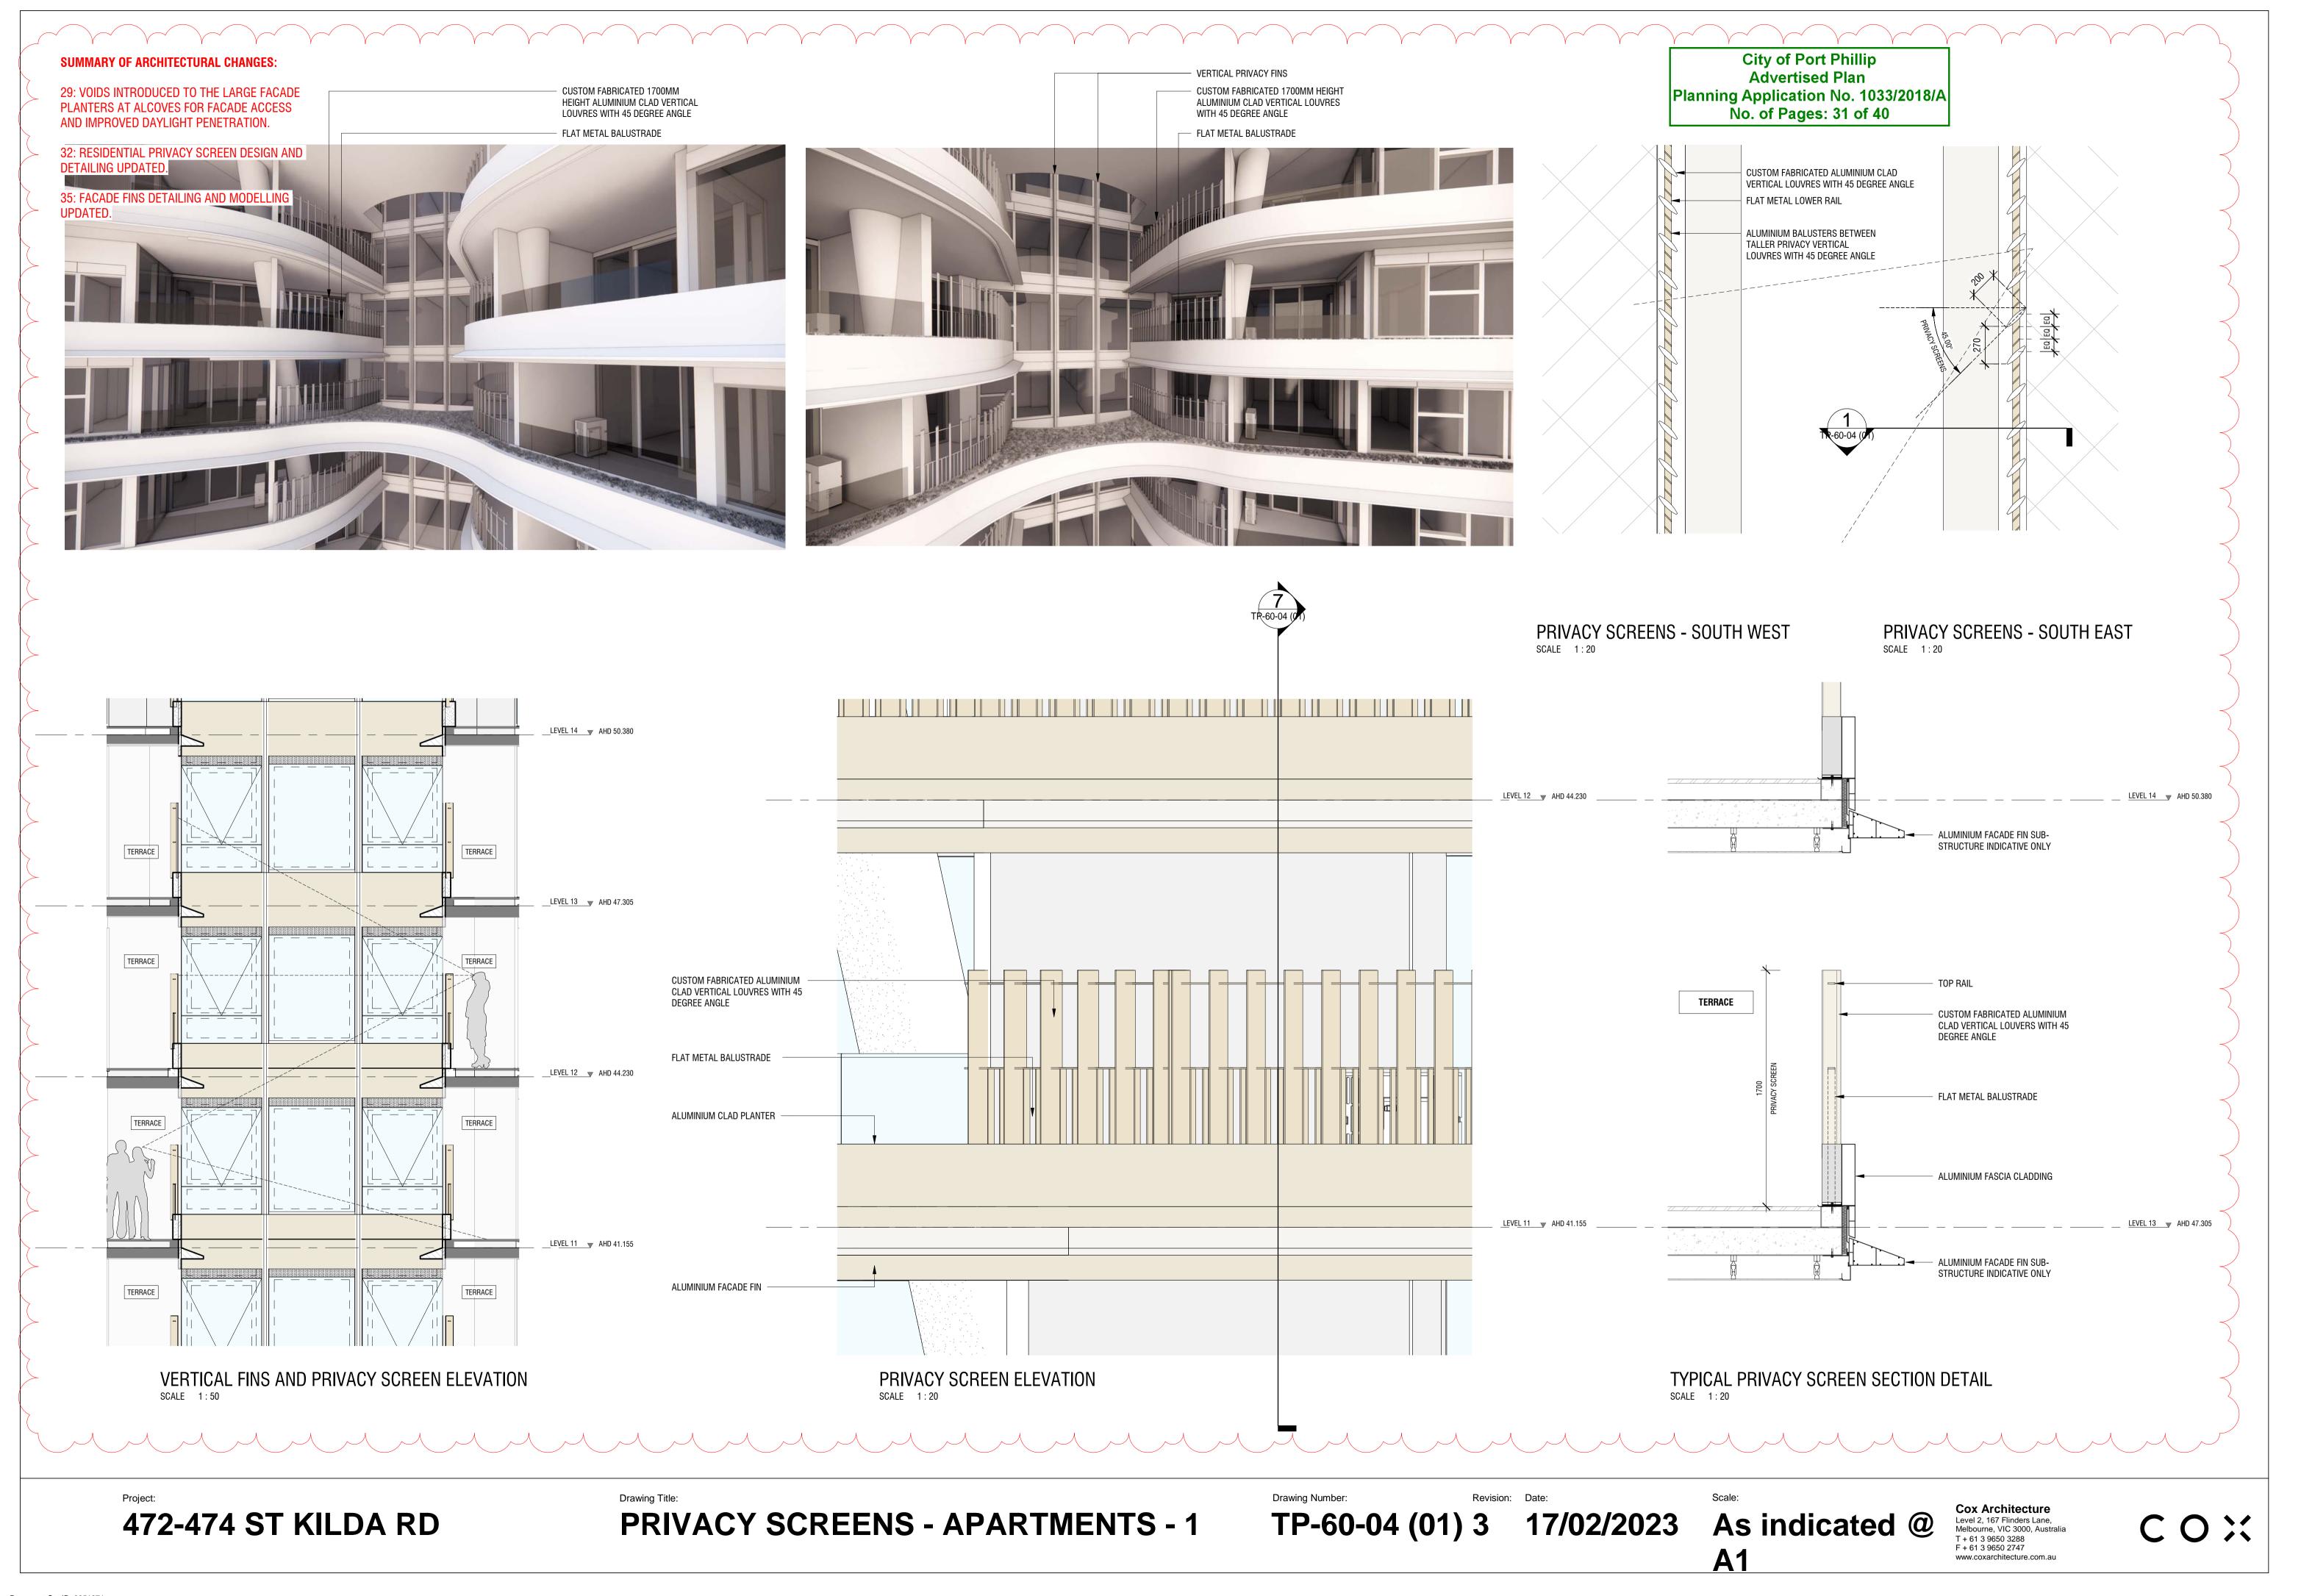
6 17/02/2023

1:200 @ A1

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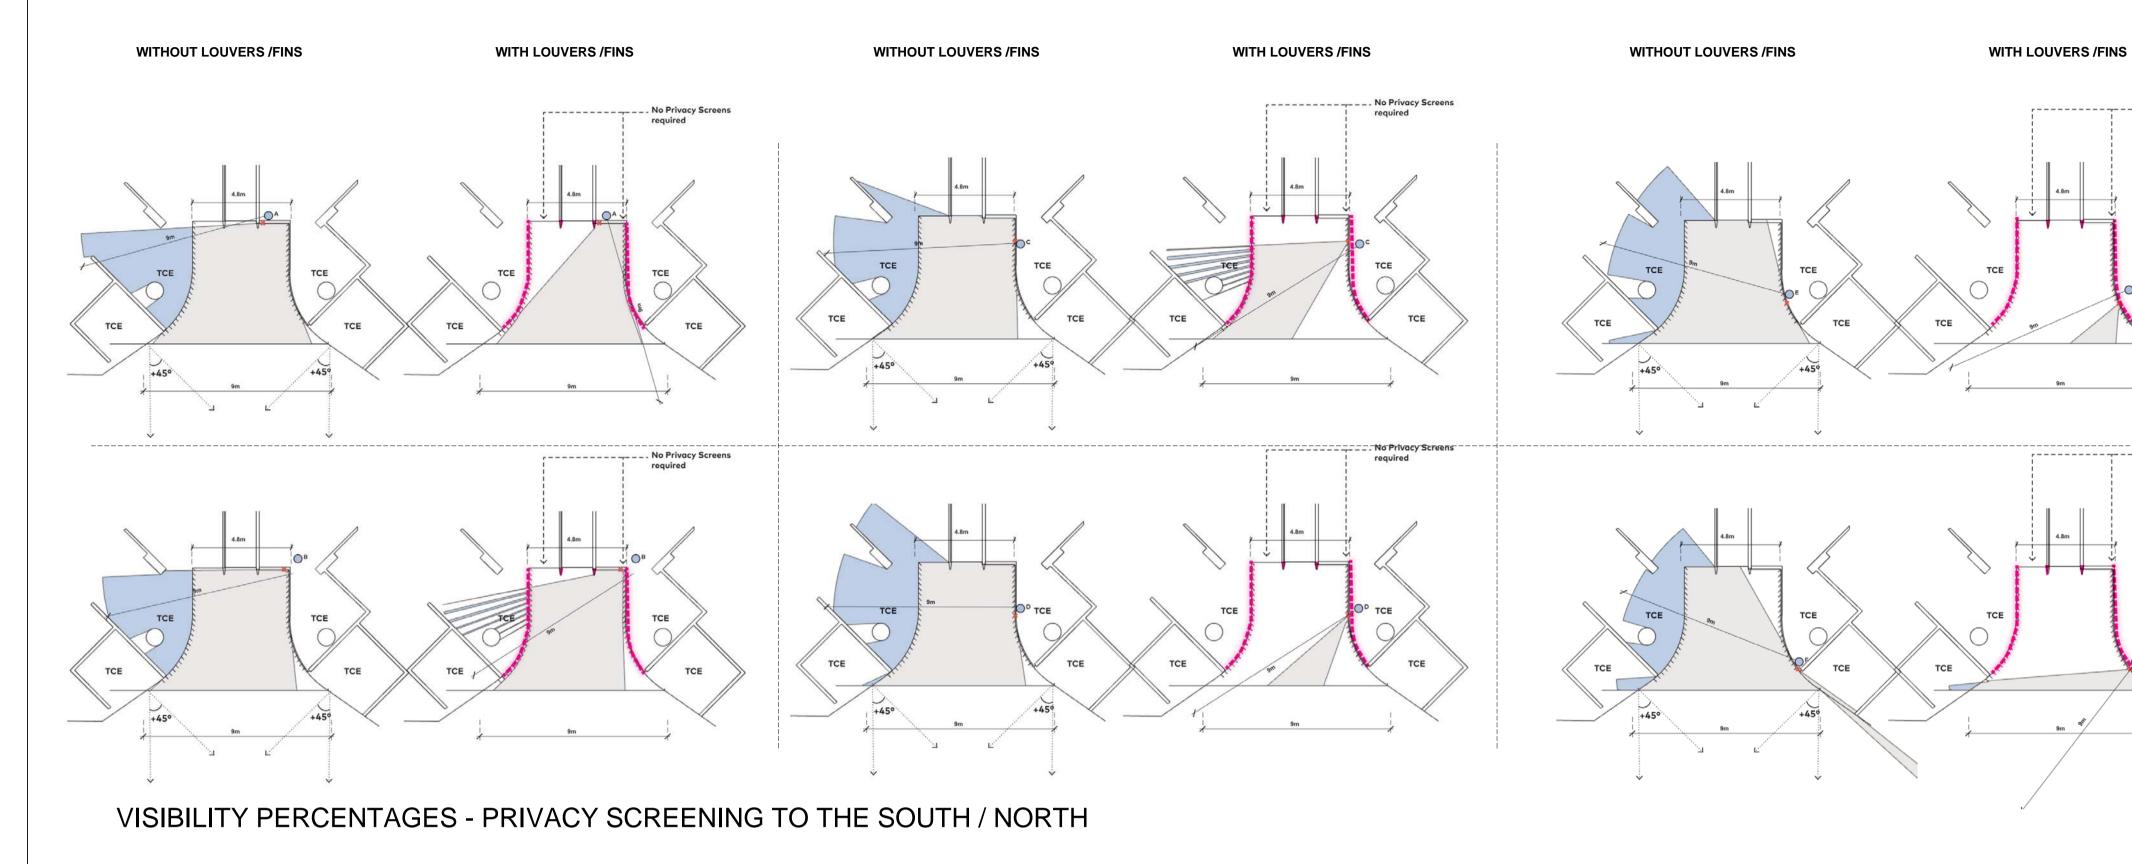






ANALYSIS OF THE EXTENT AND DENSITY OF THE PRIVACY SCREENS TO THE EAST, WEST, NORTH AND SOUTH FAÇADE ELEVATION


City of Port Phillip Advertised Plan Planning Application No. 1033/2018/A No. of Pages: 32 of 40



WITHOUT LOUVERS /FINS



	Step 1 No louvers	Step 2 Two side louvers 0 0% 1.4 9.3%	
A	9.2		
VISIBILITY %	100%		
В	15		
VISIBILITY %	100%		
С	18	2	
VISIBILITY %	100%	25%	
D	21	0	
VISIBILITY %	100%	0%	
E	21	0	
VISIBILITY %	100%	0%	
F	15	0.3	
VISIBILITY %	100%	0%	

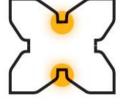



	Step 1 No louvers		Step 2 Two side louvers	
	APT. 03	APT. 04	APT. 03	APT. 0
A	0.5	7.5	0	0.5
VISIBILITY %	100%		0%	
В	2.3	8	0	0
VISIBILITY %	100%	100%	0%	
С	5	8	0.5	0.4
VISIBILITY %	100%	100%	10%	5%
D	0	0.5	0	0
VISIBILITY %	100%	100%	0%	0%
E	0	8	0	0.2
VISIBILITY %	100%	100%	0%	2.5%
F	0	8.8	0	0
VISIBILITY %	100%	100%	0%	0%



■■ IFritted Glass Full height

32: RESIDENTIAL PRIVACY SCREEN DESIGN AND DETAILING UPDATED.

WITHOUT LOUVERS /FINS

WITH LOUVERS /FINS

VISIBILITY PERCENTAGES - PRIVACY SCREENING TO THE EAST / WEST

472-474 ST KILDA RD

PRIVACY SCREENS - APARTMENTS - 2

WITH LOUVERS /FINS

Drawing Number:

WITHOUT LOUVERS /FINS

TP-60-04 (02) 2 17/02/2023

WITH LOUVERS /FINS

@ A1

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55: UPDATED CODES, IMAGES AND DESCRIPTIONS OF MATERIALS

City of Port Phillip
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No. of Pages: 33 of 40



GLA-01 Clear Glazing Total glass/frame system to achieve thermal performance as required by ESD and Facade consultants. Max reflectivity 20%



GLA-02
Silver with Low-E coating.
Total glass/frame system to achieve thermal performance as required by ESD and Facade consultants. Max reflectivity 20%

Total glass/frame system to achieve thermal

performance as required by ESD and Facade

Silver balustrade glazing.

consultants. Max reflectivity 20%.



Total glass/frame system to achieve thermal

performance as required by ESD and facade

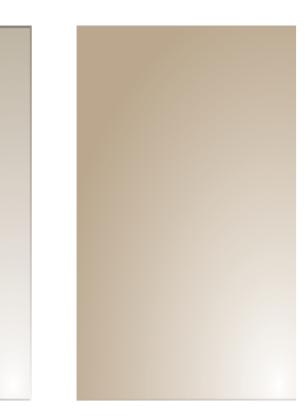
consultants. Max reflectivity 20%. With

custom frit pattern.



GLF-02
Custom Artwork Decal

Powdercoated solid aluminium clad finish fins. Matte finish. Colour: TBC



MTC-02
Powdercoated solid aluminium clad finish panel. Matte finish. Colour: TBC



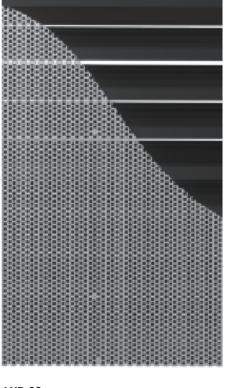
MTC-03
Powdercoated solid aluminium cladding.
Matte finish. Colour: TBC




MTC-04
Powdercoated custom perforated aluminium clad finish panel. Matte finish. Colour: TBC




LVR-01Vertical louvre screen.



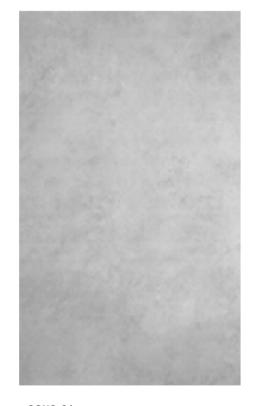LVR-02
Horizontal mechanical louvres with perforated mesh.




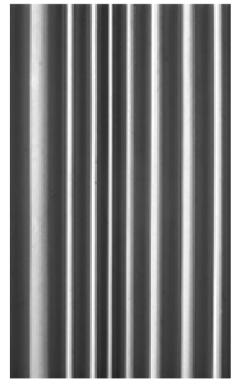CONC-01
In-situ concrete. Class 2 finish to all exposed faces (smooth cast)



CONC-02
In-situ concrete wall with vertical ribs.

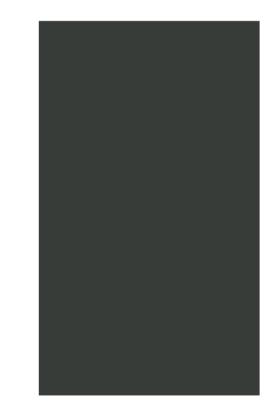PT-04
Exterior Paint
Dulux Natural White or similar



PT-03 Exterior Paint Dulux Domino or similar

MATERIAL LEGEND

GLA-01 - Clear Glazing Total glass/frame system to achieve thermal performance as required by ESD and facade consultants. Max reflectivity 20%.

GLA-02 - Silver with Low-E coating. Total glass/frame system to achieve thermal performance as required by ESD and facade consultants. Max reflectivity 20%.

GLA-03 - Silver Balustrade Glazing. Total glass/frame system to achieve thermal performance as required by ESD and facade consultants. Max reflectivity 20%.

GLA-04 - Fritted Privacy Glazing. Total glass/frame system to achieve thermal performance as required by ESD and facade consultants. Max reflectivity 20%.

GLA-05 - Balustrade Glazing with Frit. Total glass/frame system to achieve thermal performance as required by ESD and facade consultants. Max reflectivity 20%.

GLF-02 - Custom artwork decal

MTC-01 - Powdercoated solid aluminium clad finish fins.

Matte finish. Colour: TBC

MTC-02 - Powdercoated solid aluminium clad finish panel.

Matte finish. Colour: TBC

MTC-03 - Powdercoated solid aluminium cladding.

Matte finish. Colour: TBC

MTC-04 - Powdercoated custom perforated aluminium clad finish panel. Matte finish. Colour: TBC

LVR-01 - Vertical louvre screen

LVR-02 - Horizontal mechanical louvres with perforated mesh CONC-01 - In-situ concrete. Class 2 finish to all exposed faces (smooth cast)

CONC-02 - În-situ concrete wall with vertical ribs
PT-03 - Exterior paint, Dulux Domino or similar
PT-04 - Exterior paint, Dulux Natural White or similar

Project:

472-474 ST KILDA RD

Drawing Title:

MATERIAL SCHEDULE

Drawing Number:

TP-60-07

Revision: Date:

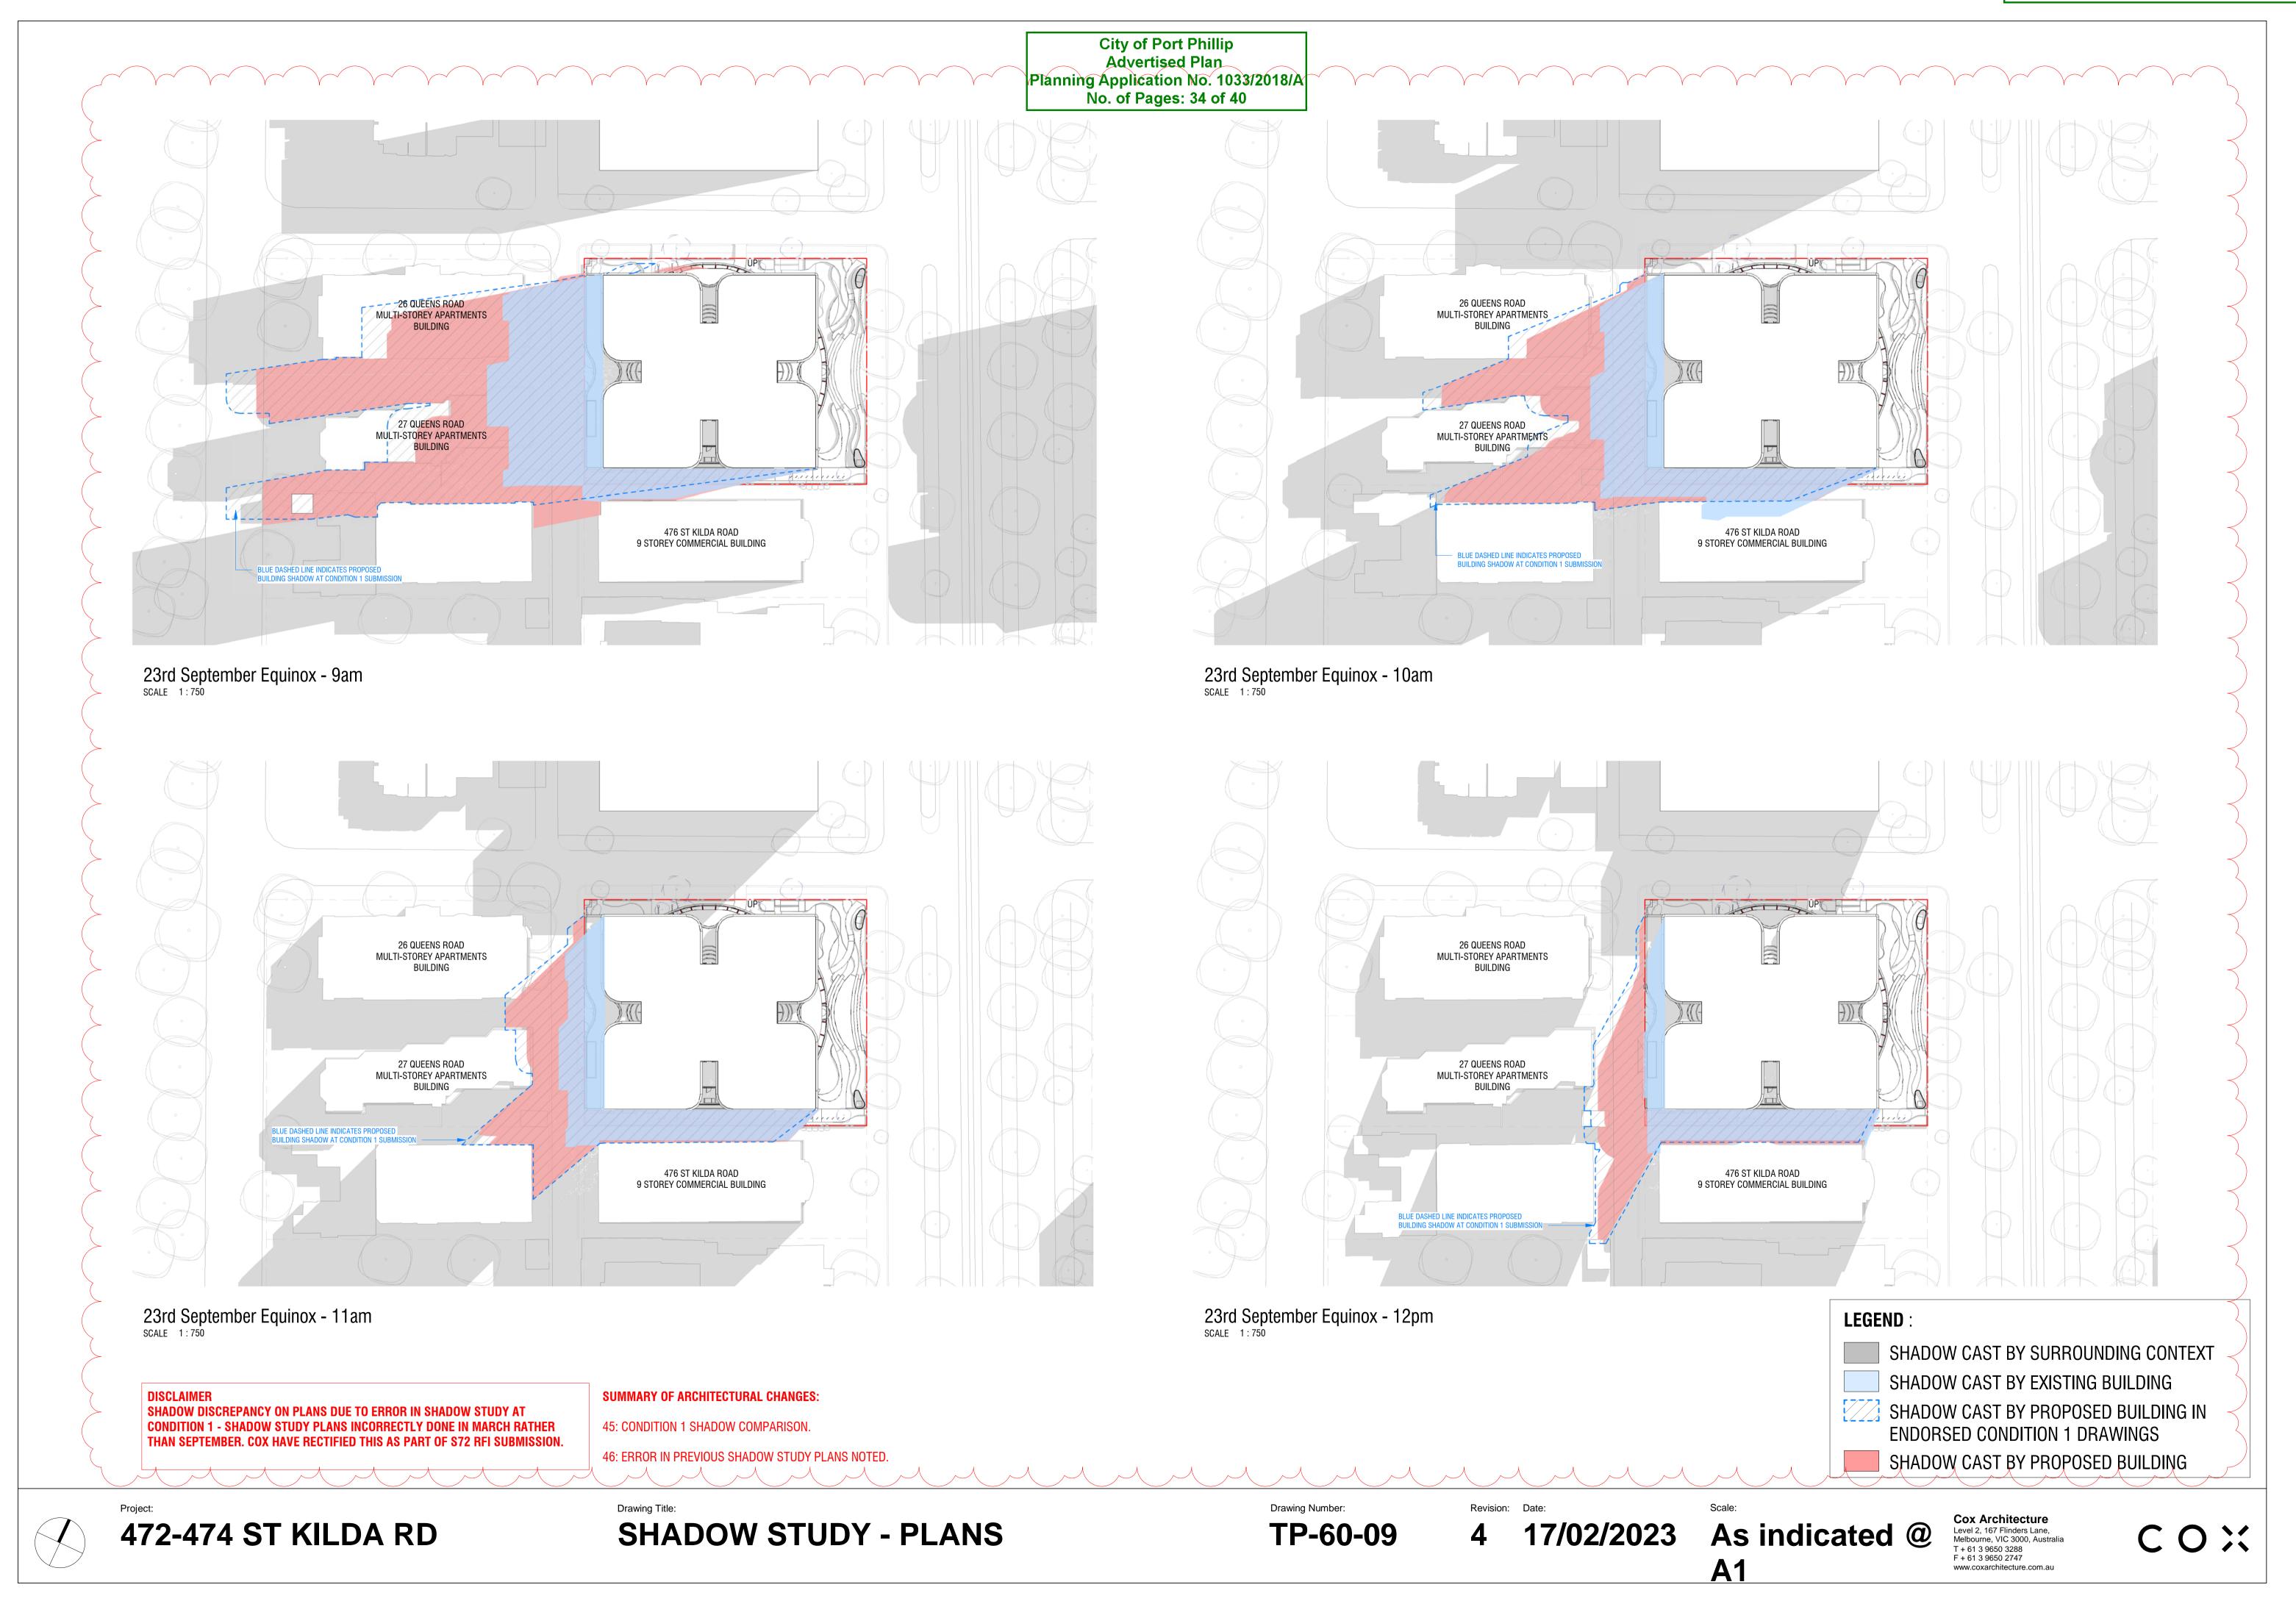
17/02/2023

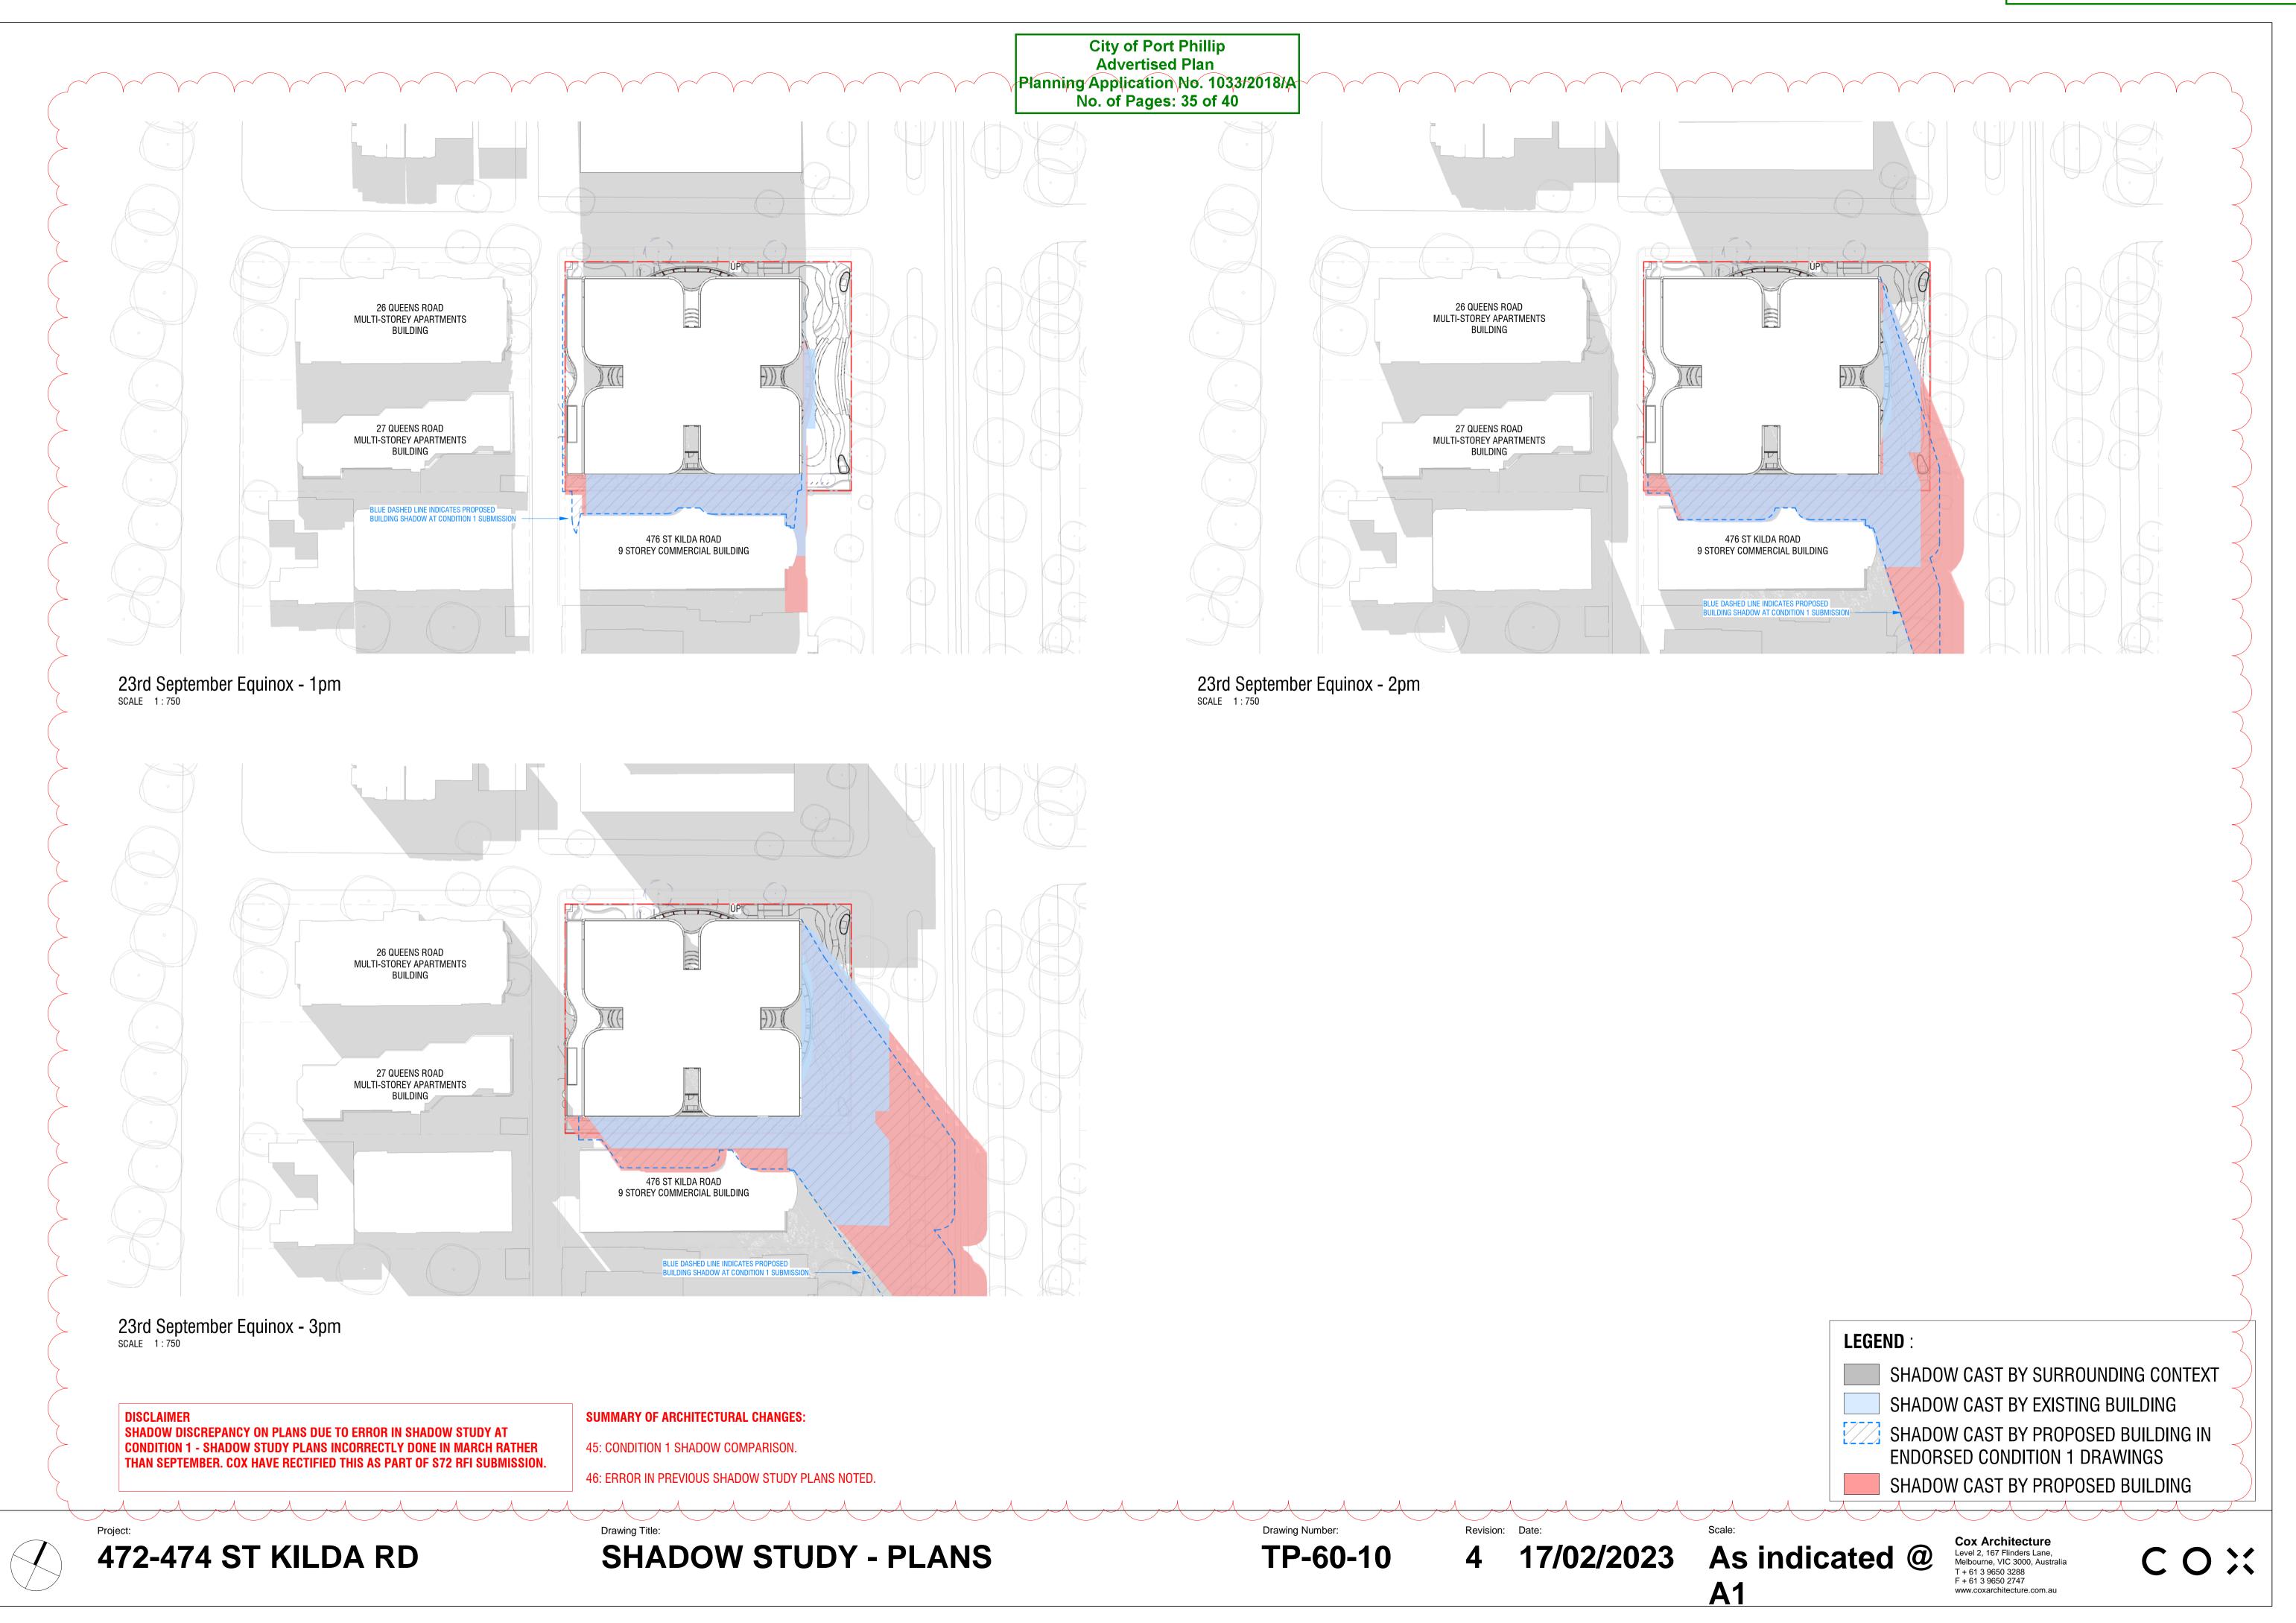
1:1@A

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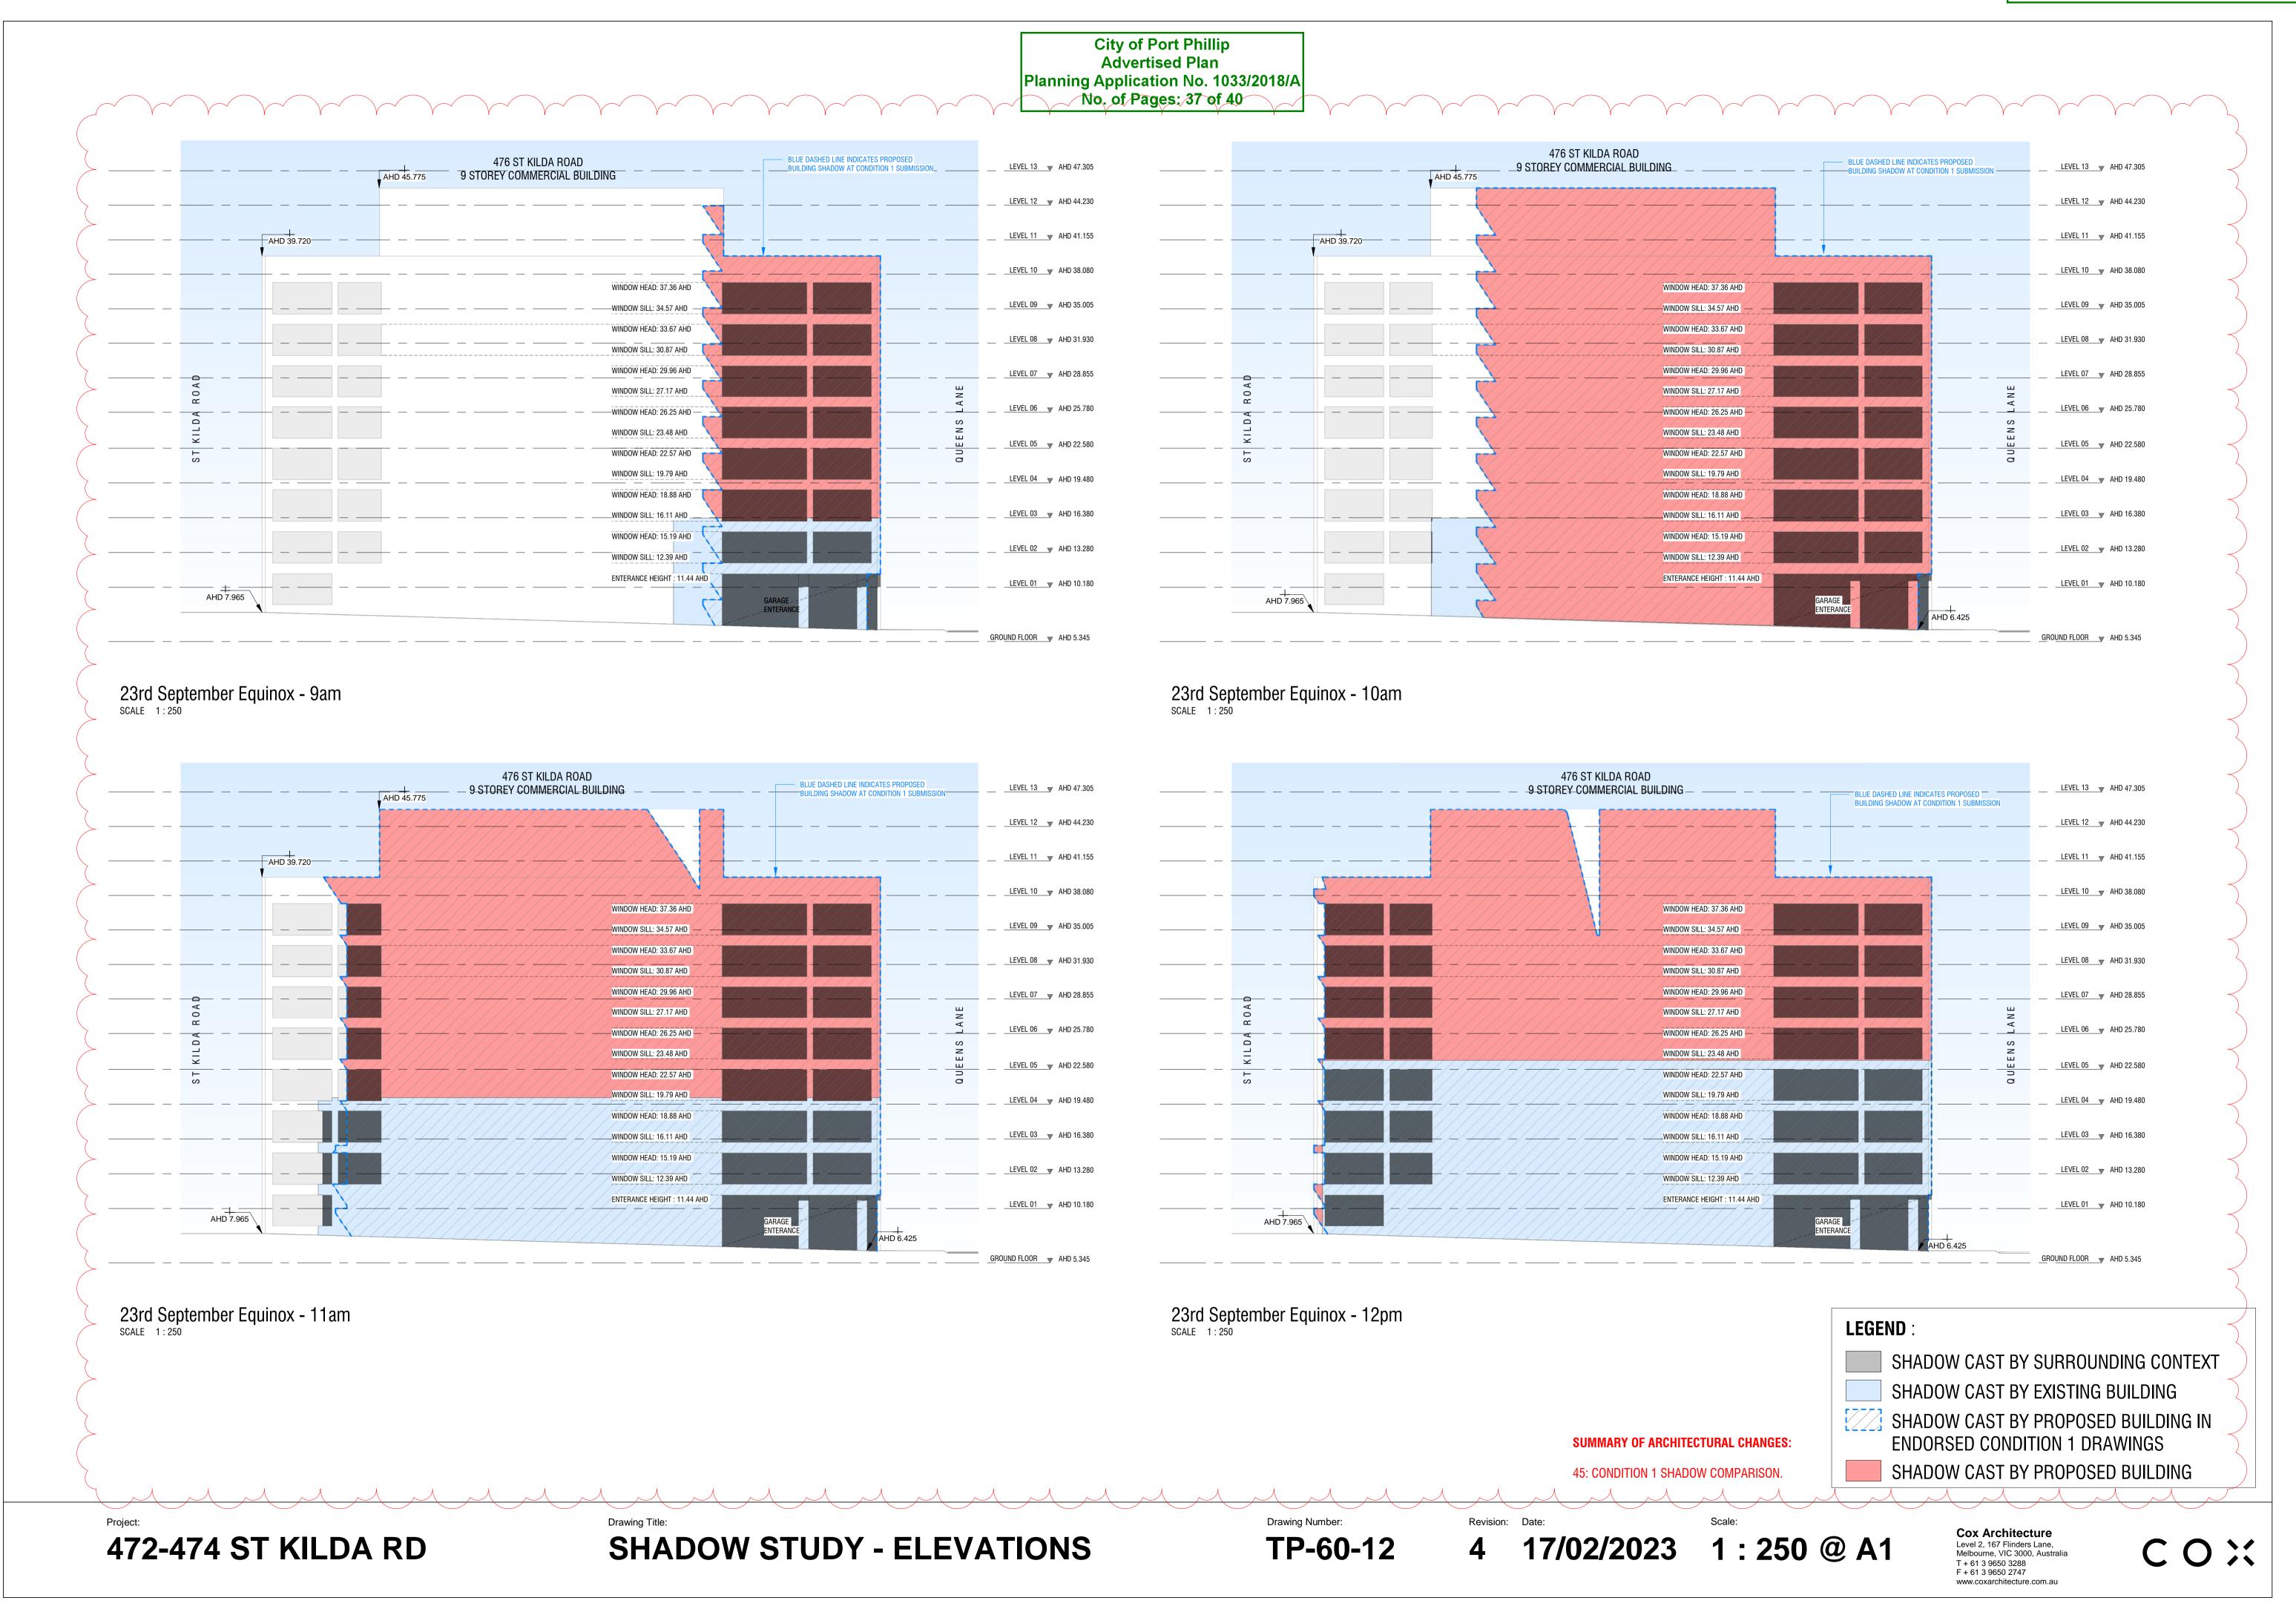
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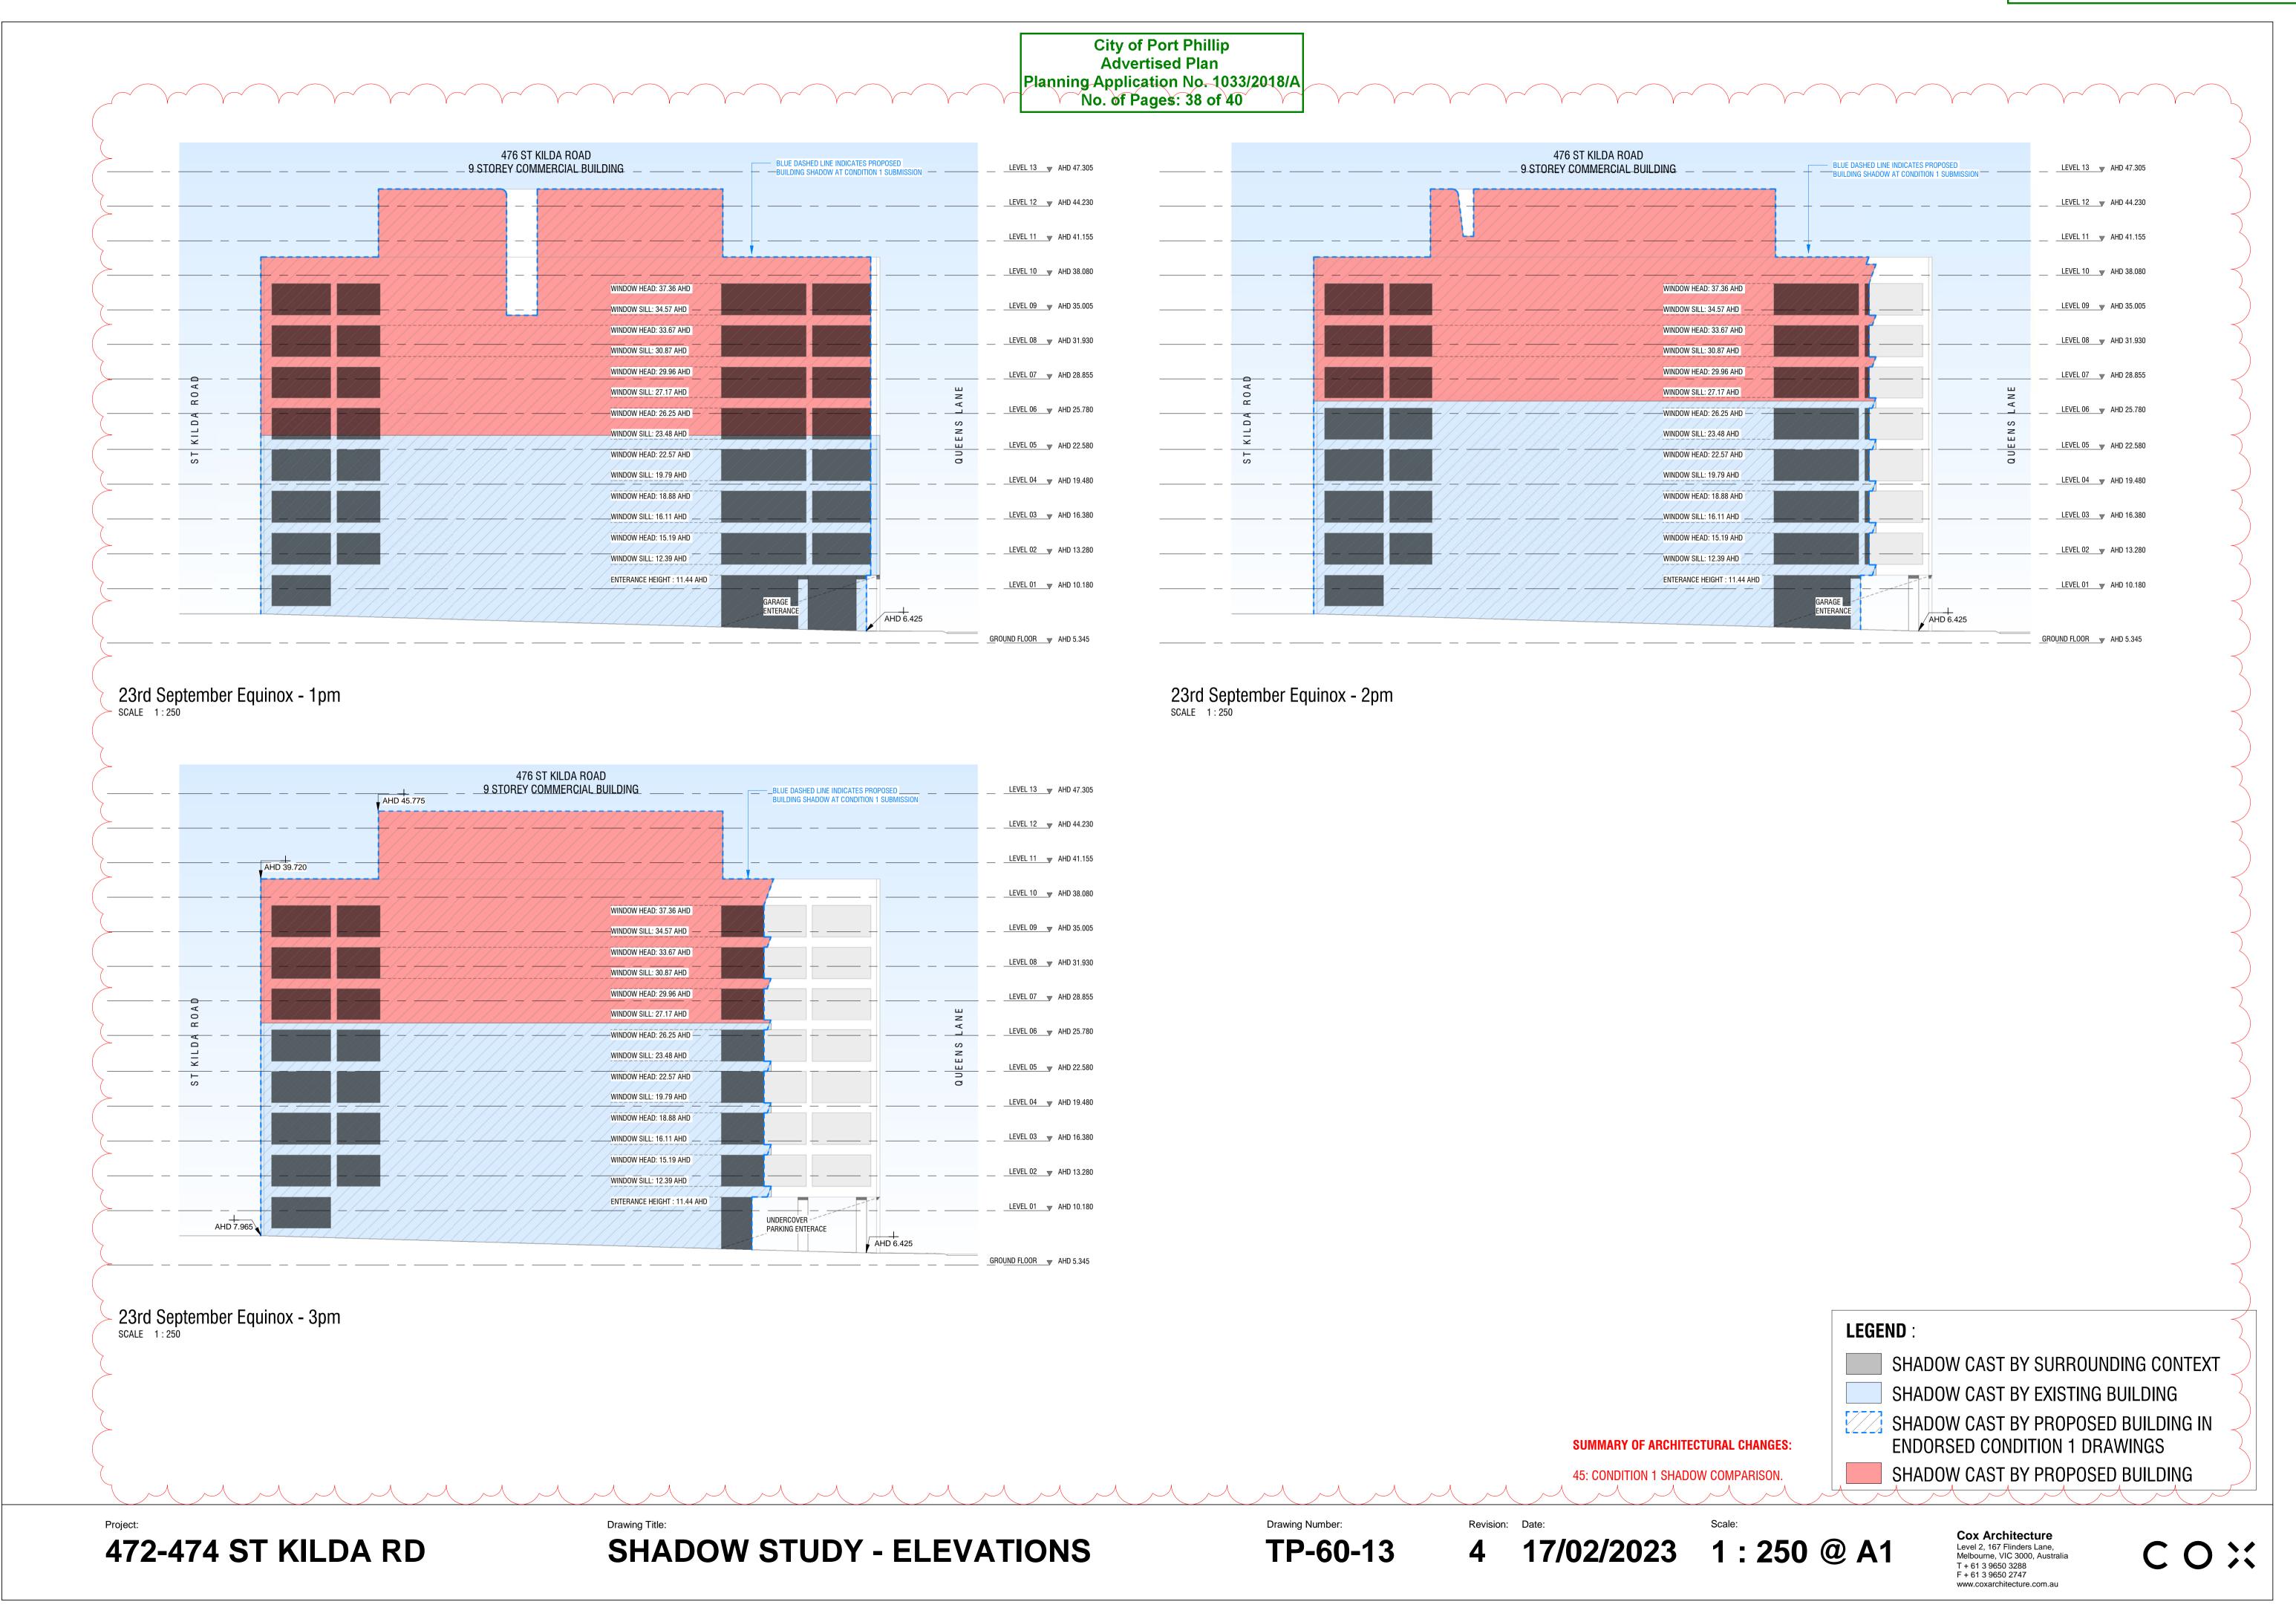






Document Set ID: 6651871 Version: 3, Version Date: 18/05/2023





1: DELETION OF LEVEL 01 PODIUM - LEVEL 01 NOW FORMS PART OF THE TOWER FORM AND IS THE FIRST LEVEL OF SERVICED APARTMENTS.

20: GROUND FLOOR LEVEL RAISED TO REDUCE DIFFERENTIAL TO STREET, AND IMPROVE CLEARANCE FOR CAR PARK RAMP ENTRY.

31: RESIDENTIAL PRIVACY SCREEN DESIGN AND DETAILING UPDATED.

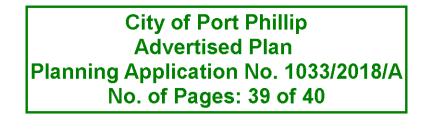
32: FRITTED PRIVACY GLAZING INCLUDED WHERE APARTMENTS OVERLOOK EACH OTHER.

33: PRIVACY SCREENS REMOVED FROM HOTEL LEVELS.

35: FACADE FINS DETAILING AND MODELLING UPDATED.

54: REDUCED NUMBER OF LARGE TREES TO HIGH RISE FACADE PLANTERS AS PER LANDSCAPE DOCUMENTATION.

55: UPDATED CODES, IMAGES AND DESCRIPTIONS OF MATERIALS





472-474 ST KILDA RD


Drawing Title: RENDER Drawing Number: **TP-60-50**

17/02/2023

@ A1

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1 GROUND FLOOR - LANEWAY PLAN

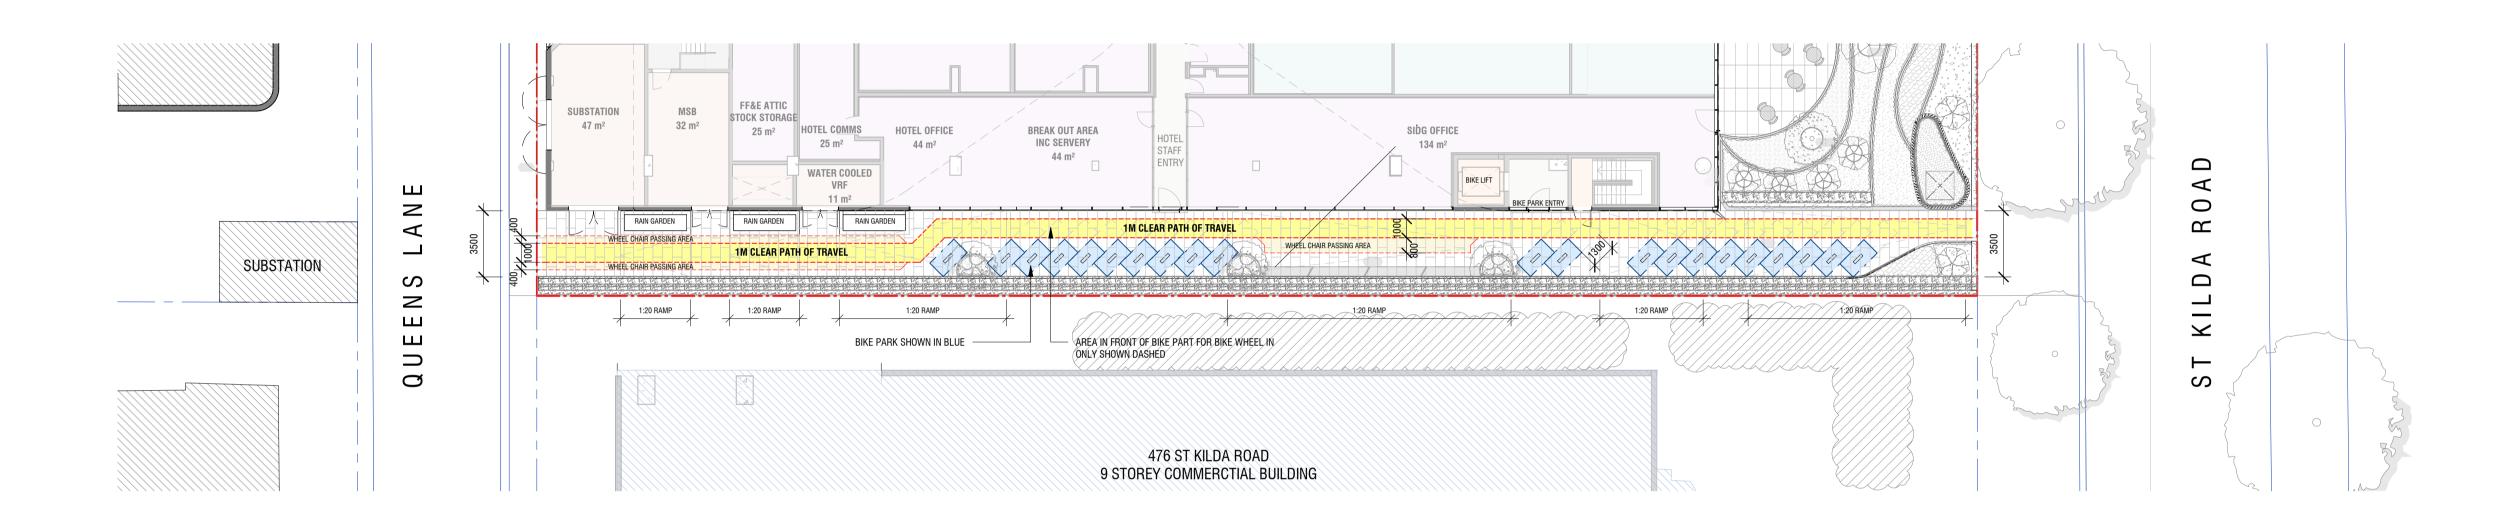SCALE 1: 200