


97 ALMA ROAD, ST. KILDA


ARCHITECTURAL DRAWING LIST (TOWN PLANNING)

TOTAL: 50

DRAWING NO.	DRAWING TITLE	CURRENT REVISION	CURRENT REVISION DATE
TP000 SER	RIES - PROJECT INFORMATION		
TP000	DRAWING LIST	2	27.07.2023
TP000	DEVELOPMENT SUMMARY	2	27.07.2023
TP010 SER	RIES - SITE INFORMATION		
TP002	NEIGHBOURHOOD AND SITE DESCRIPTION PLAN	1	27.07.2023
TP003	MASSING RESPONSE	1	27.07.2023
TP010	EXISTING SITE PLAN	2	27.07.2023
TP020	PROPOSED SITE PLAN	2	27.07.2023
TP021	GARDEN AREA PLAN	1	27.07.2023
TP022	DEEP SOIL AREA PLAN	1	27.07.2023
TP023	PERMEABLE AREA PLAN	1	27.07.2023
TP024	SITE COVERAGE AREA PLAN	1	27.07.2023
TP100 SER	RIES - GA PLANS		
TP1B1	GA PLAN - LEVEL BASEMENT B1	2	27.07.2023
TP100	GA PLAN - LEVEL BASEMENT BY	2	27.07.2023
TP101	GA PLAN - LEVEL 1	2	27.07.2023
TP102	GA PLAN - LEVEL 2	2	27.07.2023
TP103	GA PLAN - LEVEL 3	2	27.07.2023
TP104	GA PLAN - LEVEL ROOF	2	27.07.2023
TD200 SED	RIES - GA ELEVATIONS		
			07.07.0000
TP300	GA ELEVATIONS - APARTMENT BUILDING	2	27.07.2023
TP301	GA ELEVATIONS - TOWNHOUSES	2	27.07.2023
TP400 SER	RIES - GA SECTIONS		
TP400	GA SECTIONS - SHEET 1	2	27.07.2023
TP401	GA SECTIONS - SHEET 2	$\sqrt{2}$	27.07.2023
TP402	DETAIL SECTION - SCREENING	0	27.07.2023
TP600 SER	RIÉS - TYPICAL LAYOUTS & COMPLIANCE		
TP600	APARTMENT DESIGN GUIDELINES COMPLIANCE SCHEDULES	(1	27.07.2023
TP610	APARTMENT PLAN - TYPE 1B-1, 1-B2, 1B-3 & 1B-4	2	27.07.2023
TP620	APARTMENT PLAN - TYPE 2B-1 & 2B-2	2	27.07.2023
TP621	APARTMENT PLAN - TYPE 2B-3 & 2B-4	2	27.07.2023
TP622	APARTMENT PLAN - TYPE 2B-5 & 2B-6	2 2	27.07.2023
TP623 TP624	APARTMENT PLAN - TYPE 2B-7 & 2B-8 APARTMENT PLAN - TYPE 2BD-1 & 2BD-2	2 2	27.07.2023 27.07.2023
TP625	APARTMENT PLAN - TYPE 2BD-1 & 2BD-2 APARTMENT PLAN - TYPE 2BD-3 & 2BD-4	2 2	27.07.2023
TP630	APARTMENT PLAN - TYPE 3B-1, 3B-2, 3B-3 & 3B-4	(2	27.07.2023
TP631	APARTMENT PLAN - TYPE 3B-5. 3B-6 & 3B-7	2	27.07.2023
TP632	APARTMENT PLAN - TYPE 3B-8 & 3B-9	2	27.07.2023
TP633	APARTMENT PLAN - TYPE 3B-10, 3B-11 & 3B-12	2	27.07.2023
TP634	APARTMENT PLAN - TYPE 3B-13 & 3B-14	2	27.07.2023
TP650	TOWNHOUSE PLANS - TYPE A1	(2	27.07.2023
TP651	TOWNHOUSE PLANS - TYPE A2	2	27.07.2023
TP652	TOWNHOUSE PLANS - TYPE A3	2	27.07.2023
TP653	TOWNHOUSE PLANS - TYPE A4	2	27.07.2023
TP654	TOWNHOUSE PLANS - TYPE A5	2	27.07.2023
TP655	TOWNHOUSE PLANS - TYPE A6	(2	27.07.2023
TP660	TOWNHOUSE PLANS - TYPE B1	2	27.07.2023
TP661	TOWNHOUSE PLANS - TYPE B2	2	27.07.2023
TP670	TOWNHOUSE PLANS - TYPE C1	2	27.07.2023
TP671	TOWNHOUSE PLANS - TYPE C2	2	27.07.2023
TP672	TOWNHOUSE PLANS - TYPE C3	2	27.07.2023
TP800 SER	RIES - SCHEDULES		Ž
TP800	MATERIALS PALETTE	2	27.07.2023
TP900 SER	RIES - SHADOW DIAGRAMS		
TP940	SHADOW STUDIES 22/9 - 9AM-11AM	(1	27.07.2023
TP941	SHADOW STUDIES 22/9 -12PM-2PM	1	27.07.2023
TP943	SHADOW STUDIES 22/9 - 3PM	7 1	27.07.2023
TP950	SHADOW STUDIES OF PROPOSED COS ROOF TERRACE 21/6 -	1	27.07.2023
	10AM-2.30PM		\sim

City of Port Phillip Advertised Plan Planning Application No. PDPL/00823/2022 No. of Pages: 1 of 50

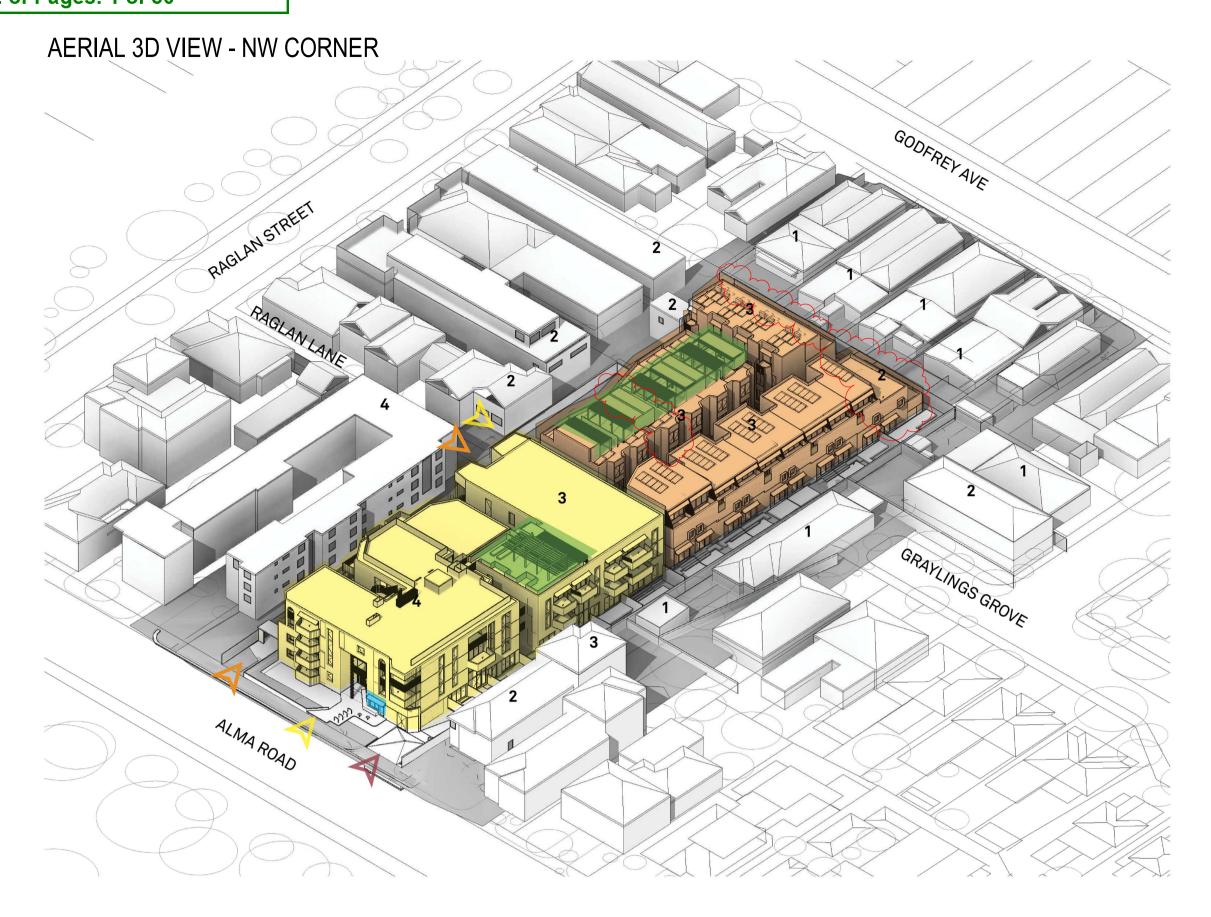

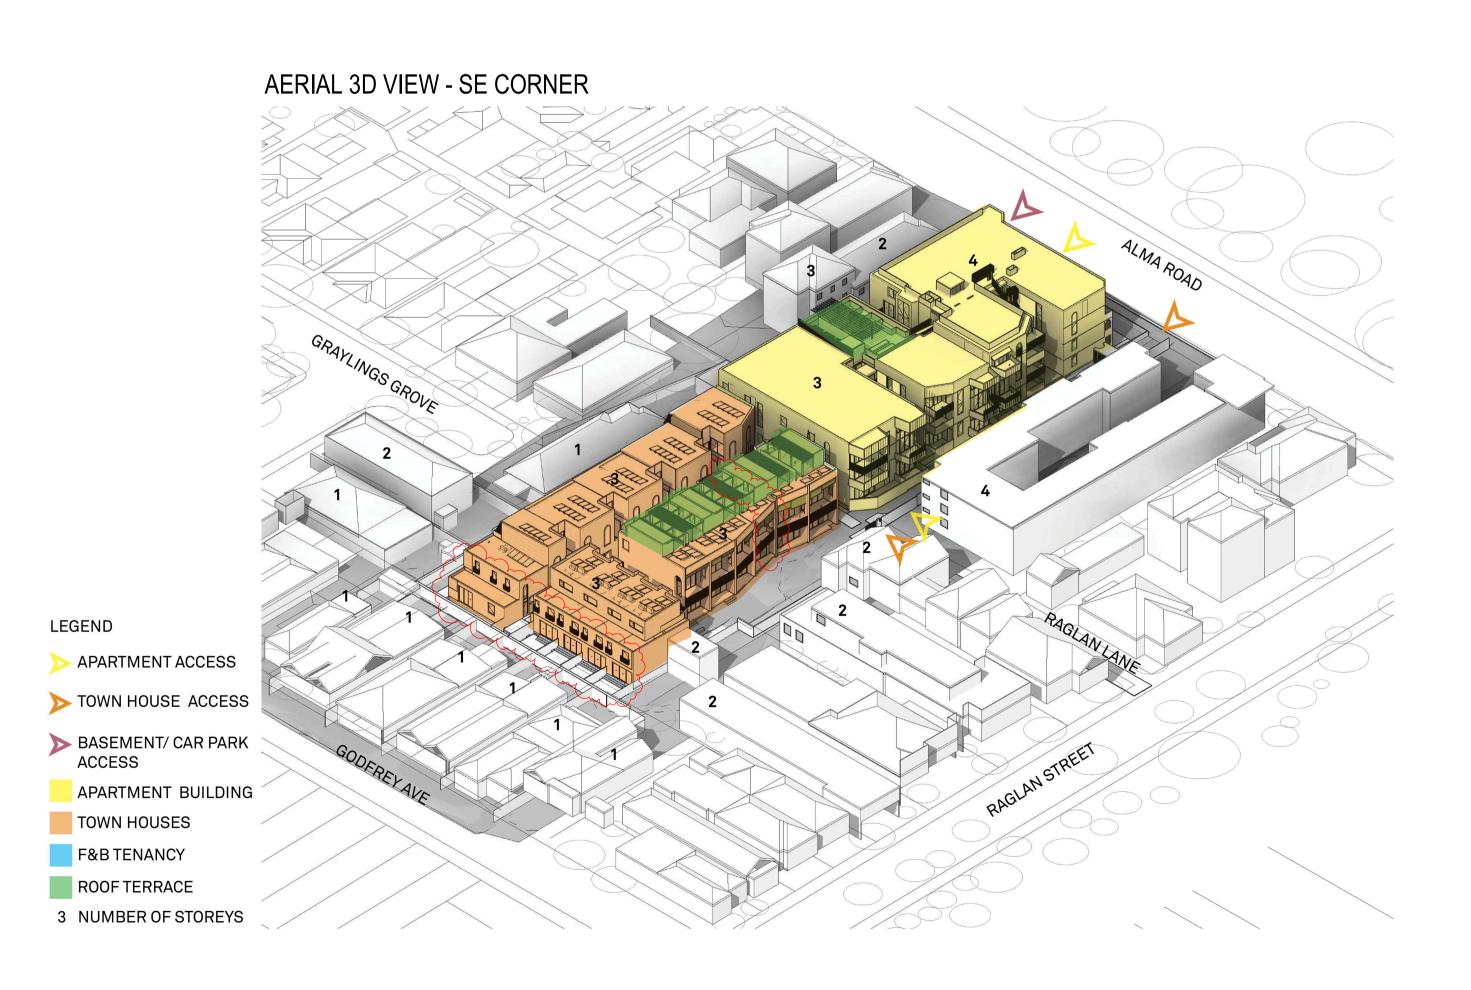

No. Date Description
0 18.11.2022 Issued for Town Planning
1 15.03.2023 Issued for RFI Response
2 27.07.2023 Amended TP Submission

TOWN PLANNING NOT FOR CONSTRUCTION

__KTA

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DRAWING TITLE
DRAWING LIST

PROJECT 97 Alma Road

AT St Kilda East Neometro

City of Port Phillip Advertised Plan Planning Application No. PDPL/00823/2022 No. of Pages: 2 of 50

TP DEVELOPMENT SUMMARY*

SITE	m2
Site Area	4,997
Garden Area	1,814
Garden Area as percentage of Site Area	36%
Site Coverage Area	2,956
Site Coverage Area as percentage of Site Area	59%
Permeable Area	1,013
Permeable Area as percentage of Site Area	20%
OPEN SPACE	
Outdoor Communal Open Space required	132.5m ²
Outdoor Communal Open Space provided	141m²
DEEP SOIL PLANTING & TREE CANOPY COVER	_
Deep Soil Planting Area required	750m ²
Deep Soil Planting Area provided	793m ²
Tree Canopy Cover Area required	850m ²
Tree Canopy Cover Area provided	896m²
PARKING	
CAR PARKING	
Car Spaces (Housing Use)	87
Car Spaces (Non-Housing Use)	1
Contract of the second of the	MR
Total	88
and the second s	I To See
Total	I To See
Total MOTORBIKE PARKING	88
MOTORBIKE PARKING Motorbike Spaces (Housing Use)	5
MOTORBIKE PARKING Motorbike Spaces (Housing Use) Total	5
MOTORBIKE PARKING Motorbike Spaces (Housing Use) Total BICYCLE PARKING	5 5
MOTORBIKE PARKING Motorbike Spaces (Housing Use) Total BICYCLE PARKING Residents Bicycle Spaces	5 5 5
MOTORBIKE PARKING Motorbike Spaces (Housing Use) Total BICYCLE PARKING Residents Bicycle Spaces Staff Bicycle Spaces	5 5 5 2
MOTORBIKE PARKING Motorbike Spaces (Housing Use) Total BICYCLE PARKING Residents Bicycle Spaces Staff Bicycle Spaces External Visitor Bicycle Spaces	5 5 5 62 2 16 80
MOTORBIKE PARKING Motorbike Spaces (Housing Use) Total BICYCLE PARKING Residents Bicycle Spaces Staff Bicycle Spaces External Visitor Bicycle Spaces Total	5 5 5 2 16

Sub-Type	Apt No.	Unit Size	Comments	No.	%
oub Type	Aperto	Ome Oize	Commence	110.	70
1B-1	G.03	56m ²		1	
1B-2	G06 & G.07	55m ²		2	
1B-3	G.09	60m ²		1	
1B-4	2.02 & 2.10	54m ²		2	
				6	14.6%
00.4	10.04	2 2			
Manager Control		Ver. 200 (100 (100 (100 (100 (100 (100 (100		1	
			to who your strain on		
		New Country Country	" 전쟁이 아이지는 전체를 맞았다면서 다른 사람이 모양되고 있다.		
	CONTRACTOR PROGRAMMENT FOR STATE OF STA		CONTROL OF STREET STREET, NO. 100 TO 100		
			E DES TRANSPORTE DER DES DE LE PROPERTO DE LA CONTRACTOR		
			Accessible (ADGV**)	2	
			No. 20070 desirate acceptant acceptant	1	
2B-8	1.12 & 2.11	90m²	Accessible (ADGV**)	5565	المائية والمائية والمتعود المتعود المتعود
				15	36.6%
2RD-1	G 02	101m ²		1	
500 Tel - California - S.C.				1	
				2	
		0.07040FC 10011.		1	
200-4	1.00	100111		' 5	12.2%
				<u> </u>	12.270
3B-1	G.04	119m²	Accessible (ADGV**)	1	
3B-2	1.03	122m ²	Accessible (ADGV**)	1	
3B-3	2.04	121m²	Accessible (ADGV**)	1	
3B-4	3.03	131m ²	Accessible (ADGV**)	1	
3B-5	G.10	123m ²	Accessible (ADGV**)	1	
3B-6	1.09	123m ²	Accessible (ADGV**)	1	
3B-7	2.07	143m ²	Accessible (ADGV**)	1	
3B-8	G.11	117m ²	Accessible (ADGV**)	1	
3B-9	1.10 & 2.08	118m ²	Accessible (ADGV**)	2	
3B-10		140m ²			
3B-11		140m ²		1	
		145m ²	TO MINOR E AND SELECTIONS	1	
			and water Beauty appears in		
		•			
		(0.771.780,253.71)		15	36.6%
					100%
					63%
				5	12%
				1	2%
				22	29%
				1000	20%
					20%
				7	17%
	1B-2 1B-3 1B-4 2B-1 2B-2 2B-3 2B-4 2B-5 2B-6 2B-7 2B-8 2BD-1 2BD-2 2BD-3 2BD-4 3B-1 3B-2 3B-3 3B-4 3B-5 3B-6 3B-7 3B-8	1B-1 G.03 1B-2 G06 & G.07 1B-3 G.09 1B-4 2.02 & 2.10 2B-1 G.01 2B-2 1.01 & 2.01 2B-3 G.05, 1.04 & 2.05 2B-4 G.08, 1.07, 2.06 2B-5 G.12 2B-6 1.11 & 2.09 2B-7 G.14 2B-8 1.12 & 2.11 2BD-1 G.02 2BD-2 G.13 2BD-3 1.05 & 1.06 2BD-4 1.08 3B-1 G.04 3B-2 1.03 3B-3 2.04 3B-4 3.03 3B-5 G.10 3B-6 1.09 3B-7 2.07 3B-8 G.11 3B-9 1.10 & 2.08 3B-10 1.02 3B-11 2.03 3B-12 3.02 3B-13 3.01	1B-1 G.03 56m² 1B-2 G06 & G.07 55m² 1B-3 G.09 60m² 1B-4 2.02 & 2.10 54m² 2B-1 G.01 85m² 2B-2 1.01 & 2.01 85m² 2B-3 G.05, 1.04 & 2.05 83m² 2B-4 G.08, 1.07, 2.06 85m² 2B-5 G.12 91m² 2B-7 G.14 82m² 2B-8 1.12 & 2.11 90m² 2BD-1 G.02 101m² 2BD-2 G.13 101m² 2BD-3 1.05 & 1.06 98m² 2BD-4 1.08 106m² 3B-1 G.04 119m² 3B-2 1.03 122m² 3B-3 2.04 121m² 3B-4 3.03 131m² 3B-5 G.10 123m² 3B-6 1.09 123m² 3B-7 2.07 143m² 3B-8 G.11 117m² 3B-9 1.10 & 2.08 118m² 3B-10 1.02 140m² 3B-11 2.03 140m² 3B-12 3.02 145m² 3B-13 3.01 129m²	1B-1	1B-1 G.03 56m² 1 1B-2 G06 & G.07 55m² 2 1B-3 G.09 60m² 1 1B-4 2.02 & 2.10 54m² 2 2 2B-1 G.01 85m² 2 2B-3 G.05, 1.04 & 2.05 83m² Accessible (ADGV**) 3 2B-4 G.08, 1.07, 2.06 85m² Accessible (ADGV**) 1 2B-6 1.11 & 2.09 87m² Accessible (ADGV**) 2 2B-7 G.14 82m² 1 2B-8 1.12 & 2.11 90m² Accessible (ADGV**) 2 2B-7 G.14 82m² 1 2B-1 G.02 101m² 1 2B-2 G.13 101m² 1 2B-3 1.05 & 1.06 98m² 2 2B-4 G.08 1.07 (ACCESSIBLE (ADGV**) 2 2B-5 G.12 91m² Accessible (ADGV**) 1 2B-6 1.11 & 2.09 87m² Accessible (ADGV**) 2 2B-7 G.14 82m² 1 2B-8 1.12 & 2.11 90m² Accessible (ADGV**) 2 2B-7 G.14 82m² 1 2B-1 G.02 101m² 1 2B-1 G.02 101m² 1 2B-1 G.02 101m² 1 2B-1 G.02 101m² 1 2B-2 G.13 101m² 1 2B-3 1.05 & 1.06 98m² 2 2B-4 1.08 106m² 1 3B-6 1.09 123m² Accessible (ADGV**) 1 3B-7 2.07 143m² Accessible (ADGV**) 1 3B-8 G.11 17m² Accessible (ADGV**) 1 3B-9 1.10 & 2.08 118m² Accessible (ADGV**) 1 3B-9 1.10 & 2.08 118m² Accessible (ADGV**) 1 3B-10 1.02 140m² Accessible (ADGV**) 1 3B-13 3.01 129m² Accessible (ADGV**) 1 3B-13 3.01 129m² Accessible (ADGV**) 1 3B-13 3.01 129m² Accessible (ADGV**) 1 3B-14 3.04 128m² Accessible (ADGV**) 1 3B-15 4 Accessible (ADGV**) 1 3B-16 1.00 2 140m² Accessible (ADGV**) 1 3B-17 2.07 143m² Accessible (ADGV**) 1 3B-18 3.01 129m² Accessible (ADGV**) 1 3B-19 1.00 2.08 118m² Accessible (ADGV**) 1 3B-10 1.02 140m² Accessible (ADGV**) 1 3B-11 2.03 140m² Accessible (ADGV**) 1 3B-12 3.01 129m² Accessible (ADGV**) 1 3B-13 3.01 129m² Accessible (ADGV**) 1 3B-14 3.04 128m² Accessible (ADGV**) 1

	0.1.	T11.61	11.11.01	
Apartment Type	Sub-Type	TH No.	Unit Size***	No.
East Block	A1	TH 01	175	1
	A2	TH 02	175	1
	A3	TH 03	178	1
	A4	TH 04	168	1
	A5	TH 05	178	1
~	A6	TH 06	185	1
Total A				6
South Block	B1	TH 07	175	1
South Block	B1	TH 07	175	1
	B2	TH 08	165	1
	B2	TH 09	165	1
Sc.	B2	TH 10	170	1
Total B				4
West Block	C1	TH 20	148	1
	C2	TH 12-19	151	8
	C3	TH 11	174	1
Total C				10
Total Townhouses				20

General Notes:

*Residential NSA and commercial GLA areas have been calculated in accordance with the Property Council of Australia Method of Measurement. All figures are preliminary and are subject to Planning Approval.


**ADGV - Apartment Design Guidelines for Victoria Feb 2021

 No.
 Date
 Description

 0
 18.11.2022
 Issued for Town Planning

 1
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DRAWING TITLE
DEVELOPMENT SUMMARY PROJECT 97 Alma Road

AT St Kilda East Neometro

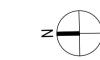

^{***}excludes basement TH stairs and voids

City of Port Phillip Advertised Plan Planning Application No. PDPL/00823/2022 No. of Pages: 3 of 50



101 ALMA ROAD




99 ALMA ROAD



95A/95 ALMA ROAD



93 ALMA ROAD

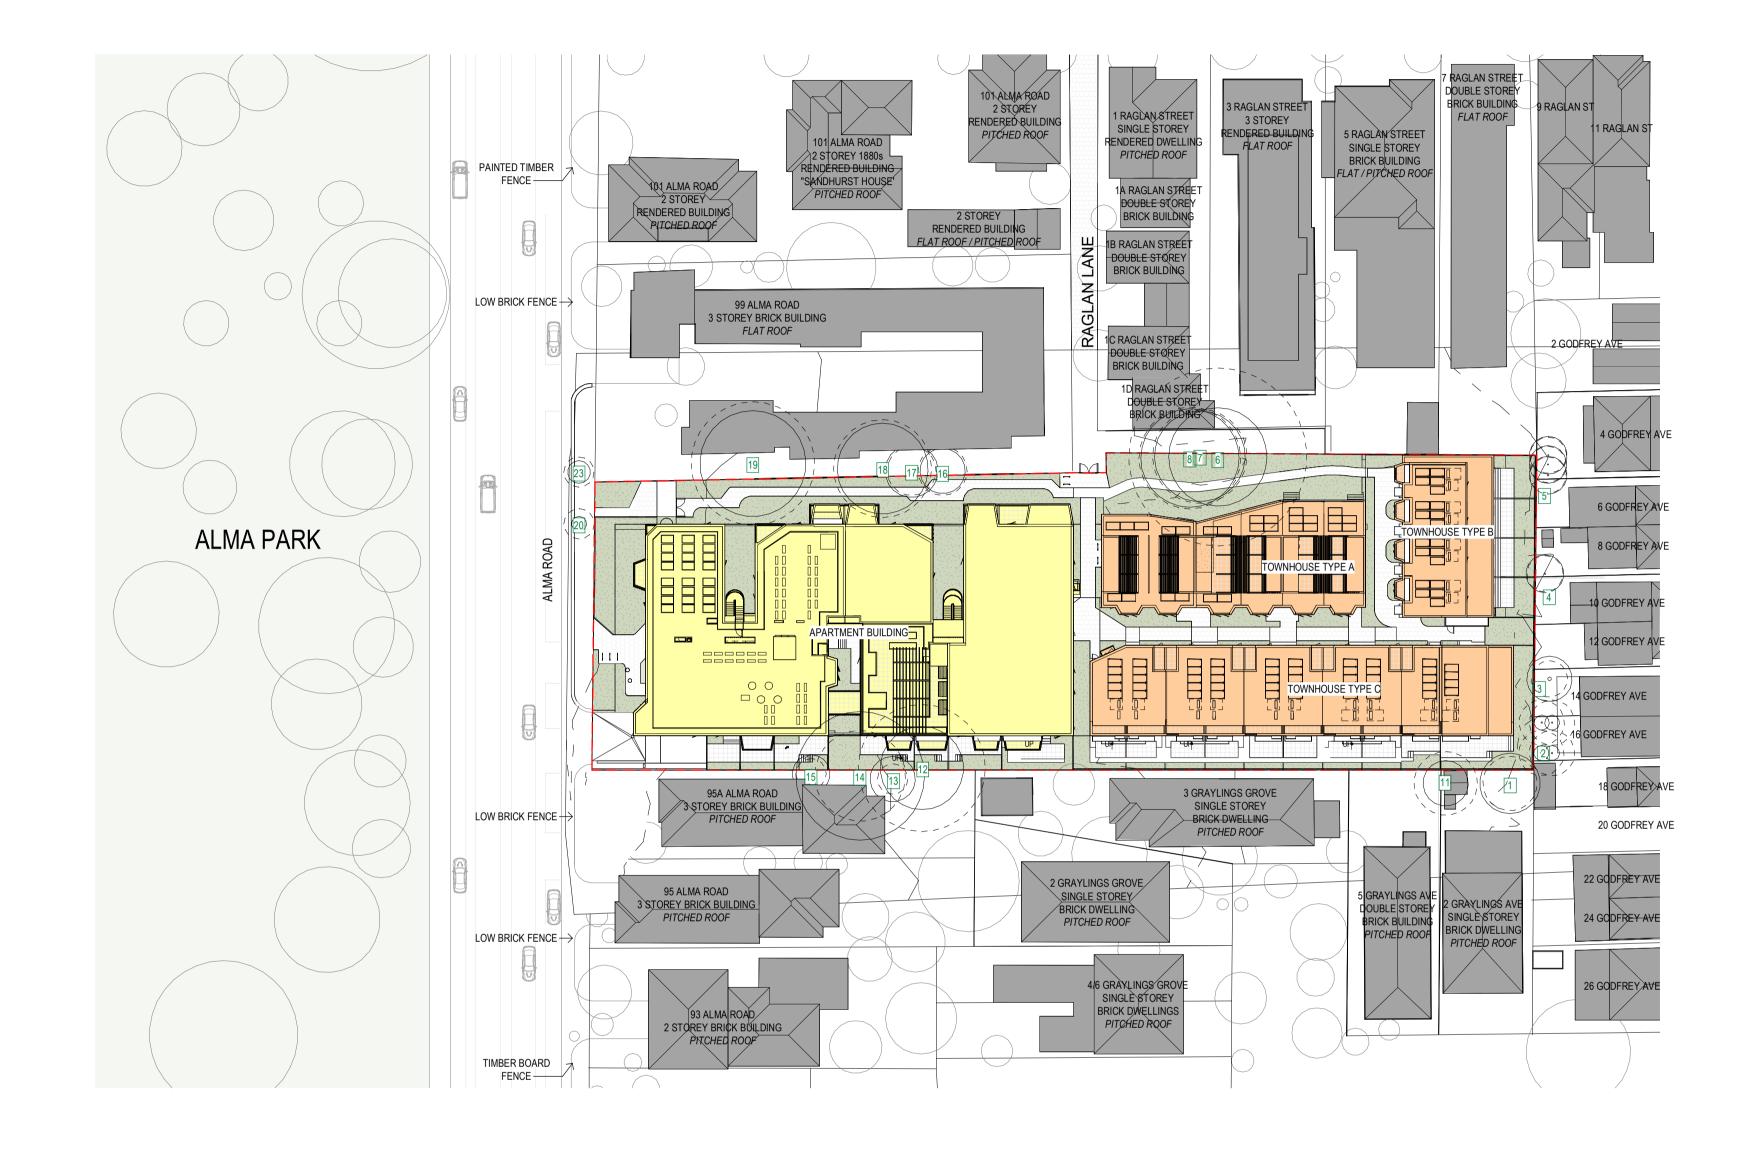




ALMA PARK



ALMA PARK - AERIAL VIEW

SURVEY: EXISTING SITE INFORMATION IS TAKEN FROM VERIS SURVEY NUMBER 303981-BG DATED 06/07/2023 AND IS PROVIDED HERE FOR ILLUSTRATIVE PURPOSES ONLY. FOR FULL SURVEY DETAILS REFER TO SURVEY DOCUMENTS PROVIDED WITHIN APPENDICIES.

LANDSCAPE DESIGN: LANDSCAPE DESIGN IS SHOWN INDICATIVELY. FOR FULL LANDSCAPE DETAILS REFER TO LANDSCAPE ARCHITECT'S DOCUMENTATION.

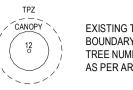

EXISTING TREE WITHIN PROJECT BOUNDARY TO BE RETAINED. TREE NUMBER, TPZ AND CANOPY AS PER ARBORIST REPORT

ABBREVIATIONS:

AC CONDENSER UNIT CL CLOTHES LINE
ELEC ELECTRICAL SERVICES

HYDR HYDRAULIC SERVICES COM COMMS SERVICES

FCL FINISHED CEILING LEVEL
FFL FINISHED FLOOR LEVEL FHR FIRE HOSE REEL FHY FIRE HYDRANT

FIP FIRE INDICATOR PANEL FW FLOOR WASTE NGL NATURAL GROUND LEVEL

RELATIVE LEVEL TP WATER TAP HW HOT WATER UNIT HP HEAT PUMP HOT WATER UNIT

OW OPERABLE WINDOW

__ MATERIALS

BR1 BRICK WORK - BAGGED TEXTURE FINISH
BR2 BREEZE BLOCK
FC1 PAINTED FIBRE CEMENT SHEET TL1 EXTERNAL TILE SC1 SUN SHADESCREEN MT1 VERTICAL ALUMINIUM BALUSTRADE MT2 GLAVANISED STEEL CLADDING MT3 METAL PERGOLA GL1 GLAZING - DOUBLE CLEAR
GL2 OBSCURE GLAZING - REEDED MS1 CABLE MESH MS2 MESH FENCING MS3 MESH SCREEN AS1 ACOUSTIC WALL PANEL

SR1 SAFETY GUARD RAIL

ESD:

1. THE PROJECT ACHIEVES A TOTAL BESS SCORE OF 73% WITH NO MANDATORY CATEGORY (IDEQ, ENERGY, WATER, STORMWATER) BELOW 50%.

2. 100% (41 OUT OF 41) OF THE DEVELOPMENTS APARTMENTS AND 100% (21 OUT OF 21) OF THE DEVELOPMENT'S TOWNHOUSES ARE NATURALLY CROSS-VENTILATED.

3. DAYLIGHT MODELLING HAS BEEN CONDUCTED FOR A REPRESENTATIVE SAMPLE OF APARTMENTS. THE SUMMARY RESULT IS AS FOLLOWS:

88% OF LIVING FLOOR AREA ACHIEVES >90% ABOVE DF 1

• 22% OF BEDROOM FLOOR AREA ACHIEVES >90% ABOVE DF 1

- 88% OF LINING FLOOR AREA ACHIEVES >90% ABOVE DF0.5

4. THE NON-RESIDENTIAL AREAS ARE TARGETING A 2% DF TO 40% OF THE NOMINATED AREA.

5. 39% (16 OUT OF 41) OF APARTMENTS ACHIEVE AT LEAST 3 HOURS OF SUNLIGHT.

6. THE DEVELOPMENT IS PROVIDED WITH A COMPREHENSIVE SHADING STRATEGY.

7. THE DEVELOPMENT IS PROVIDED WITH A COMPREHENSIVE SHADING STRATEGY.

7. THE DEVELOPMENT IS TO ACHIEVE A 7.5 STAR AVERAGE NATHERS ENERGY RATING RESULT FOR THE APARTMENTS AND A 7.0 STAR AVERAGE NATHERS ENERGY RATING RESULT FOR THE TOWNHOUSES.

8. THE NON-RESIDENTIAL AREAS AIM TO REDUCE HEATING AND COOLING ENERGY CONSUMPTION BELOW THE REFERENCE CASE (BCA SECTION J. 2019).

9. THE DEVELOPMENT IS TO UTILISE ELECTRIC HEAT PUMP HOT WATER SYSTEM.

10. A 9.6KW SOLAR PV SYSTEM IS TO BE LOCATED ON THE ROOF OF THE APARTMENT BUILDING.

11. A 2KW SOLAR PV SYSTEM IS TO BE PROVIDED FOR EACH TOWNHOUSE.

12. INDIVIDUAL COLD WATER AND ELECTRICITY METERS WILL BE PROVIDED TO THE APARTMENTS, TOWNHOUSES

AND COMMUNAL AREAS.

13. WATER EFFICIENT FITTINGS AND FIXTURES ARE APPLIED THROUGHOUT.

14. A 32.000-LITER ERAINWATER TANK AND A 30,000-LITRE RAINWATER TANK WILL HARVEST RAINWATER FROM THE APARTMENT FOOP AND TOWNHOUSE ROOFS RESPECTIVELY. THESE TANKS WILL BE CONNECTED TO ALL TOILETS.

15. A MELBOURNE STORM RATING OF 102% IS ACHIEVED.

16. ALL LANDSCAPING IS TO BE NATIVE SPECIES OR LANDSCAPING IRRIGATION IS TO BE CONNECTED TO THE PRAINWATER TANK ONLY.

17. IN TOTAL 62 BICYCLE SPACES ARE TO BE PROVIDED FOR RESIDENTIAL AND NON-RESIDENTIAL VISITORS.

20. ONE CHARGING POINT FOR ELECTRICAL VEHICLES IS INTEGRATED IN THE PROPOSED DEVELOPMENT.

21. 141M2 OF COMMUNAL SPACE WILL BE PROVIDED AT THE ROOFTOP DECK.

22. 24M2 OF COMMUNAL FOOD PRODUCTION AREA WILL BE PROVIDED.

REFER TO ESD CONSULANTS DOCUMENTATION FOR FULL DETAILS No. Date Description 15.03.2023 Issued for RFI Response

1 27.07.2023 Amended TP Submission

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DRAWING TITLE NEIGHBOURHOOD AND SITE DESCRIPTION PLAN

97 Alma Road

AT St Kilda East FOR Neometro

As indicated(A1) 2202

City of Port Phillip
Advertised Plan
Planning Application No. PDPL/00823/2022
No. of Pages: 4 of 50



ALMA ROAD ELEVATION



FROM ALMA PARK LOOKING SOUTH



FROM ALMA PARK LOOKING SOUTH-EAST

No.	Date	Description
0	15.03.2023	Issued for RFI Response
1	27.07.2023	Amended TP Submission

TOWN PLANNING
NOT FOR CONSTRUCTION

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DRAWING TITLE
MASSING RESPONSE

PROJECT
97 Alma Road
AT St Kilda

AT St Kilda East FOR Neometro

DATE DRAW

DRAWN BY 07.2023 JL DRAWING NO.

1) PROJECT TP003

3 1

City of Port Phillip Advertised Plan SURVEY: Planning Application No. PDPL/00823/2022 No. of Pages: 5 of 50 EXISTING SITE INFORMATION IS TAKEN FROM VERIS SURVEY NUMBER 303981-BG DATED 06/07/2023 AND IS PROVIDED HERE FOR ILLUSTRATIVE PURPOSES ONLY. FOR FULL SURVEY DETAILS REFER TO SURVEY DOCUMENTS PROVIDED WITHIN LANDSCAPE DESIGN: LANDSCAPE DESIGN IS SHOWN INDICATIVELY. FOR FULL LANDSCAPE DETAILS REFER TO LANDSCAPE ARCHITECT'S DOCUMENTATION. BOUNDARY TO BE RETAINED. TREE NUMBER, TPZ AND CANOPY AS PER ARBORIST REPORT 57.91 ABBREVIATIONS: AC CONDENSER UNIT **CLOTHES LINE** ELEC ELECTRICAL SERVICES HYDR HYDRAULIC SERVICES COM COMMS SERVICES FINISHED CEILING LEVEL FINISHED FLOOR LEVEL m74.4 FIRE HOSE REEL FIRE HYDRANT FIRE INDICATOR PANEL FLOOR WASTE NATURAL GROUND LEVEL RELATIVE LEVEL WATER TAP HOT WATER UNIT WINDOWS/BUILDING DETAILS NOT VISIBLE FROM SITE X HEAT PUMP HOT WATER UNIT OW OPERABLE WINDOW _ MATERIALS EDGE OF BALCONY BR1 BRICK WORK - BAGGED TEXTURE FINISH
BR2 BREEZE BLOCK
FC1 PAINTED FIBRE CEMENT SHEET
TL1 EXTERNAL TILE GROUND FLOOR WINDOWS NOT PALING FENCE 3NO. EXISTING TREES TO
BE RETAINED. REFER

ARBORIST REPORT

SOURCE

LEVEL 1998

ELVEL 1998 SC1 SUN SHADESCREEN
MT1 VERTICAL ALUMINIUM BALUSTRADE
MT2 GLAVANISED STEEL CLADDING WEZH LENCE HIGH CHAIN WIRE GRASS LANEWAY MT3 METAL PERGOLA
GL1 GLAZING - DOUBLE CLEAR
GL2 OBSCURE GLAZING - REEDED
MS1 CABLE MESH
MS2 MESH FENCING PROJECT BOUNDARY 187°30'40" 56.97 TREE TO BE REMOVED. REFER PROJECT BOUNDARY 186°05'40" 63.01 СОИСВЕТЕ 💫 ARBORIST REPORT ° KE₿₿ MS3 MESH SCREEN
AS1 ACOUSTIC WALL PANEL SR1 SAFETY GUARD RAIL '3, CONCRETE LENĈE CHAIN 13.92 WESH \ £8.E1 13.84 **ALMA ROAD** 97 ALMA ROAD EXISTING 4 STOREY BUILDING AVERAGE 12m H FROM NGL No. Date Description 18.11.2022 Issued for Town Planning 15.03.2023 Issued for RFI Response 27.07.2023 Amended TP Submission FENCE 74.05 EAVER OF THE FENCE SPOUT 15.3 WINDOWS/BUILDING DETAILS $|\mathcal{S}|_{\mathcal{S}}$ NOT VISIBLE FROM SITE HODER TSINGRAPH OF GROUND STREET STREET OF GROUND STREET STREET OF GROUND STREET STREE **TOWN PLANNING** NOT FOR CONSTRUCTION __KTA Kerstin Thompson Architects Pty Ltd 277 Queensberry St, Melbourne Australia 3000 **T +61 3 8662 8800** kta@kerstinthompson.com www.kerstinthompson.com DRAWING TITLE EXISTING SITE PLAN 97 Alma Road AT St Kilda East Neometro

_GENERAL NOTES

City of Port Phillip GENERAL NOTES Advertised Plan SURVEY: Planning Application No. PDPL/00823/2022 No. of Pages: 6 of 50 EXISTING SITE INFORMATION IS TAKEN FROM VERIS SURVEY NUMBER 303981-BG DATED 06/07/2023 AND IS PROVIDED HERE FOR ILLUSTRATIVE PURPOSES ONLY. FOR FULL SURVEY DETAILS REFER TO SURVEY DOCUMENTS PROVIDED WITHIN APPENDICIES. LANDSCAPE DESIGN: LANDSCAPE DESIGN IS SHOWN INDICATIVELY. FOR FULL LANDSCAPE DETAILS REFER TO LANDSCAPE ARCHITECT'S DOCUMENTATION. EXISTING TREE WITHIN PROJECT BOUNDARY TO BE RETAINED. TREE NUMBER, TPZ AND CANOPY AS PER ARBORIST REPORT ABBREVIATIONS: AC CONDENSER UNIT **CLOTHES LINE** ELEC ELECTRICAL SERVICES HYDR HYDRAULIC SERVICES RAGLAN COM COMMS SERVICES FINISHED CEILING LEVEL FINISHED FLOOR LEVEL FIRE HOSE REEL FIRE HYDRANT **5 RAGLAN STREET** 7 RAGLAN STREET FIRE INDICATOR PANEL FLOOR WASTE NATURAL GROUND LEVEL RELATIVE LEVEL WATER TAP 3 RAGLAN STREET 1D RAGLAN STREET HOT WATER UNIT HEAT PUMP HOT WATER UNIT OPERABLE WINDOW __ MATERIALS BR1 BRICK WORK - BAGGED TEXTURE FINISH BREEZE BLOCK PAINTED FIBRE CEMENT SHEET EXTERNAL TILE 99 ALMA ROAD SUN SHADESCREEN SC1 VERTICAL ALUMINIUM BALUSTRADE MT1 MT2 GLAVANISED STEEL CLADDING PROJECT BOUNDARY 187°30'40" 56.97 MT3 METAL PERGOLA GL1 GLAZING - DOUBLE CLEAR
GL2 OBSCURE GLAZING - REEDED CABLE MESH MESH FENCING PROJECT BOUNDARY 186°05'40" 63.01 MESH SCREEN ACOUSTIC WALL PANEL SR1 SAFETY GUARD RAIL 6 GODFREY AVE TOWNHOUSE TYPE B 1. THE PROJECT ACHIEVES A TOTAL BESS SCORE OF 73% WITH NO MANDATORY 1. THE PROJECT ACHIEVES A TOTAL BESS SCORE OF 73% WITH NO MANDATORY CATEGORY (IEQ, ENERGY, WATER, STORMWATER) BELOW 50%.
2. 100% (41 OUT OF 41) OF THE DEVELOPMENT'S APARTMENTS AND 100% (21 OUT OF 21) OF THE DEVELOPMENT'S TOWNHOUSES ARE NATURALLY CROSS-VENTILATED.
3. DAYLIGHT MODELLING HAS BEEN CONDUCTED FOR A REPRESENTATIVE SAMPLE OF APARTMENTS. THE SUMMARY RESULT IS AS FOLLOWS:

- 88% OF LIVING FLOOR AREA ACHIEVES >90% ABOVE DF 1

- 92% OF BEDROOM FLOOR AREA ACHIEVES >90% ABOVE DF0.5

4. THE NON-RESIDENTIAL AREAS ARE TARGETING A 2% DF TO 40% OF THE NOMINATED AREA. 8 GODFREY AVE **ALMA ROAD** TOWNHOUSE TYPE A NOMINATED AREA.

5. 39% (16 OUT OF 41) OF APARTMENTS ACHIEVE AT LEAST 3 HOURS OF SUNLIGHT. 6. THE DEVELOPMENT IS PROVIDED WITH A COMPREHENSIVE SHADING STRATEGY.
7. THE DEVELOPMENT IS TO ACHIEVE A 7.5 STAR AVERAGE NATHERS ENERGY
RATING RESULT FOR THE APARTMENTS AND A 7.0 STAR AVERAGE NATHERS ENERGY RATING RESULT FOR THE TOWNHOUSES.

8. THE NON-RESIDENTIAL AREAS AIM TO REDUCE HEATING AND COOLING ENERGY CONSUMPTION BELOW THE REFERENCE CASE (BCA SECTION J 2019). 10 GODFREY AVE 9. THE DEVELOPMENT IS TO UTILISE ELECTRIC HEAT PUMP HOT WATER SYSTEM 9. THE DEVELOPMENT IS TO UTILISE ELECTRIC HEAT PUMP HOT WATER SYSTEM.
10. A 9.6KW SOLAR PV SYSTEM IS TO BE LOCATED ON THE ROOF OF THE
APARTMENT BUILDING.
11. A 2KW SOLAR PV SYSTEM IS TO BE PROVIDED FOR EACH TOWNHOUSE.
12. INDIVIDUAL COLD WATER AND ELECTRICITY METERS WILL BE PROVIDED TO THE
APARTMENTS, TOWNHOUSES
AND COMMUNAL AREAS.
13. WATER EEE/CIENT EITHINGS AND EITHINES ARE APPLIED THEOLIGHOLIT. AND COMMUNAL AREAS.

13. WATER EFFICIENT FITTINGS AND FIXTURES ARE APPLIED THROUGHOUT.

14. A 32,000-LITRE RAINWATER TANK AND A 30,000-LITRE RAINWATER TANK WILL HARVEST RAINWATER FROM THE APARTMENT ROOF AND TOWNHOUSE ROOFS RESPECTIVELY. THESE TANKS WILL BE CONNECTED TO ALL TOILETS.

15. A MELBOURNE STORM RATING OF 102% IS ACHIEVED.

16. ALL LANDSCAPING IS TO BE NATIVE SPECIES OR LANDSCAPING IRRIGATION IS TO BE CONNECTED TO THE RAINWATER TANK ONLY.

17. IN TOTAL 62 BICYCLE SPACES ARE TO BE PROVIDED FOR RESIDENTS.

18. IN TOTAL 2 BICYCLE SPACES ARE TO BE PROVIDED FOR RESIDENTIAL AND NON-RESIDENTIAL VISITORS.


20. ONE CHARGING POINT FOR ELECTRICAL VEHICLES IS INTEGRATED IN THE PROPOSED DEVELOPMENT.

21. 141MZ OF COMMUNAL SPACE WILL BE PROVIDED AT THE ROOFTOP DECK.

22. 24M2 OF COMMUNAL FOOD PRODUCTION AREA WILL BE PROVIDED. APARTMENT BUILDING 12 GODFREY AVE TOWNHOUSE TYPE C REFER TO ESD CONSULANTS DOCUMENTATION FOR FULL DETAILS 14 GODFREY AVE No. Date Description 16 GODFREY AVE 18.11.2022 Issued for Town Planning 15.03.2023 Issued for RFI Response 2 27.07.2023 Amended TP Submission PROJECT BOUNDARY 7°12'10" 124.54 18 GODFREY AVE **TOWN PLANNING** 95A ALMA ROAD 3 GRAYLINGS AVE NOT FOR CONSTRUCTION __KTA Kerstin Thompson Architects Pty Ltd 277 Queensberry St, Melbourne Australia 3000 T +61 3 8662 8800 kta@kerstinthompson.com www.kerstinthompson.com 5 GRAYLINGS AVE 2 GRAYLINGS AVE DRAWING TITLE PROPOSED SITE PLAN 97 Alma Road AT St Kilda East FOR Neometro 27.07.2023 JL

City of Port Phillip Advertised Plan Planning Application No. PDPL/00823/2022 No. of Pages: 7 of 50



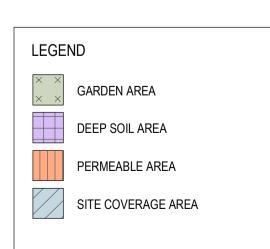

TOTAL GARDEN AREA: 1814m² TOTAL SITE AREA: 4997m²

GARDEN AREA AS PERCENTAGE OF SITE AREA: 36%

SURVEY:

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LANDSCAPE DESIGN: LANDSCAPE DESIGN IS SHOWN INDICATIVELY. FOR FULL LANDSCAPE DETAILS REFER TO LANDSCAPE ARCHITECT'S DOCUMENTATION.



EXISTING TREE WITHIN PROJECT BOUNDARY TO BE RETAINED. TREE NUMBER, TPZ AND CANOPY AS PER ARBORIST REPORT

ABBREVIATIONS: AC CONDENSER UNIT

CL CLOTHES LINE

ELEC ELECTRICAL SERVICES HYDR HYDRAULIC SERVICES

COM COMMS SERVICES FCL FINISHED CEILING LEVEL FFL FINISHED FLOOR LEVEL FHR FIRE HOSE REEL

FHY FIRE HYDRANT FIP FIRE INDICATOR PANEL FW FLOOR WASTE

NGL NATURAL GROUND LEVEL RELATIVE LEVEL TP WATER TAP

HW HOT WATER UNIT HP HEAT PUMP HOT WATER UNIT OW OPERABLE WINDOW

_ MATERIALS

BR1 BRICK WORK - BAGGED TEXTURE FINISH
BR2 BREEZE BLOCK FC1 PAINTED FIBRE CEMENT SHEET TL1 EXTERNAL TILE SC1 SUN SHADESCREEN MT1 VERTICAL ALUMINIUM BALUSTRADE MT2 GLAVANISED STEEL CLADDING MT3 METAL PERGOLA GL1 GLAZING - DOUBLE CLEAR GL2 OBSCURE GLAZING - REEDED MS1 CABLE MESH MS2 MESH FENCING MESH SCREEN AS1 ACOUSTIC WALL PANEL

SR1 SAFETY GUARD RAIL

1. THE PROJECT ACHIEVES A TOTAL BESS SCORE OF 73% WITH NO MANDATORY CATEGORY (IEQ. ENERGY, WATER, STORMWATER) BELOW 50%.
2. 100% (41 OUT OF 41) OF THE DEVELOPMENT'S APARTMENTS AND 100% (21 OUT OF 21) OF THE DEVELOPMENT'S TOWNHOUSES ARE NATURALLY CROSS-VENTILATED. DAYLIGHT MODELLING HAS BEEN CONDUCTED FOR A REPRESENTATIVE SAMPLE OF APARTMENTS. THE SUMMARY RESULT IS AS FOLLOWS:
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6. THE DEVELOPMENT IS PROVIDED WITH A COMPREHENSIVE SHADING STRATEGY

7. THE DEVELOPMENT IS TO ACHIEVE A 7.5 STAR AVERAGE NATHERS ENERGY RATING RESULT FOR THE APARTMENTS AND A 7.0 STAR AVERAGE NATHERS RATING RESULT FOR THE APARTMENTS AND A 7.0 STAR AVERAGE NATHERS ENERGY RATING RESULT FOR THE TOWNHOUSES.

8. THE NON-RESIDENTIAL AREAS AIM TO REDUCE HEATING AND COOLING ENERGY CONSUMPTION BELOW THE REFERENCE CASE (BCA SECTION J 2019).

9. THE DEVELOPMENT IS TO UTILISE ELECTRIC HEAT PUMP HOT WATER SYSTEM.

10. A 9.6KW SOLAR PY SYSTEM IS TO BE LOCATED ON THE ROOF OF THE APARTMENT BUILDING. APARTMENT BUILDING.

11. A 2KW SOLAR PV SYSTEM IS TO BE PROVIDED FOR EACH TOWNHOUSE.

12. INDIVIDUAL COLD WATER AND ELECTRICITY METERS WILL BE PROVIDED TO THE APARTMENTS, TOWNHOUSES
AND COMMUNAL AREAS.

13. WATER EFFICIENT FITTINGS AND FIXTURES ARE APPLIED THROUGHOUT.

14. A 32.000-LITRE RAINWATER TANK AND A 30,000-LITRE RAINWATER TANK WILL HARVEST RAINWATER FROM THE HARVEST RAINWATER FROM THE

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APARTMENT ROOF AND TOWNHOUSE ROOFS RESPECTIVELY. THESE TANKS WILL BE
CONNECTED TO ALL TOILETS.

15. A MELBOURNE STORM RATING OF 102% IS ACHIEVED.

16. ALL LANDSCAPING IS TO BE NATIVE SPECIES OR LANDSCAPING IRRIGATION IS TO
BE CONNECTED TO THE RAINWATER TANK ONLY.

17. IN TOTAL 62 BICYCLE SPACES ARE TO BE PROVIDED FOR RESIDENTS. 18. IN TOTAL 2 BICYCLE SPACES ARE TO BE PROVIDED FOR STAFF.

19. IN TOTAL 16 BICYCLE SPACES ARE TO BE PROVIDED FOR RESIDENTIAL AND 19. IN TOTAL TO BILTYCLE SPACES ARE TO BE PROVIDED FOR RESIDENTIAL AND NON-RESIDENTIAL VISITORS.
20. ONE CHARGING POINT FOR ELECTRICAL VEHICLES IS INTEGRATED IN THE PROPOSED DEVELOPMENT.
21. 141M2 OF COMMUNAL SPACE WILL BE PROVIDED AT THE ROOFTOP DECK.
22. 24M2 OF COMMUNAL FOOD PRODUCTION AREA WILL BE PROVIDED. REFER TO ESD CONSULANTS DOCUMENTATION FOR FULL DETAILS

No. Date Description 15.03.2023 Issued for RFI Response 1 27.07.2023 Amended TP Submission

TOWN PLANNING NOT FOR CONSTRUCTION





Kerstin Thompson Architects Pty Ltd 277 Queensberry St, Melbourne Australia 3000 T +61 3 8662 8800 kta@kerstinthompson.com

DRAWING TITLE GARDEN AREA PLAN

97 Alma Road AT St Kilda East


FOR Neometro

27.07.2023 JL As indicated(A1) 2202

www.kerstinthompson.com

City of Port Phillip Advertised Plan Planning Application No. PDPL/00823/2022 No. of Pages: 8 of 50



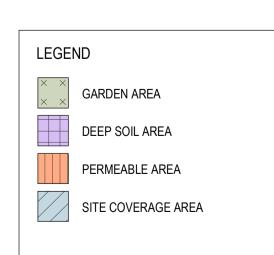


TOTAL DEEP SOIL AREA: 793m² TOTAL SITE AREA: 4997m²

DEEP SOIL AREA AS PERCENTAGE OF SITE AREA : 16%

DOCUMENTATION.

SURVEY: EXISTING SITE INFORMATION IS TAKEN FROM VERIS SURVEY NUMBER 303981-BG DATED 06/07/2023 AND IS PROVIDED HERE FOR ILLUSTRATIVE PURPOSES ONLY. FOR FULL SURVEY

DETAILS REFER TO SURVEY DOCUMENTS PROVIDED WITHIN APPENDICIES! LANDSCAPE DESIGN: LANDSCAPE DESIGN IS SHOWN INDICATIVELY. FOR FULL LANDSCAPE DETAILS REFER TO LANDSCAPE ARCHITECT'S

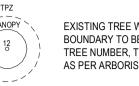

EXISTING TREE WITHIN PROJECT BOUNDARY TO BE RETAINED. TREE NUMBER, TPZ AND CANOPY AS PER ARBORIST REPORT

ABBREVIATIONS: AC CONDENSER UNIT

CL CLOTHES LINE
ELEC ELECTRICAL SERVICES

HYDR HYDRAULIC SERVICES COM COMMS SERVICES

FCL FINISHED CEILING LEVEL
FFL FINISHED FLOOR LEVEL FHR FIRE HOSE REEL FHY FIRE HYDRANT FIP FIRE INDICATOR PANEL

FW FLOOR WASTE NGL NATURAL GROUND LEVEL RELATIVE LEVEL TP WATER TAP
HW HOT WATER UNIT

HP HEAT PUMP HOT WATER UNIT OW OPERABLE WINDOW

__ MATERIALS

BR1 BRICK WORK - BAGGED TEXTURE FINISH
BR2 BREEZE BLOCK
FC1 PAINTED FIBRE CEMENT SHEET TL1 EXTERNAL TILE SC1 SUN SHADESCREEN MT1 VERTICAL ALUMINIUM BALUSTRADE MT2 GLAVANISED STEEL CLADDING MT3 METAL PERGOLA GL1 GLAZING - DOUBLE CLEAR
GL2 OBSCURE GLAZING - REEDED MS1 CABLE MESH MS2 MESH FENCING MS3 MESH SCREEN AS1 ACOUSTIC WALL PANEL

SR1 SAFETY GUARD RAIL

ESD:
1. THE PROJECT ACHIEVES A TOTAL BESS SCORE OF 73% WITH NO MANDATORY 1. THE PROJECT ACHIEVES A TOTAL BESS SCORE OF 73% WITH NO MANDATORY CATEGORY (IEQ, ENERGY, WATER, STORMWATER) BELOW 50%.
2. 100% (41 OUT OF 41) OF THE DEVELOPMENT'S APARTMENTS AND 100% (21 OUT OF 21) OF THE DEVELOPMENT'S TOWNHOUSES ARE NATURALLY CROSS-VENTILATED.
3. DAYLIGHT MODELLING HAS BEEN CONDUCTED FOR A REPRESENTATIVE SAMPLE OF APARTMENTS. THE SUMMARY RESULT IS AS FOLLOWS:

- 88% OF LIVING FLOOR AREA ACHIEVES >90% ABOVE DF 1

- 92% OF BEDROOM FLOOR AREA ACHIEVES >90% ABOVE DF 0.5 - 92% OF BEDROOM FLOOR AREA ACHIEVES > 90% ABOVE DF0.5

4. THE NON-RESIDENTIAL AREAS ARE TARGETING A 2% DF TO 40% OF THE NOMINATED AREA.

5. 39% (16 OUT OF 41) OF APARTMENTS ACHIEVE AT LEAST 3 HOURS OF SUNLIGHT.

6. THE DEVELOPMENT IS PROVIDED WITH A COMPREHENSIVE SHADING STRATEGY.

7. THE DEVELOPMENT IS TO ACHIEVE A 7.5 STAR AVERAGE NATHERS ENERGY RATING RESULT FOR THE APARTMENTS AND A 7.0 STAR AVERAGE NATHERS ENERGY RATING RESULT FOR THE TOWNHOUSES.

8. THE NON-RESIDENTIAL AREAS AIM TO REDUCE HEATING AND COOLING ENERGY CONSUMPTION BELOW THE REFERENCE CASE (BCA SECTION J 2019).

9. THE DEVELOPMENT IS TO UTILISE ELECTRIC HEAT PUMP HOT WATER SYSTEM.

10. A 98 KW SOLAR PV SYSTEM IS TO BE LOCATED ON THE ROOF OF THE APARTMENT BUILDING.

11. A 2KW SOLAR PV SYSTEM IS TO BE PROVIDED FOR EACH TOWNHOUSE.

12. INDIVIDUAL COLD WATER AND ELECTRICITY METERS WILL BE PROVIDED TO THE APARTMENTS, TOWNHOUSES AND COMMUNAL AREAS.

13. WATER EFFICIENT FITTINGS AND FIXTURES ARE APPLIED THROUGHOUT.

14. A 32,000-LITRE RAINWATER TANK AND A 30,000-LITRE RAINWATER TANK WILL HARVEST RAINWATER FROM THE APARTMENT ROOF AND TOWNHOUSE ROOFS RESPECTIVELY. THESE TANKS WILL BE CONNECTED TO ALL TOILETS.

15. A MELBOURNE STORM RATING OF 102% IS ACHIEVED.

16. ALL LANDSCAPING IS TO BE PATIVE SPECIES OR LANDSCAPING IRRIGATION IS TO BE CONNECTED TO THE RAINWATER TANK ONLY.

17. IN TOTAL 26 BICYCLE SPACES ARE TO BE PROVIDED FOR RESIDENTIAL AND NON-RESIDENTIAL VISITORS.

19. IN TOTAL 16 BICYCLE SPACES ARE 10 BE PROVIDED FOR RESIDENTIAL AND NON-RESIDENTIAL VISITORS.
20. ONE CHARGING POINT FOR ELECTRICAL VEHICLES IS INTEGRATED IN THE PROPOSED DEVELOPMENT.
21. 141M2 OF COMMUNAL SPACE WILL BE PROVIDED AT THE ROOFTOP DECK.
22. 24M2 OF COMMUNAL FOOD PRODUCTION AREA WILL BE PROVIDED. REFER TO ESD CONSULANTS DOCUMENTATION FOR FULL DETAILS

No. Date Description 15.03.2023 Issued for RFI Response

1 27.07.2023 Amended TP Submission

TOWN PLANNING NOT FOR CONSTRUCTION





__KTA

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DRAWING TITLE
DEEP SOIL AREA PLAN


97 Alma Road

AT St Kilda East Neometro

27.07.2023 JL SCALE PROJE As indicated(A1) 2202

City of Port Phillip Advertised Plan Planning Application No. PDPL/00823/2022 No. of Pages: 9 of 50



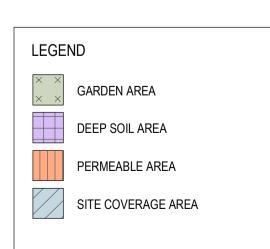

TOTAL PERMEABLE AREA (1013m² TOTAL SITE AREA: 4997m²

PERMEABLE AREA AS PERCENTAGE OF SITE AREA : 20%

APPENDICIES!

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EXISTING TREE WITHIN PROJECT BOUNDARY TO BE RETAINED. TREE NUMBER, TPZ AND CANOPY AS PER ARBORIST REPORT

ABBREVIATIONS: AC CONDENSER UNIT

CL CLOTHES LINE
ELEC ELECTRICAL SERVICES HYDR HYDRAULIC SERVICES COM COMMS SERVICES

FCL FINISHED CEILING LEVEL FFL FINISHED FLOOR LEVEL FHR FIRE HOSE REEL FHY FIRE HYDRANT

FIP FIRE INDICATOR PANEL FW FLOOR WASTE NGL NATURAL GROUND LEVEL RELATIVE LEVEL

TP WATER TAP
HW HOT WATER UNIT HP HEAT PUMP HOT WATER UNIT OW OPERABLE WINDOW

__ MATERIALS

BR1 BRICK WORK - BAGGED TEXTURE FINISH
BR2 BREEZE BLOCK
FC1 PAINTED FIBRE CEMENT SHEET TL1 EXTERNAL TILE SC1 SUN SHADESCREEN MT1 VERTICAL ALUMINIUM BALUSTRADE MT2 GLAVANISED STEEL CLADDING MT3 METAL PERGOLA GL1 GLAZING - DOUBLE CLEAR
GL2 OBSCURE GLAZING - REEDED MS1 CABLE MESH MS2 MESH FENCING MS3 MESH SCREEN AS1 ACOUSTIC WALL PANEL

SR1 SAFETY GUARD RAIL

ESD:

1. THE PROJECT ACHIEVES A TOTAL BESS SCORE OF 73% WITH NO MANDATORY CATEGORY (IEQ, ENERGY, WATER, STORMWATER) BELOW 50%.

2. 100% (41 OUT OF 41) OF THE DEVELOPMENT'S APARTMENTS AND 100% (21 OUT OF 21) OF THE DEVELOPMENT'S TOWNHOUSES ARE NATURALLY CROSS-VENTILATED.

3. DAYLIGHT MODELLING HAS BEEN CONDUCTED FOR A REPRESENTATIVE SAMPLE OF APARTMENTS. THE SUMMARY RESULT IS AS FOLLOWS:

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4. THE NON-RESIDENTIAL APERS A BET ENGESTING A 2% DE TO 40% OF THE - 88% OF LINING FLOOR AREA ACHIEVES >90% ABOVE DF0.5

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15. A MELBOURNE STORM RATING OF 102% IS ACHIEVED.

16. ALL LANDSCAPING IS TO BE NATIVE SPECIES OR LANDSCAPING IRRIGATION IS TO BE CONNECTED TO THE PRAINWATER TANK ONLY.

17. IN TOTAL 62 BICYCLE SPACES ARE TO BE PROVIDED FOR RESIDENTIAL AND NON-RESIDENTIAL VISITORS.

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No. Date Description 15.03.2023 Issued for RFI Response 1 27.07.2023 Amended TP Submission

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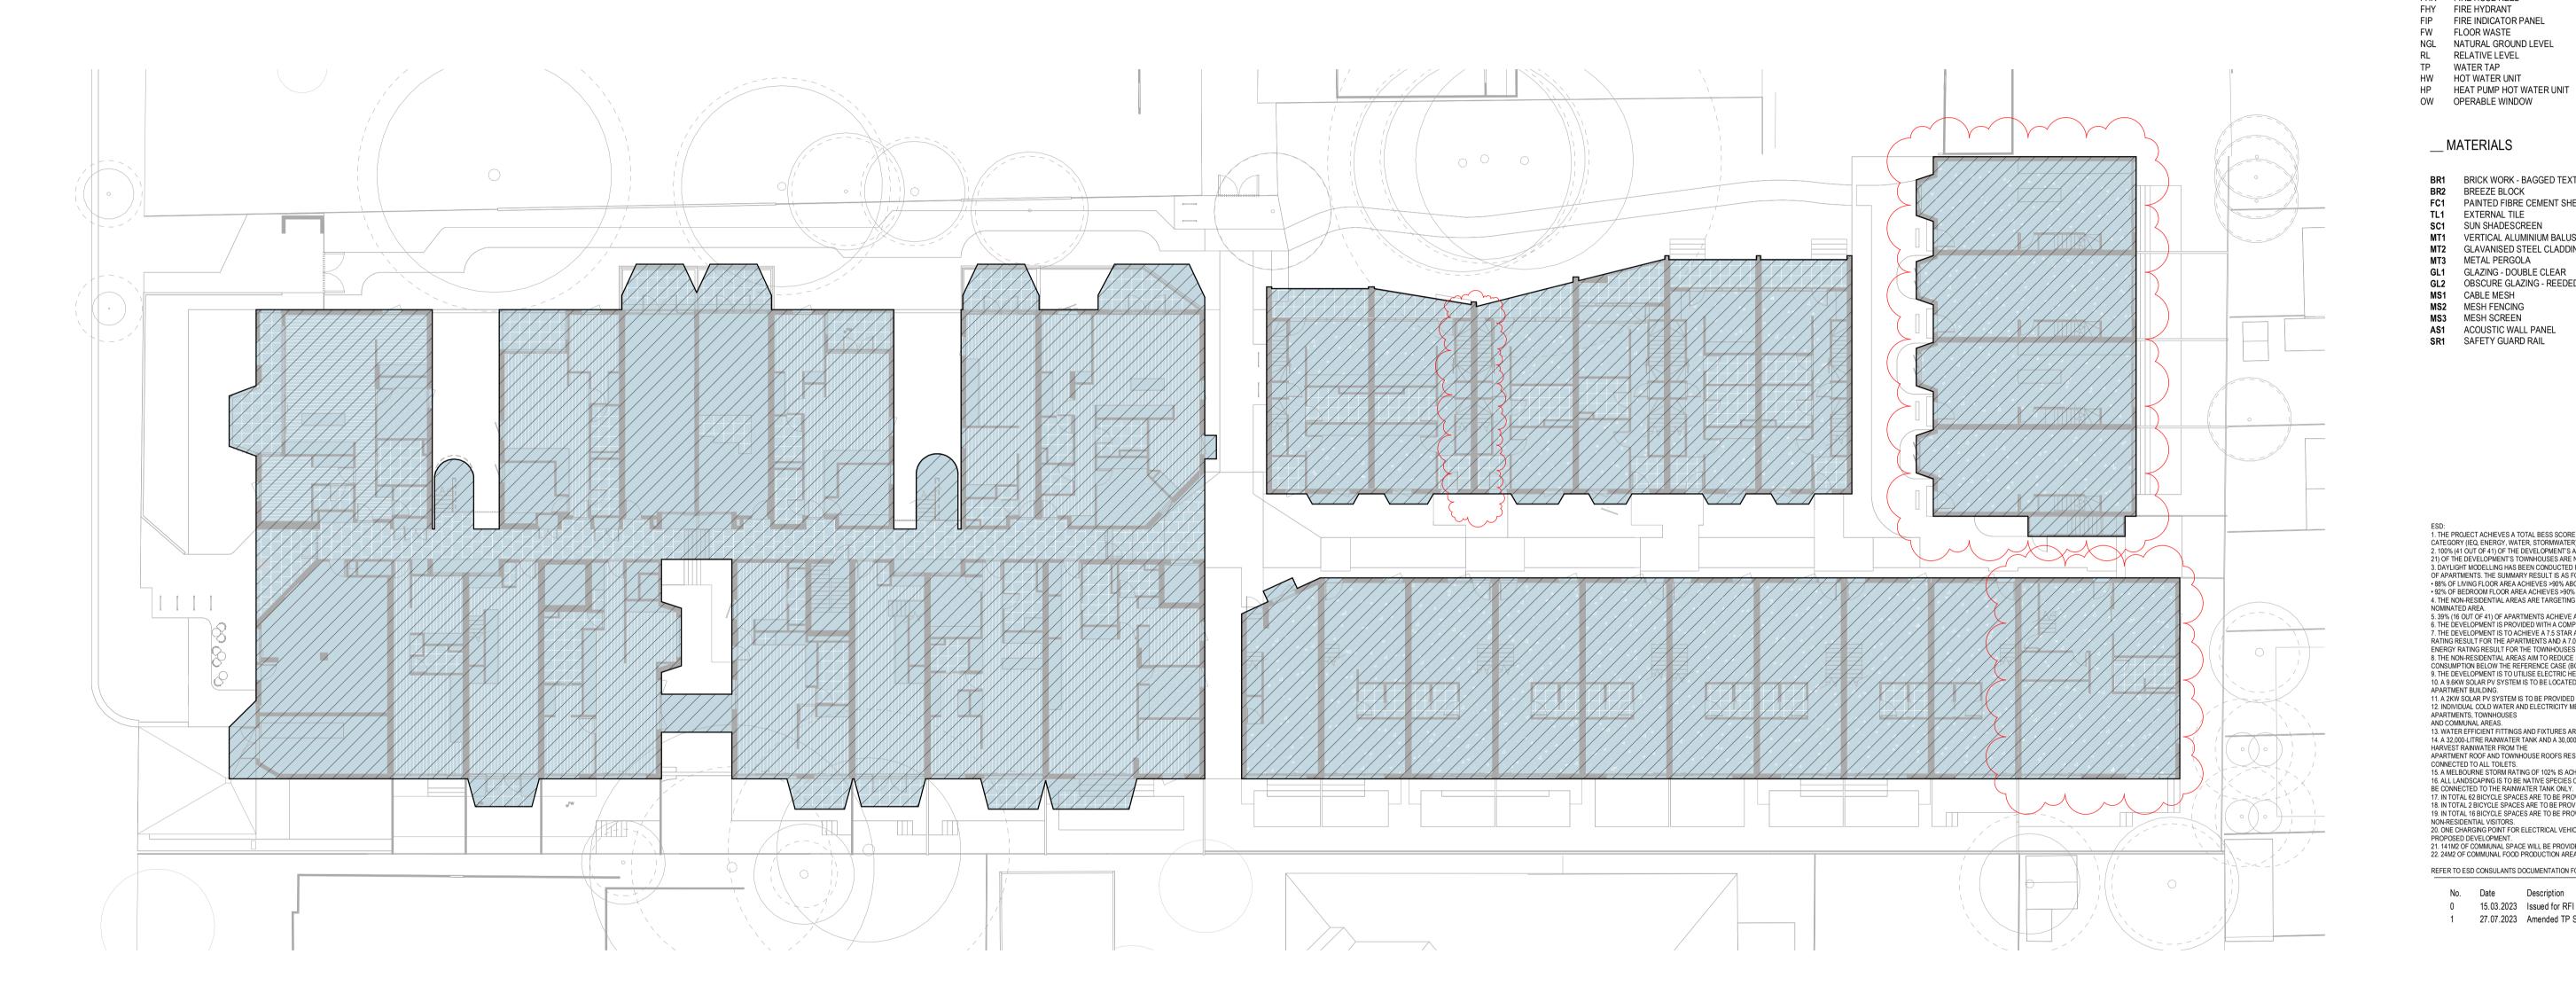
DRAWING TITLE	
PERMEABLE AREA PLAN	


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City of Port Phillip Advertised Plan
Planning Application No. PDPL/00823/2022
No. of Pages: 10 of 50





TOTAL SITE COVERAGE AREA: 2956m² TOTAL SITE AREA: 4997m²


SITE COVERAGE AREA AS PERCENTAGE OF SITE AREA : 59%

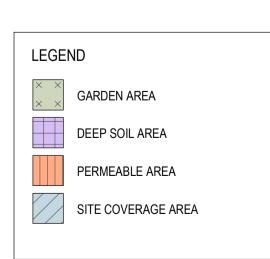APPENDICIES!

ABBREVIATIONS: AC CONDENSER UNIT

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EXISTING TREE WITHIN PROJECT BOUNDARY TO BE RETAINED. TREE NUMBER, TPZ AND CANOPY AS PER ARBORIST REPORT

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HW HOT WATER UNIT

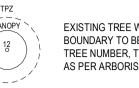__ MATERIALS

BR1 BRICK WORK - BAGGED TEXTURE FINISH
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FC1 PAINTED FIBRE CEMENT SHEET TL1 EXTERNAL TILE SC1 SUN SHADESCREEN
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3. DAYLIGHT MODELLING HAS BEEN CONDUCTED FOR A REPRESENTATIVE SAMPLE OF APARTMENTS. THE SUMMARY RESULT IS AS FOLLOWS:

• 88% OF LIVING FLOOR AREA ACHIEVES >90% ABOVE DF 1

• 92% OF BEDROOM FLOOR AREA ACHIEVES >90% ABOVE DF 1

• 92% OF BEDROOM FLOOR AREA ACHIEVES >90% ABOVE DF 1 - 88% OF LINING FLOOR AREA ACHIEVES >90% ABOVE DF0.5

4. THE NON-RESIDENTIAL AREAS ARE TARGETING A 2% DF TO 40% OF THE NOMINATED AREA.

5. 39% (16 OUT OF 41) OF APARTMENTS ACHIEVE AT LEAST 3 HOURS OF SUNLIGHT.

6. THE DEVELOPMENT IS PROVIDED WITH A COMPREHENSIVE SHADING STRATEGY.

7. THE DEVELOPMENT IS PROVIDED WITH A COMPREHENSIVE SHADING STRATEGY.

7. THE DEVELOPMENT IS TO ACHIEVE A 7.5 STAR AVERAGE NATHERS ENERGY RATING RESULT FOR THE APARTMENTS AND A 7.0 STAR AVERAGE NATHERS ENERGY RATING RESULT FOR THE TOWNHOUSES.

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9. THE DEVELOPMENT IS TO UTILISE ELECTRIC HEAT PUMP HOT WATER SYSTEM.

10. A 9.6KW SOLAR PV SYSTEM IS TO BE LOCATED ON THE ROOF OF THE APARTMENT BUILDING.

11. A 2KW SOLAR PV SYSTEM IS TO BE PROVIDED FOR EACH TOWNHOUSE.

12. INDIVIDUAL COLD WATER AND ELECTRICITY METERS WILL BE PROVIDED TO THE APARTMENTS, TOWNHOUSES

AND COMMUNAL AREAS.

13. WATER EFFICIENT FITTINGS AND FIXTURES ARE APPLIED THROUGHOUT.

14. A 32.000-LITER ERAINWATER TANK AND A 30,000-LITRE RAINWATER TANK WILL HARVEST RAINWATER FROM THE APARTMENT FOOP AND TOWNHOUSE ROOFS RESPECTIVELY. THESE TANKS WILL BE CONNECTED TO ALL TOILETS.

15. A MELBOURNE STORM RATING OF 102% IS ACHIEVED.

16. ALL LANDSCAPING IS TO BE NATIVE SPECIES OR LANDSCAPING IRRIGATION IS TO BE CONNECTED TO THE PRAINWATER TANK ONLY.

17. IN TOTAL 62 BICYCLE SPACES ARE TO BE PROVIDED FOR RESIDENTIAL AND NON-RESIDENTIAL VISITORS.

20. ONE CHARGING POINT FOR ELECTRICAL VEHICLES IS INTEGRATED IN THE PROPOSED DEVELOPMENT.

21. 141M2 OF COMMUNAL SPACE WILL BE PROVIDED AT THE ROOFTOP DECK.

22. 24M2 OF COMMUNAL FOOD PRODUCTION AREA WILL BE PROVIDED.

REFER TO ESD CONSULANTS DOCUMENTATION FOR FULL DETAILS

No. Date Description 0 15.03.2023 Issued for RFI Response 1 27.07.2023 Amended TP Submission

TOWN PLANNING NOT FOR CONSTRUCTION






Kerstin Thompson Architects Pty Ltd 277 Queensberry St, Melbourne Australia 3000 T +61 3 8662 8800 kta@kerstinthompson.com www.kerstinthompson.com

DRAWING TITLE SITE COVERAGE AREA PLAN

97 Alma Road AT St Kilda East Neometro


27.07.2023 JL SCALE PROJE As indicated(A1) 2202

City of Port Phillip Advertised Plan Planning Application No. PDPL/00823/2022 No. of Pages: 11 of 50

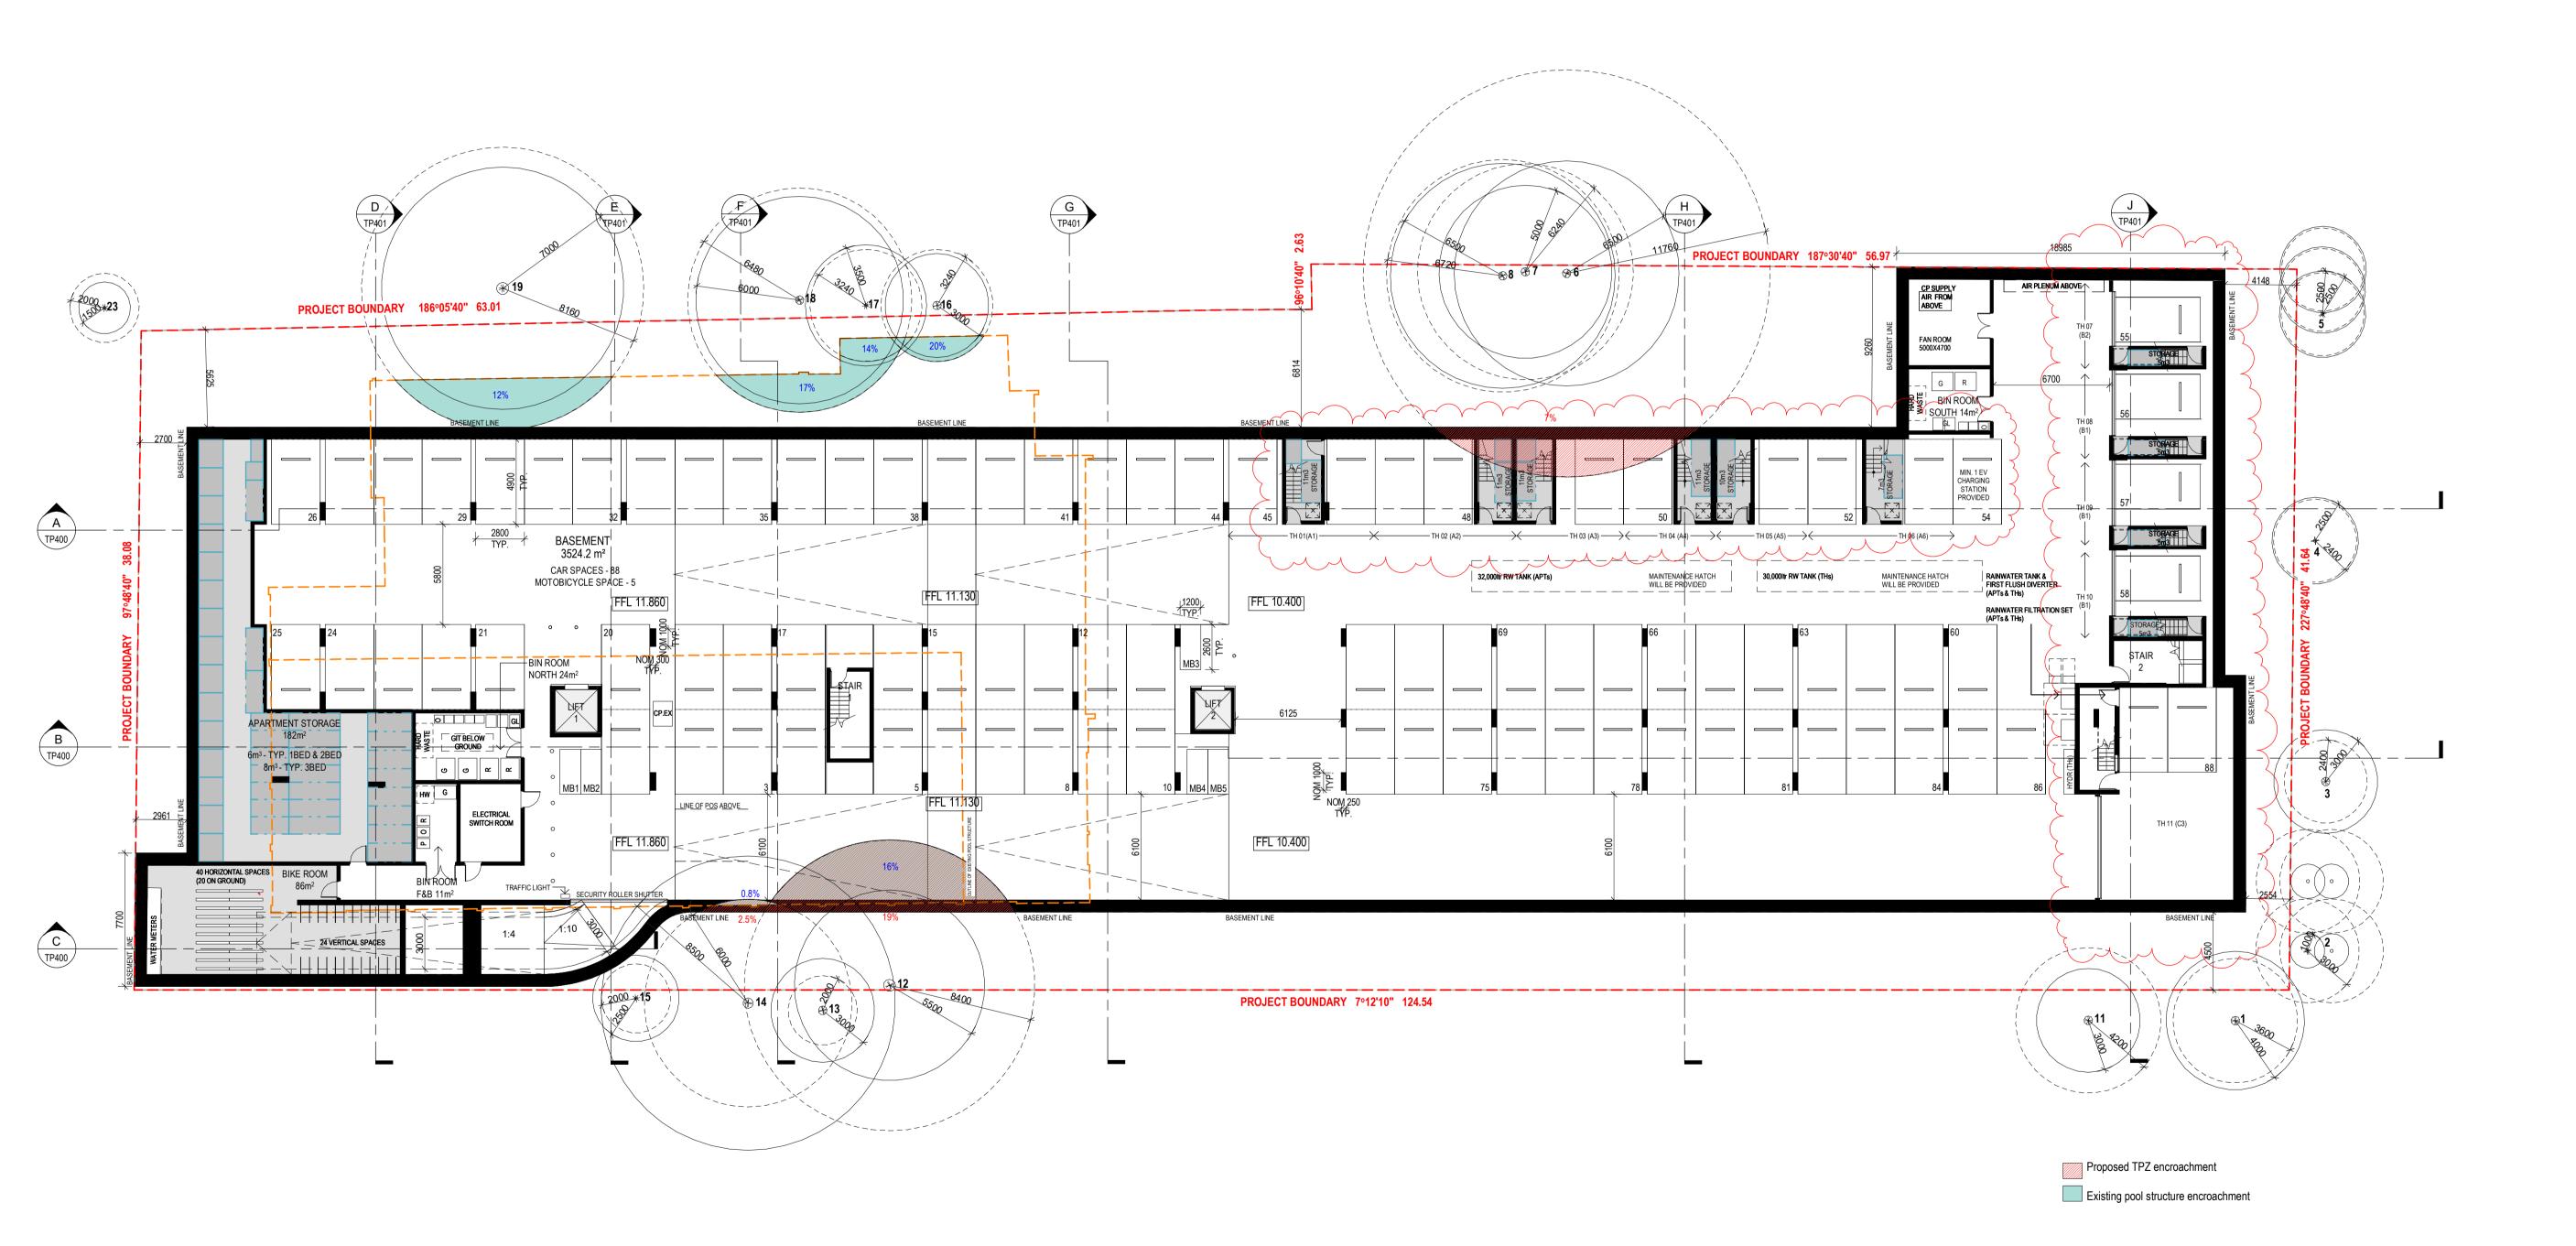

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LANDSCAPE DESIGN: LANDSCAPE DESIGN IS SHOWN INDICATIVELY. FOR FULL LANDSCAPE DETAILS REFER TO LANDSCAPE ARCHITECT'S DOCUMENTATION.

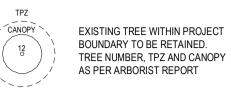

ABBREVIATIONS:

AC CONDENSER UNIT

CL CLOTHES LINE
ELEC ELECTRICAL SERVICES

HYDR HYDRAULIC SERVICES COM COMMS SERVICES FCL FINISHED CEILING LEVEL
FFL FINISHED FLOOR LEVEL

FHR FIRE HOSE REEL FHY FIRE HYDRANT FIP FIRE INDICATOR PANEL

FW FLOOR WASTE NGL NATURAL GROUND LEVEL

RELATIVE LEVEL TP WATER TAP HW HOT WATER UNIT

HP HEAT PUMP HOT WATER UNIT OW OPERABLE WINDOW

__ MATERIALS

BR1 BRICK WORK - BAGGED TEXTURE FINISH
BR2 BREEZE BLOCK
FC1 PAINTED FIBRE CEMENT SHEET TL1 EXTERNAL TILE SC1 SUN SHADESCREEN MT1 VERTICAL ALUMINIUM BALUSTRADE MT2 GLAVANISED STEEL CLADDING MT3 METAL PERGOLA GL1 GLAZING - DOUBLE CLEAR
GL2 OBSCURE GLAZING - REEDED MS1 CABLE MESH MS2 MESH FENCING MS3 MESH SCREEN

AS1 ACOUSTIC WALL PANEL SR1 SAFETY GUARD RAIL

ESD:

1. THE PROJECT ACHIEVES A TOTAL BESS SCORE OF 73% WITH NO MANDATORY CATEGORY (IDEQ, ENERGY, WATER, STORMWATER) BELOW 50%.

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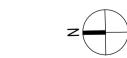
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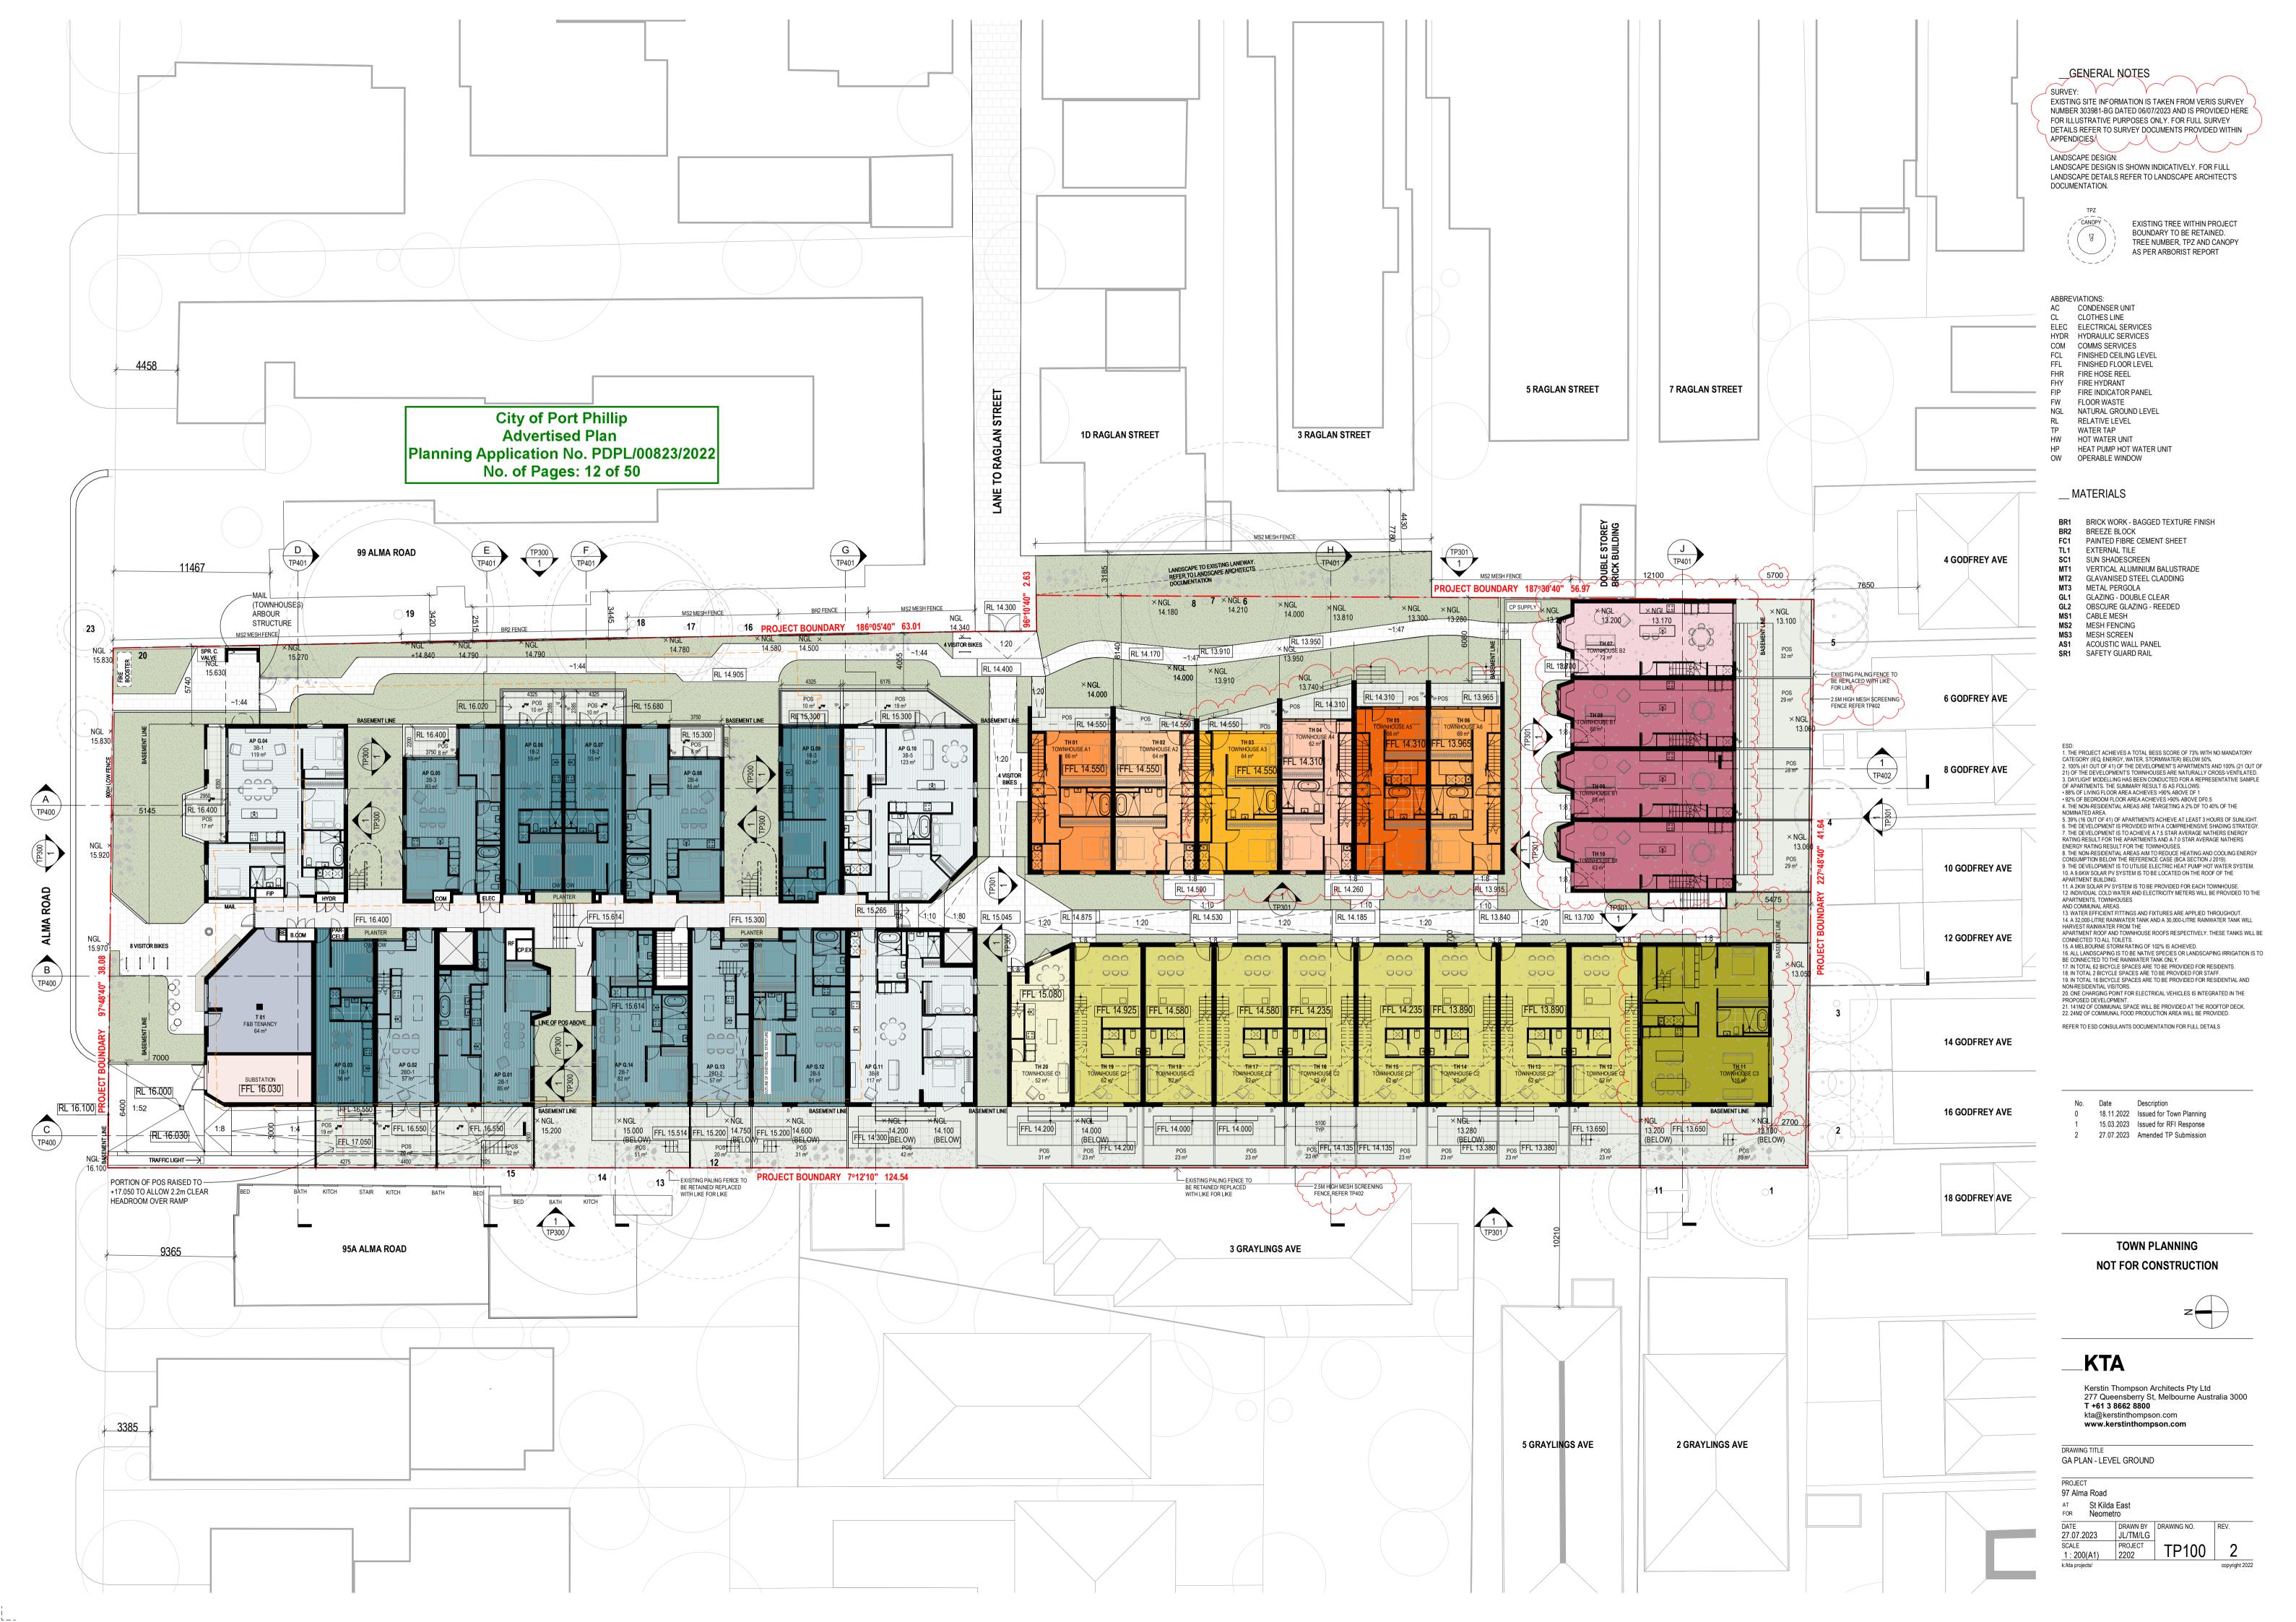
Kerstin Thompson Architects Pty Ltd 277 Queensberry St, Melbourne Australia 3000 T +61 3 8662 8800 kta@kerstinthompson.com www.kerstinthompson.com

DRAWING TITLE GA PLAN - LEVEL BASEMENT B1


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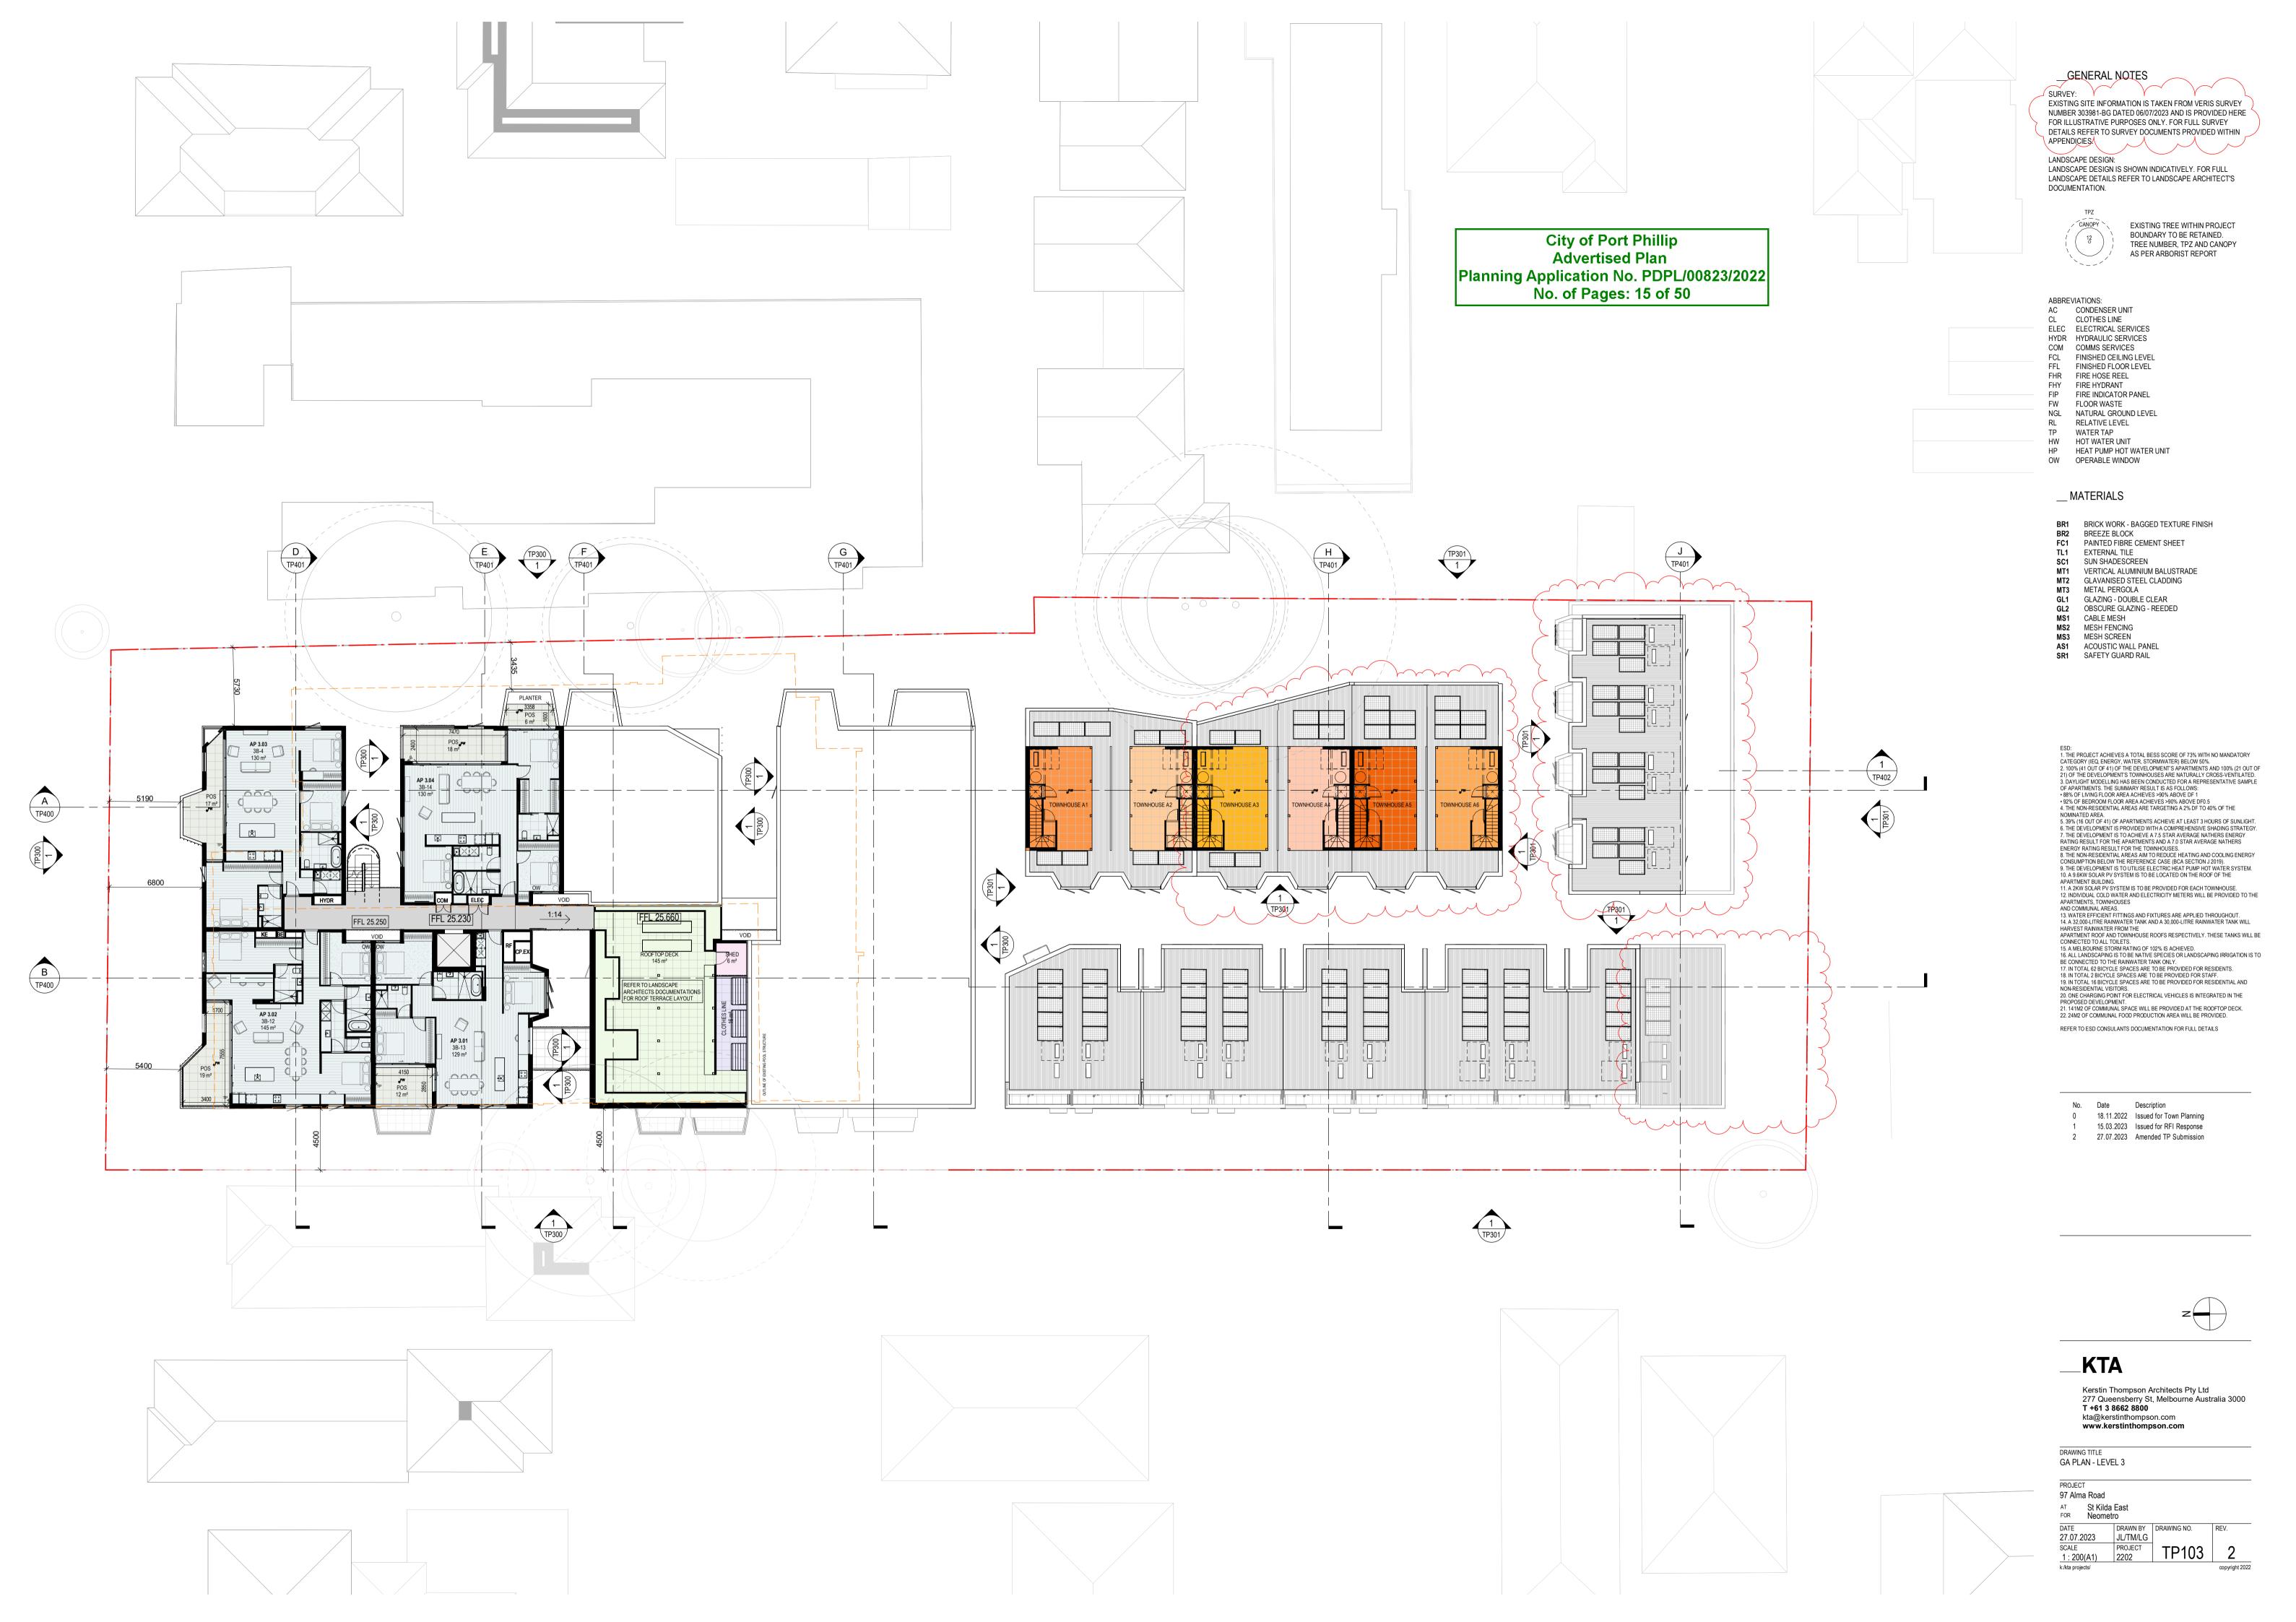
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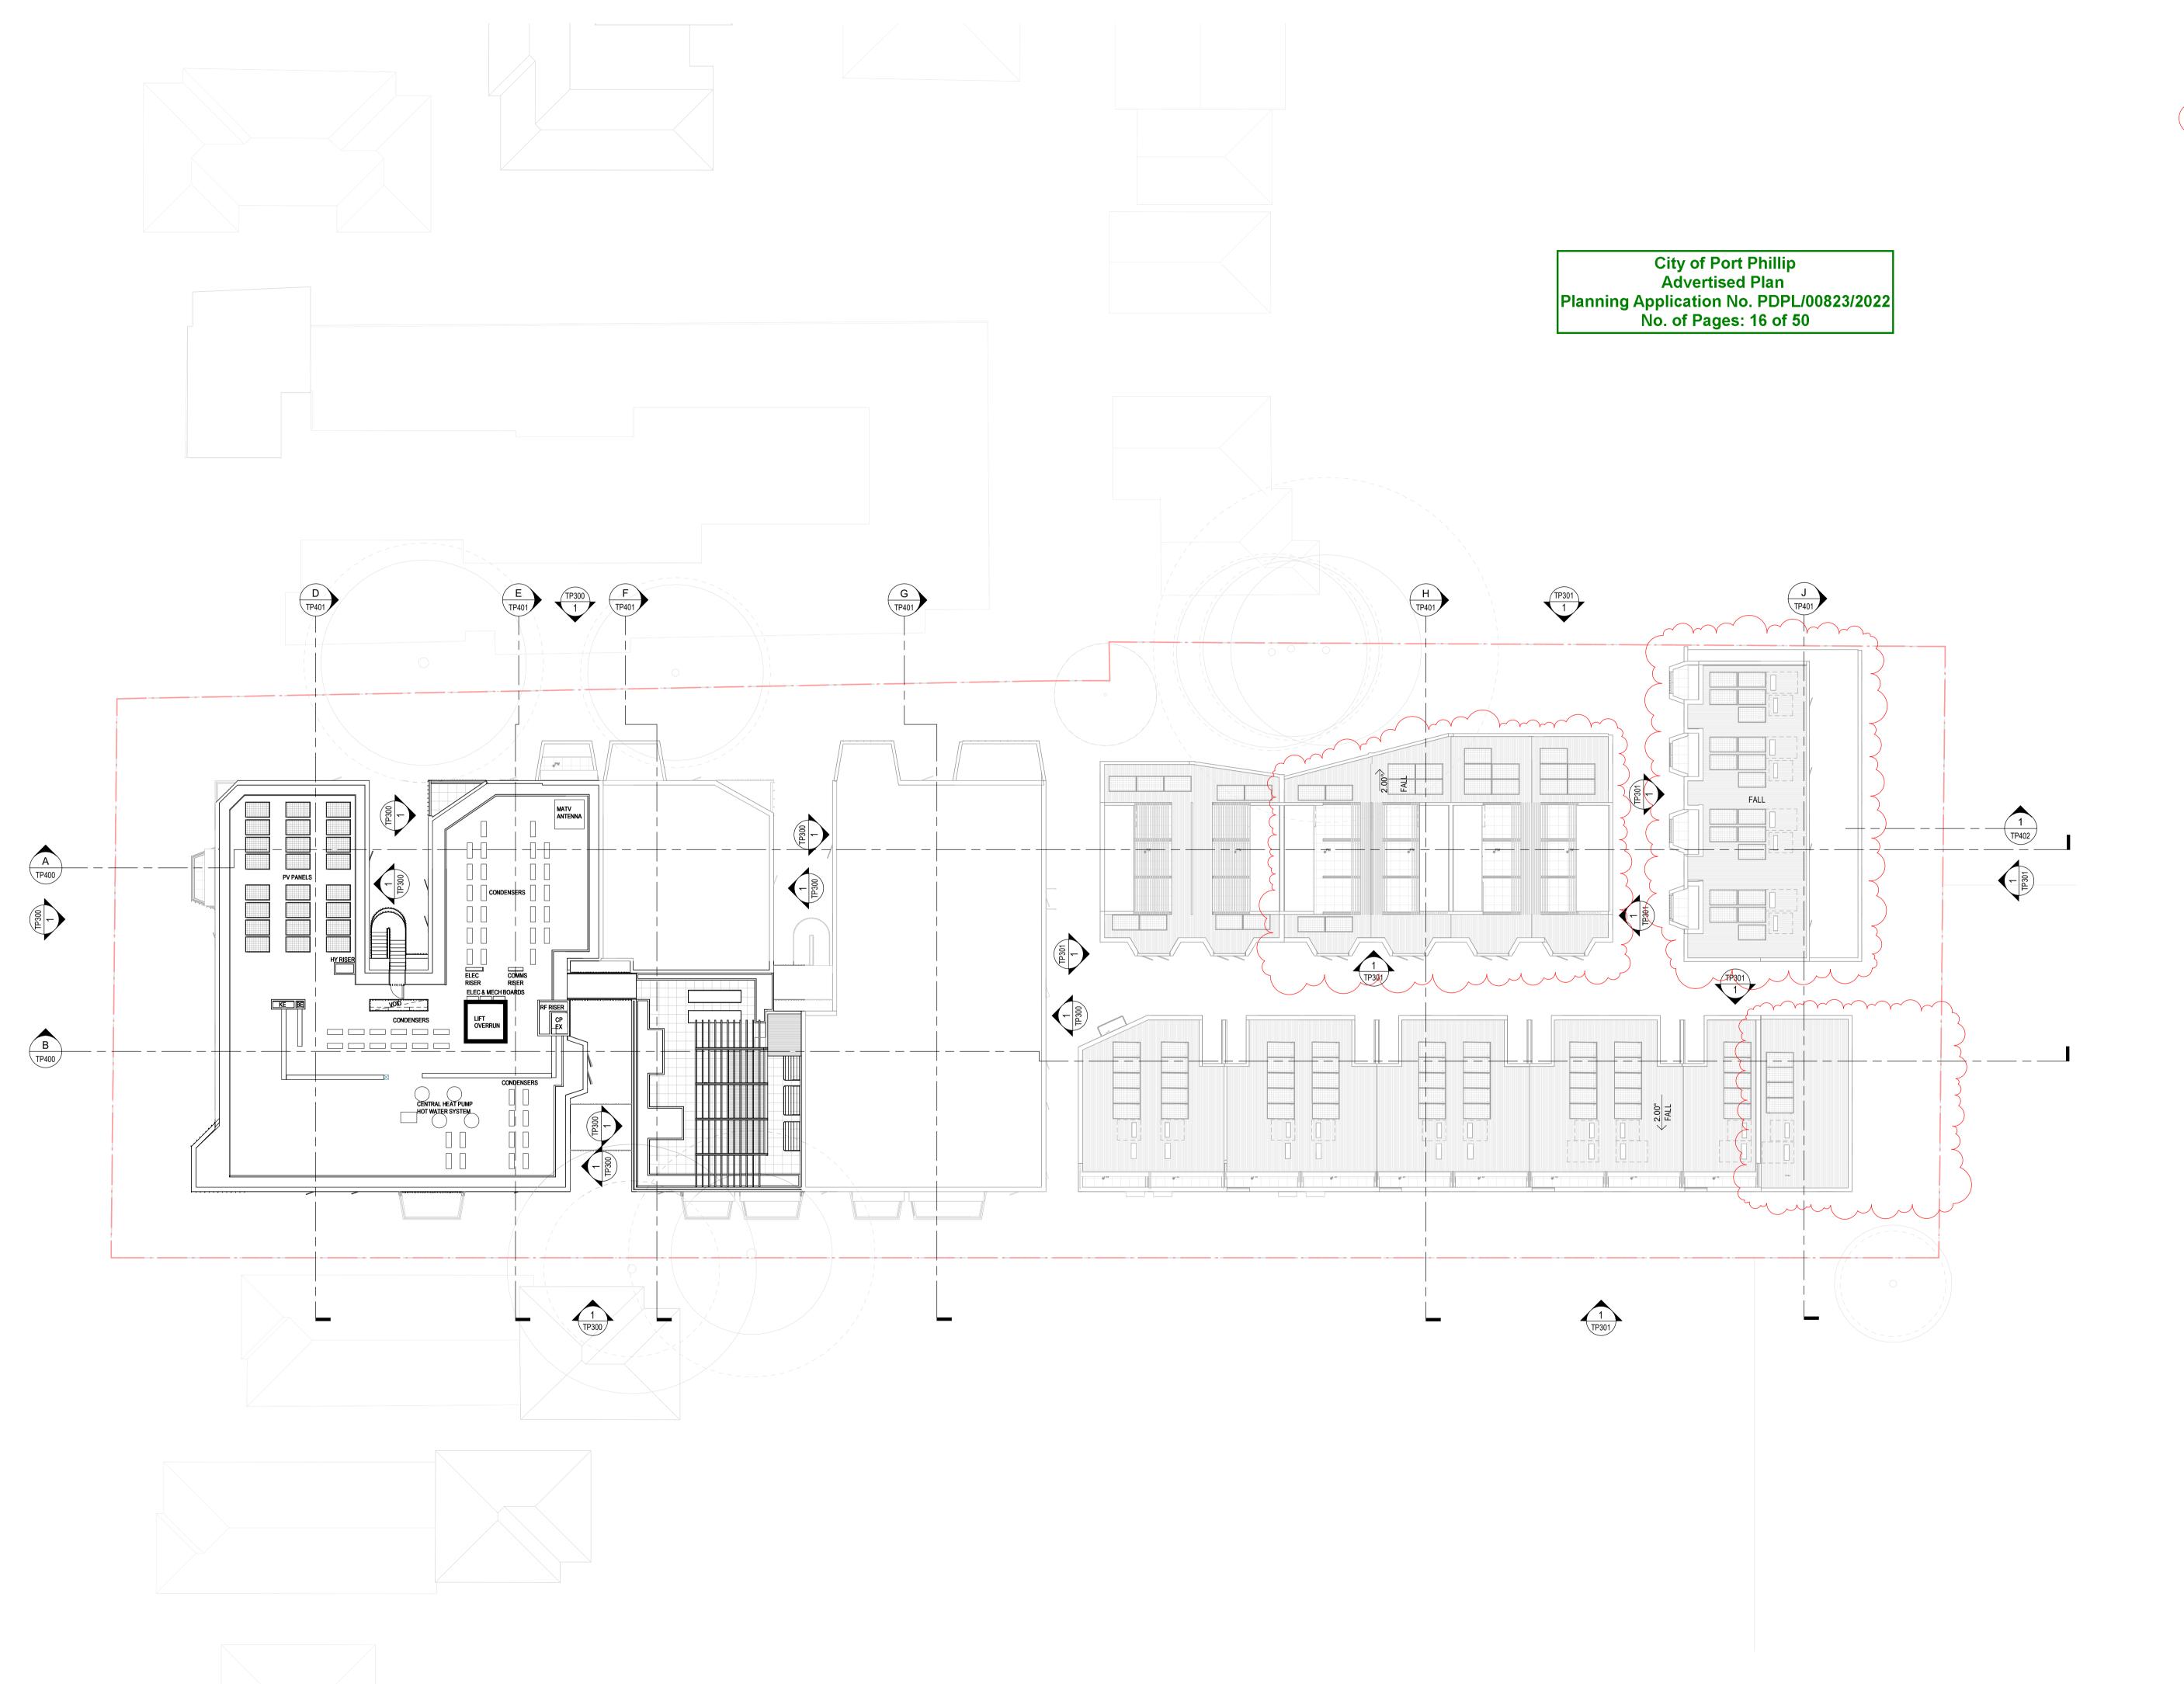
DATE 27.07.2023 JL/TM/LG
SCALE PROJECT 1: 200(A1) 2202 TP1E









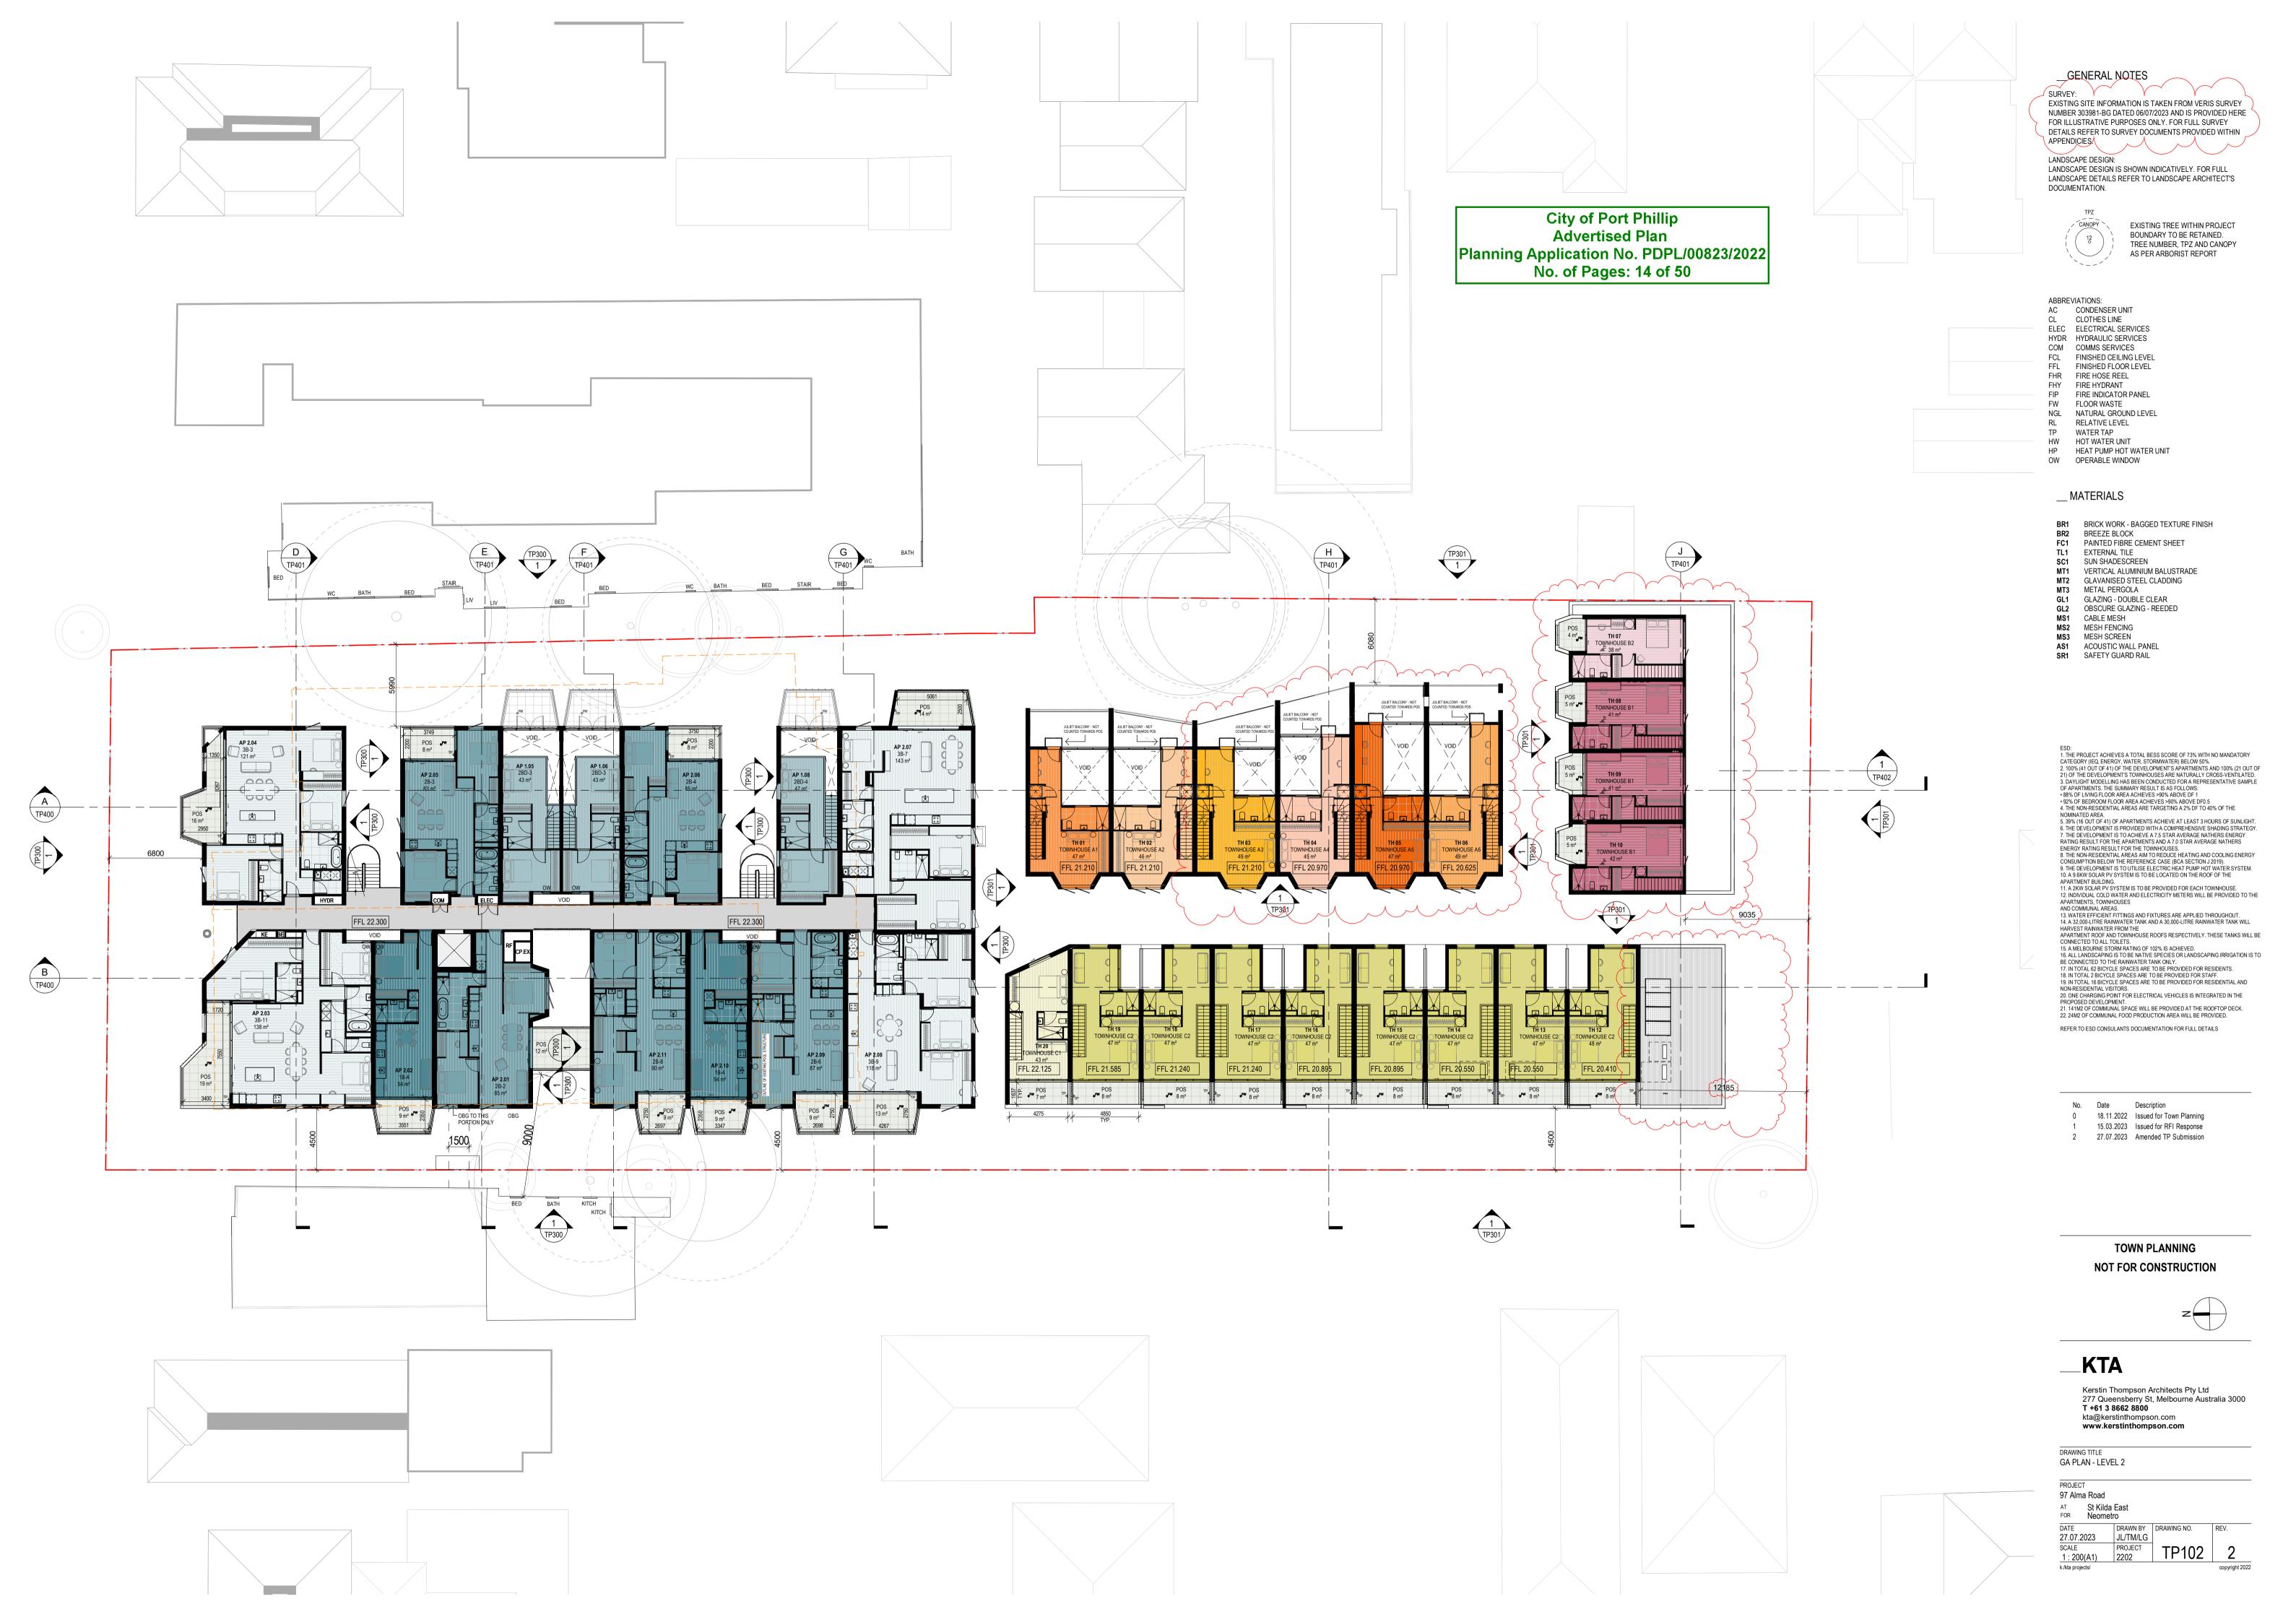

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EXISTING TREE WITHIN PROJECT BOUNDARY TO BE RETAINED. TREE NUMBER, TPZ AND CANOPY AS PER ARBORIST REPORT

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AC CONDENSER UNIT

CL CLOTHES LINE
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__KTA

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DRAWING TITLE GA PLAN - LEVEL ROOF

97 Alma Road

AT St Kilda East Neometro

27.07.2023 JL/TM/LG SCALE PROJECT





TH GROUND LEVEL FFL 13.750

DOUBLE STOREY
—BRICK BUILDING
NO.5 RAGLAN ST

TP - TH NORTH ELEVATION - 03
1: 200

ACCESS TO STAIRS
DOWN TO BASEMENT

1 GRAYLINGS GROVE (1 STOREY)

EXISTING PALING FENCE TO

— BE RETAINED/ REPLACED

WITH LIKE FOR LIKE

NEW 2.5M HIGH MESH SCREENING

TH GROUND LEVEL FFL 13.750

 $\begin{array}{c} \textcolor{red}{\textbf{08}} \\ \hline \texttt{TP100} \\ \end{array} \hspace{0.1cm} \begin{array}{c} \textcolor{red}{\textbf{TP - TH NORTH ELEVATION - 01}} \\ 1:200 \\ \end{array}$

GENERAL NOTES

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BR1 BRICK WORK - BAGGED TEXTURE FINISH BR2 BREEZE BLOCK

PAINTED FIBRE CEMENT SHEET EXTERNAL TILE

SC1 SUN SHADESCREEN VERTICAL ALUMINIUM BALUSTRADE MT1 MT2

GLAVANISED STEEL CLADDING MT3 METAL PERGOLA

GLAZING - DOUBLE CLEAR OBSCURE GLAZING - REEDED GL2

CABLE MESH MS1 MS2

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ACOUSTIC WALL PANEL SAFETY GUARD RAIL SR1

AS1

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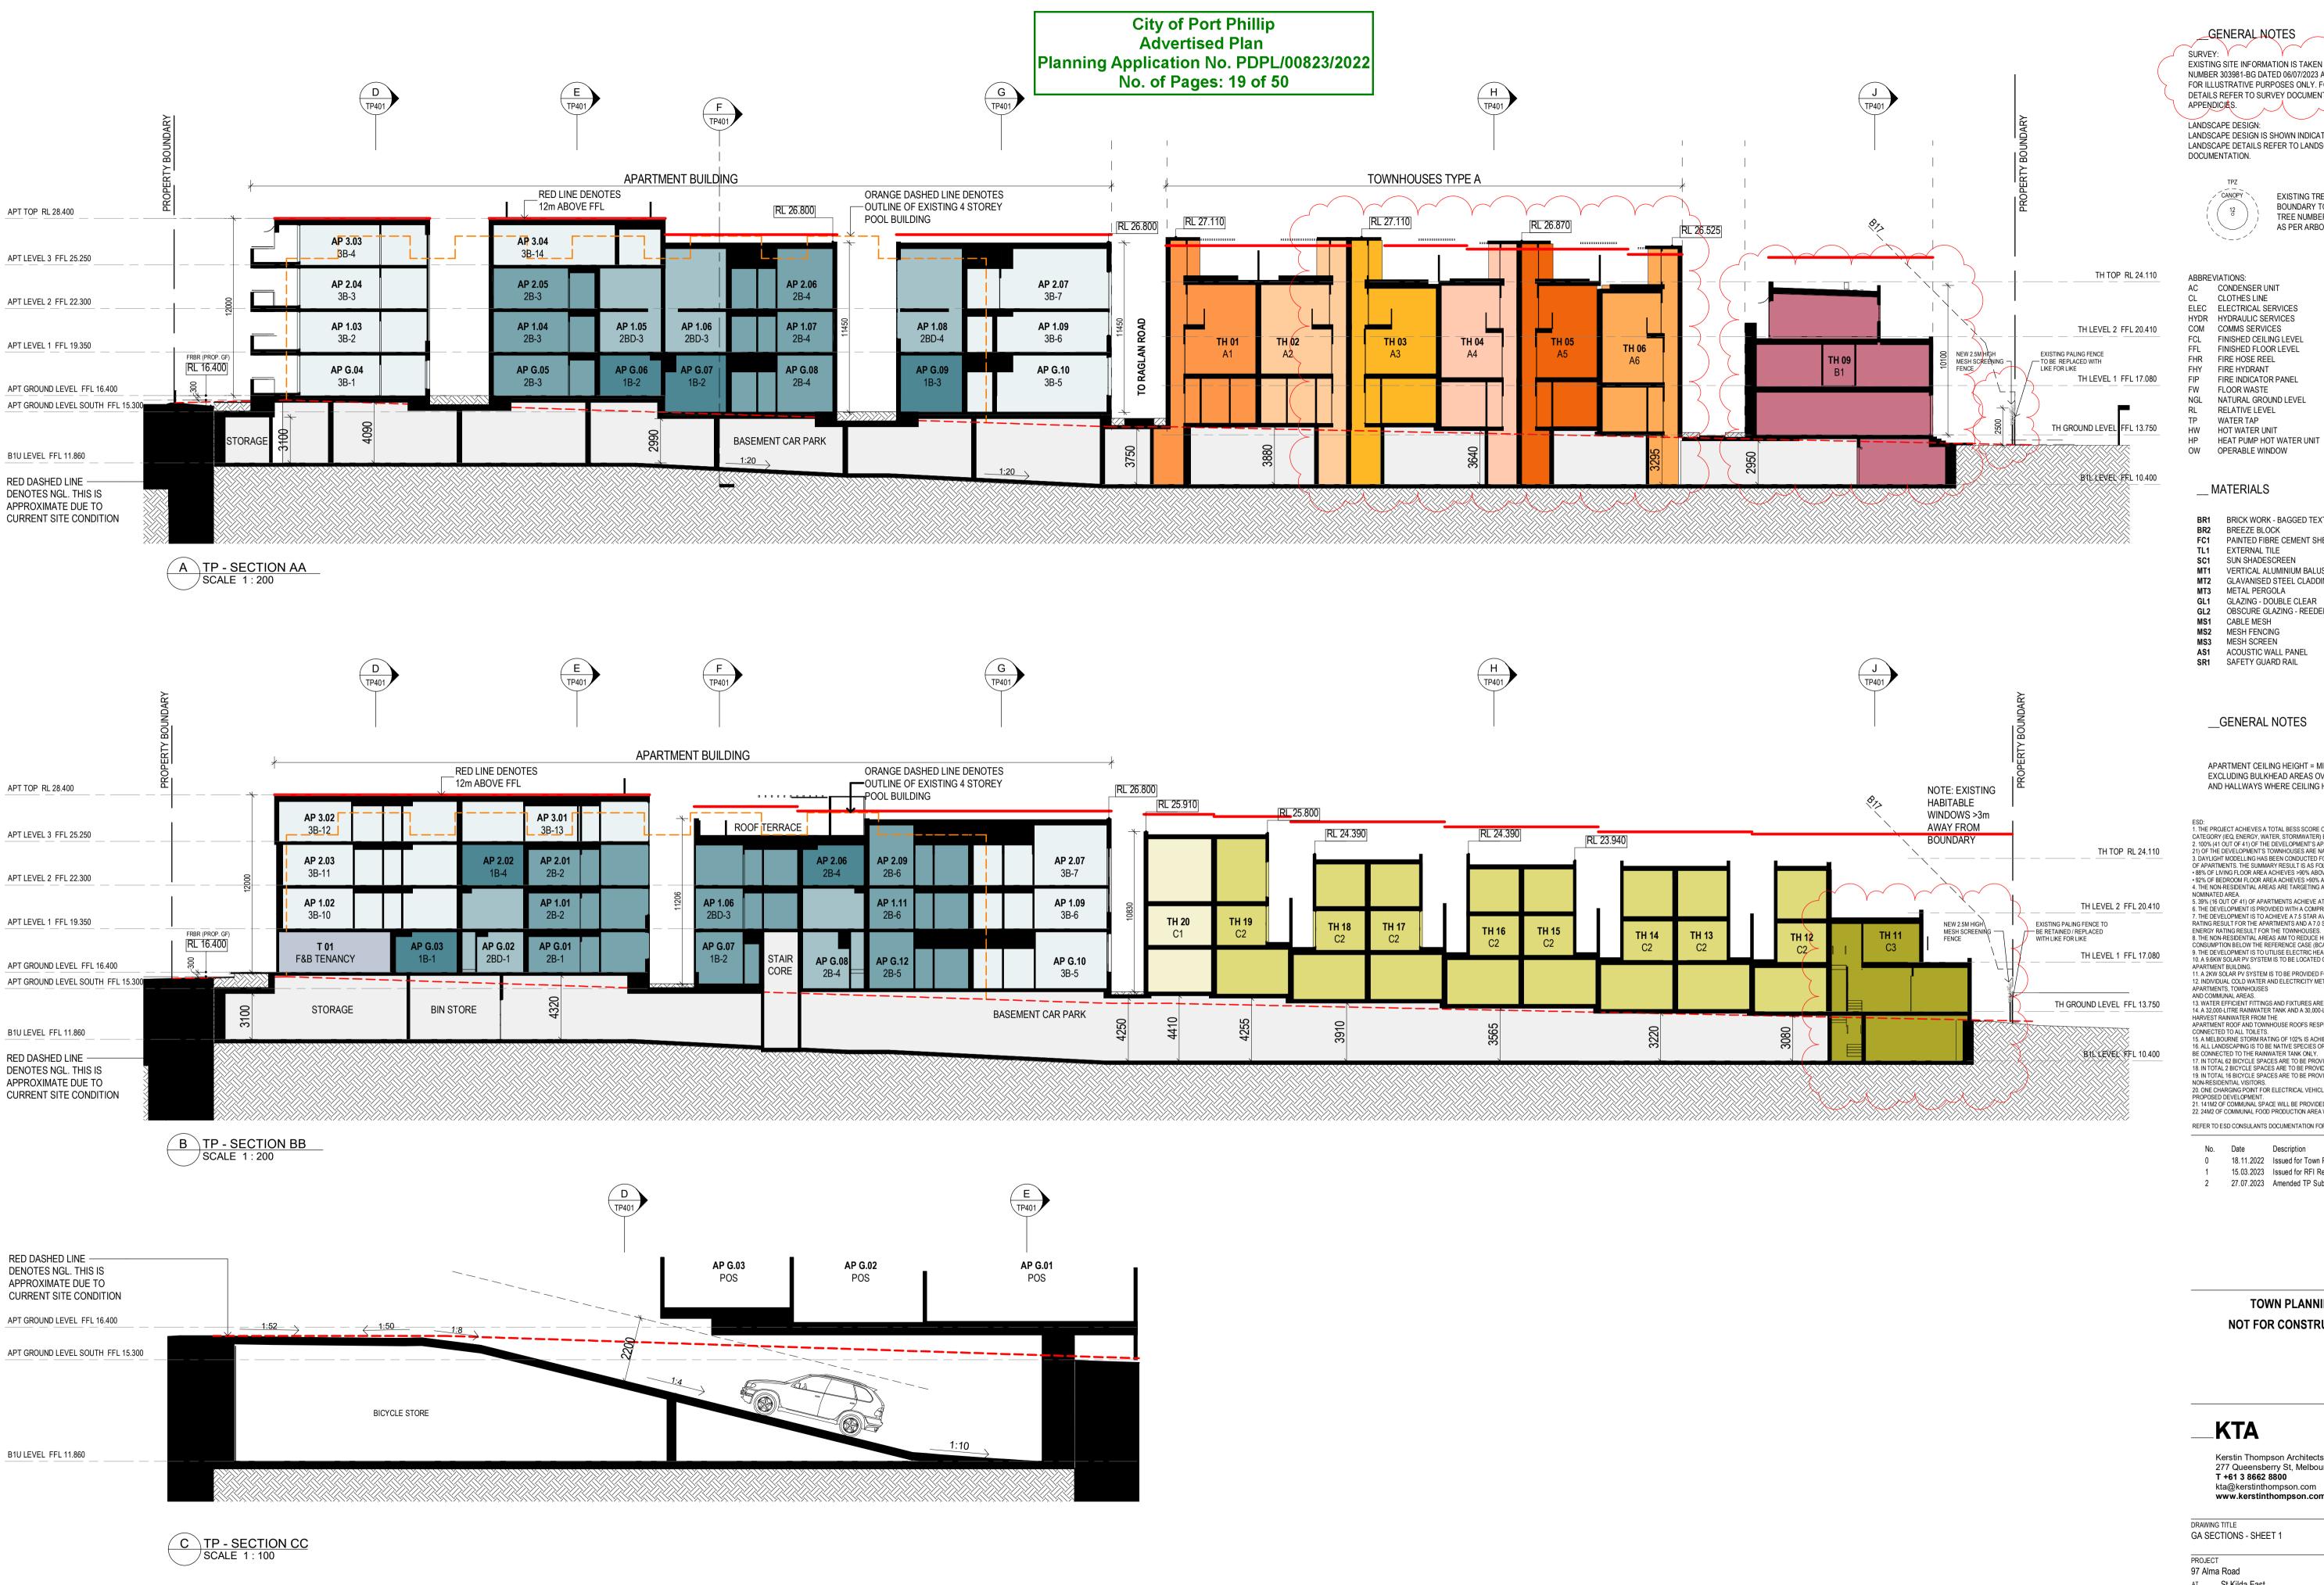
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DRAWING TITLE GA ELEVATIONS - TOWNHOUSES

> PROJECT 97 Alma Road AT St Kilda East Neometro

27.07.2023 JL/TM/LG PROJECT

1 : 200(A1) 2202



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CABLE MESH MESH FENCING MESH SCREEN AS1 ACOUSTIC WALL PANEL

_GENERAL NOTES

APARTMENT CEILING HEIGHT = MIN. 2700mm; EXCLUDING BULKHEAD AREAS OVER JOINERY, BATHROOMS AND HALLWAYS WHERE CEILING HEIGHT = MIN. 2400mm

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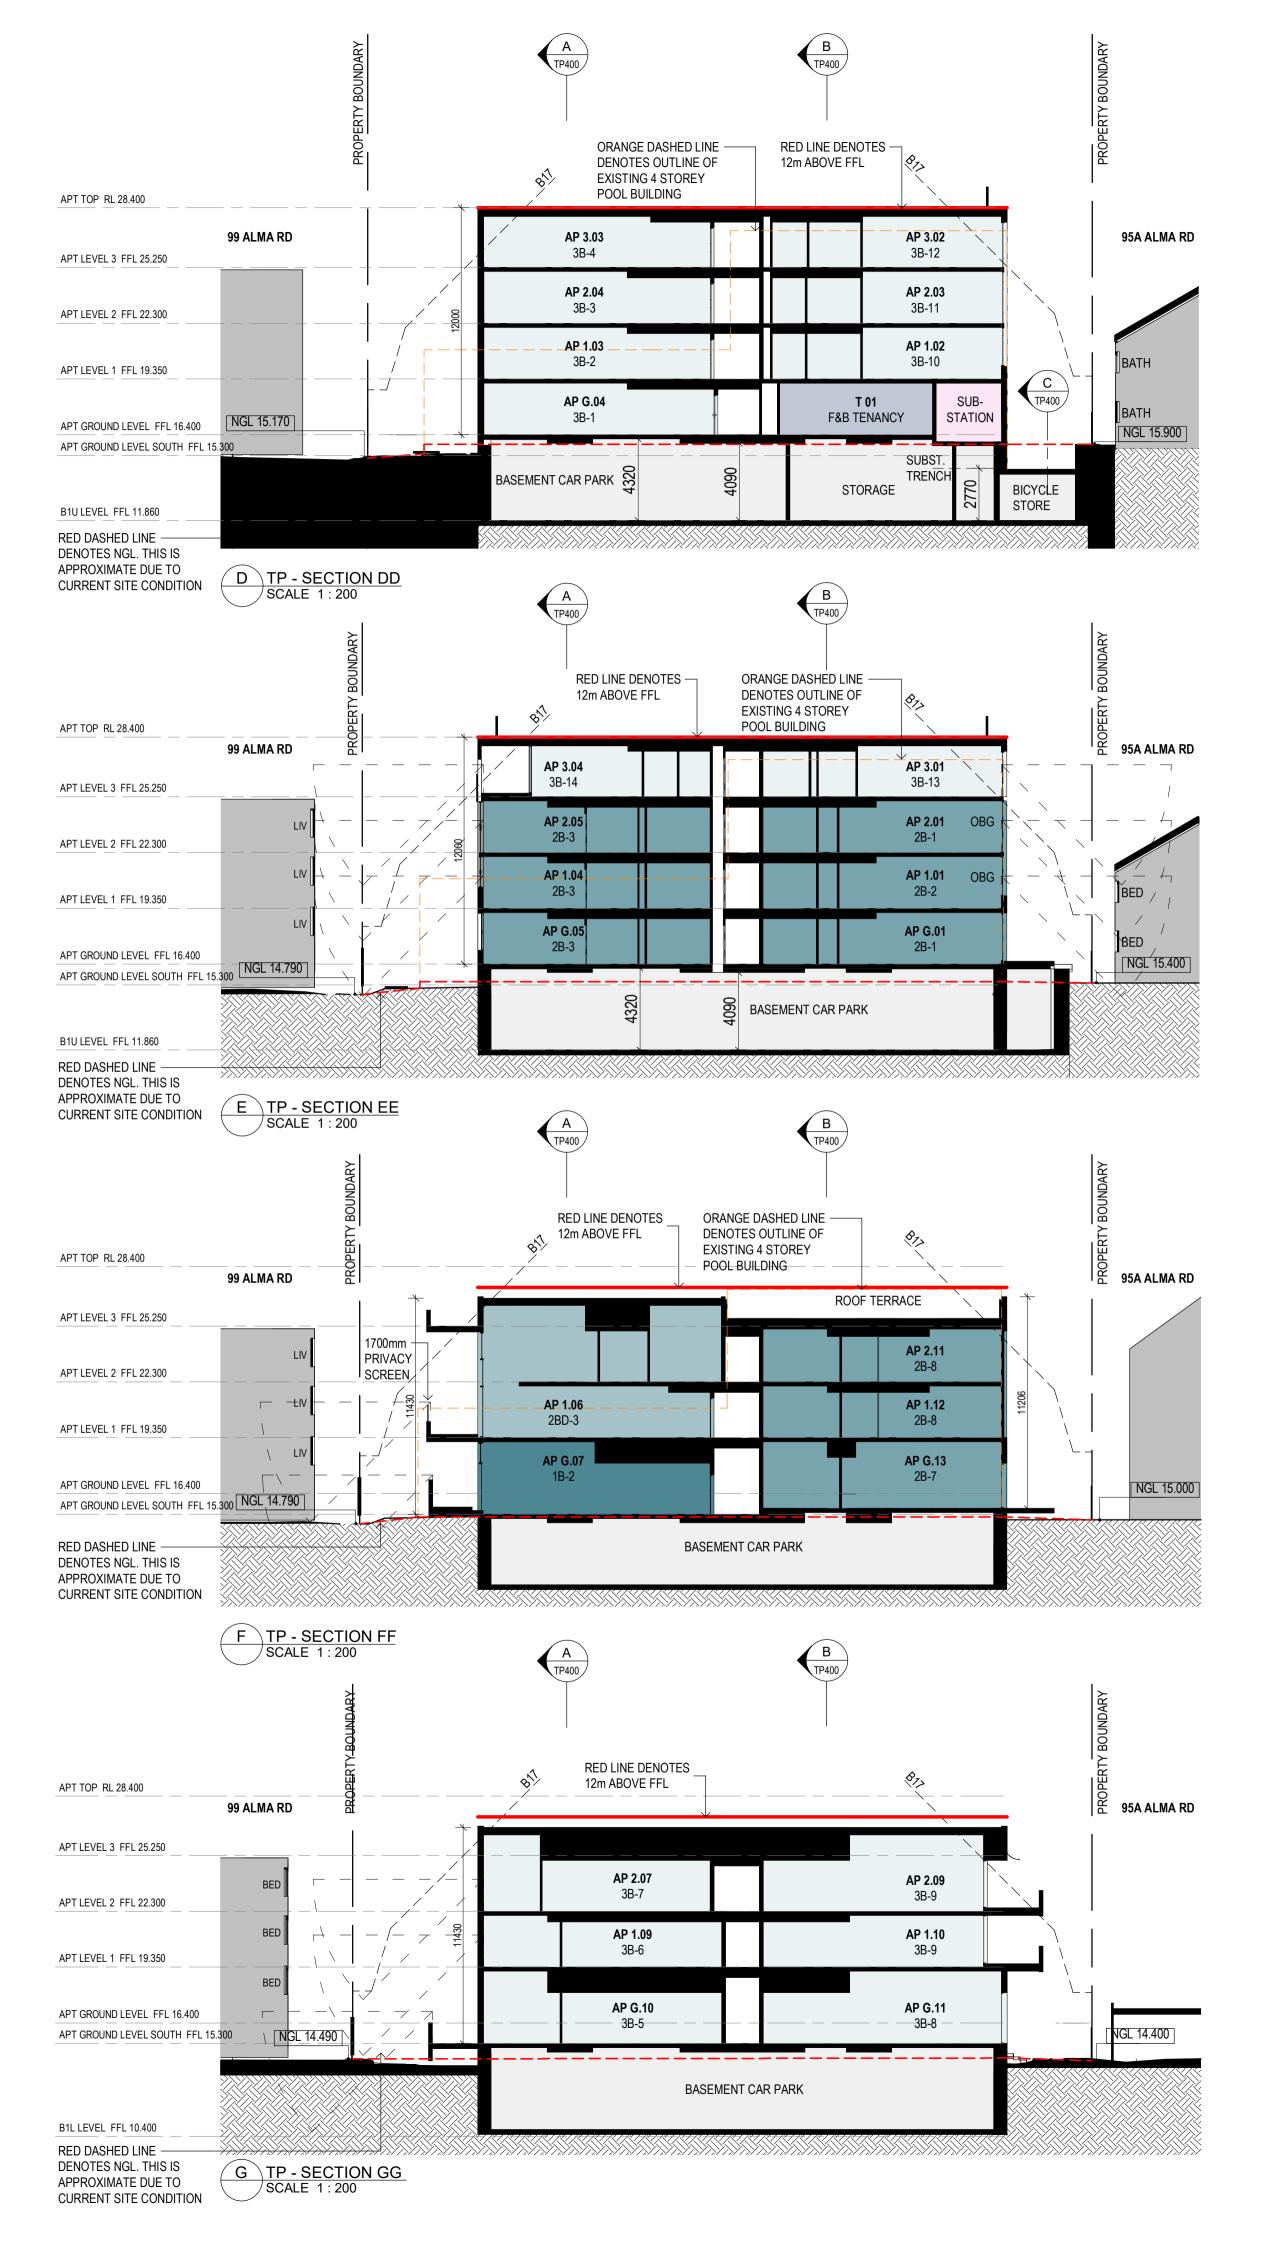
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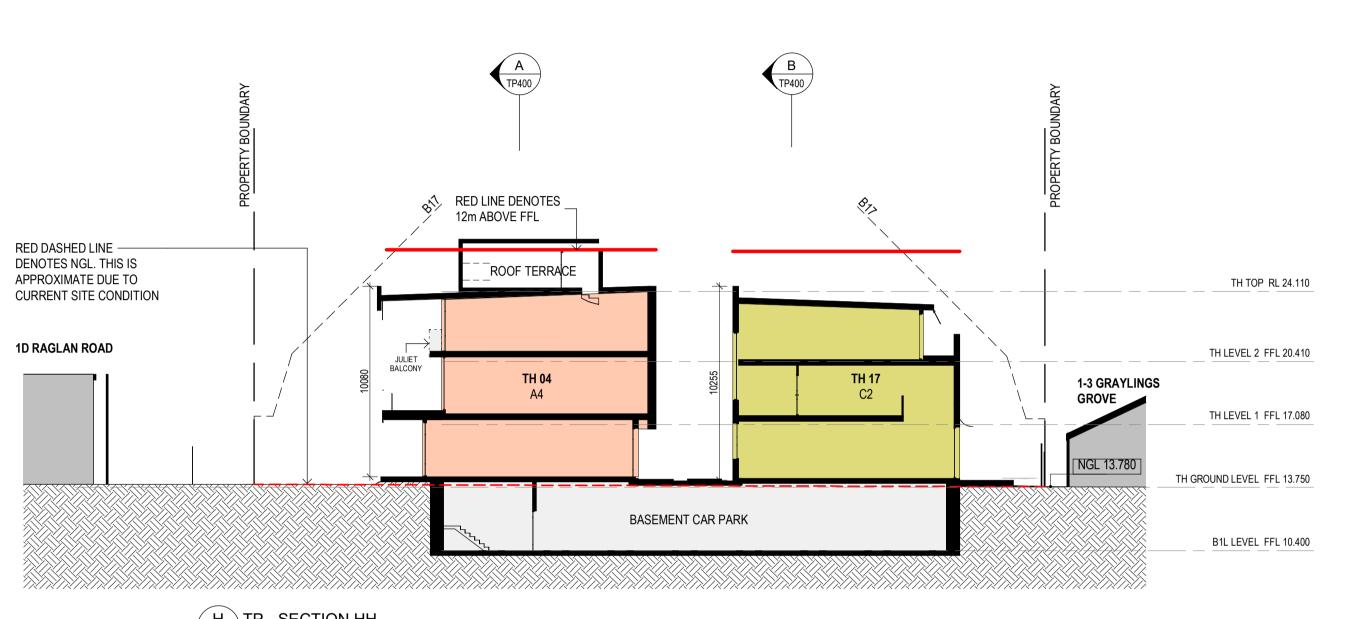
GA SECTIONS - SHEET 1


AT St Kilda East FOR Neometro

27.07.2023 JL/TM/LG PROJECT As indicated(A1) 2202



City of Port Phillip Advertised Plan Planning Application No. PDPL/00823/2022 No. of Pages: 20 of 50



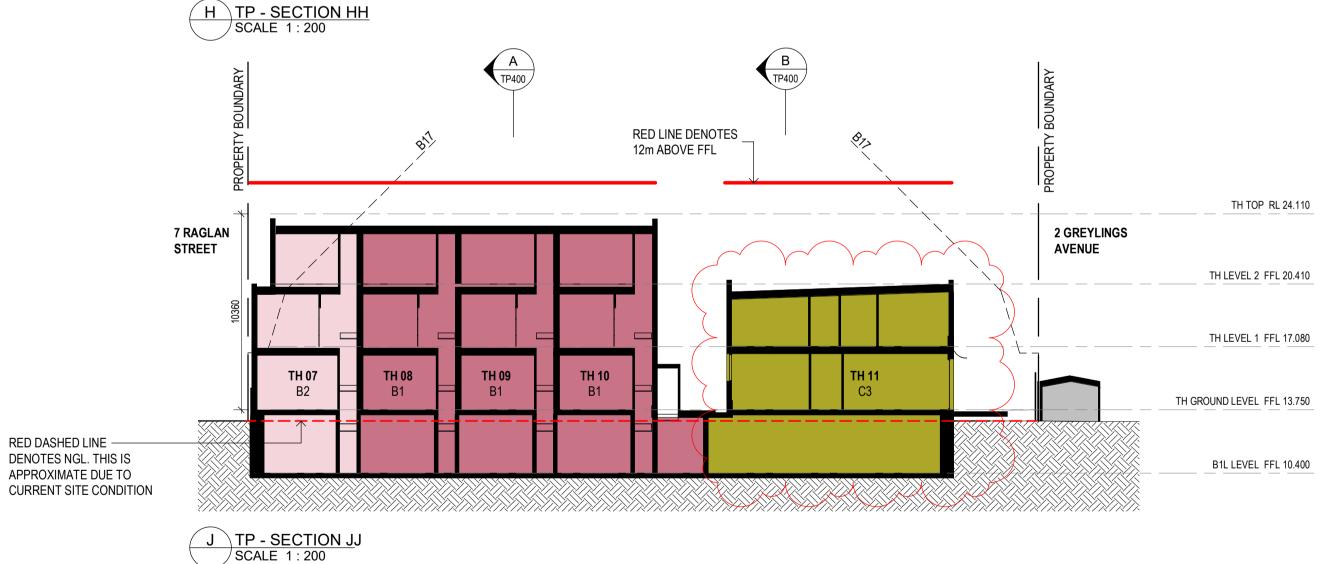

GENERAL NOTES SURVEY: EXISTING SITE INFORMATION IS TAKEN FROM VERIS SURVEY NUMBER 303981-BG DATED 06/07/2023 AND IS PROVIDED HERE FOR ILLUSTRATIVE PURPOSES ONLY. FOR FULL SURVEY DETAILS REFER TO SURVEY DOCUMENTS PROVIDED WITHIN APPENDICIES.

LANDSCAPE DESIGN: LANDSCAPE DESIGN IS SHOWN INDICATIVELY. FOR FULL LANDSCAPE DETAILS REFER TO LANDSCAPE ARCHITECT'S DOCUMENTATION.



EXISTING TREE WITHIN PROJECT BOUNDARY TO BE RETAINED. TREE NUMBER, TPZ AND CANOPY AS PER ARBORIST REPORT

ABBREVIATIONS: AC CONDENSER UNIT CL CLOTHES LINE ELEC ELECTRICAL SERVICES HYDR HYDRAULIC SERVICES COM COMMS SERVICES FCL FINISHED CEILING LEVEL FINISHED FLOOR LEVEL

FHR FIRE HOSE REEL FHY FIRE HYDRANT FIRE INDICATOR PANEL FLOOR WASTE NATURAL GROUND LEVEL RELATIVE LEVEL WATER TAP

HOT WATER UNIT

OW OPERABLE WINDOW

__ MATERIALS

BR1 BRICK WORK - BAGGED TEXTURE FINISH BR2 BREEZE BLOCK PAINTED FIBRE CEMENT SHEET

HEAT PUMP HOT WATER UNIT

EXTERNAL TILE SC1 SUN SHADESCREEN MT1 VERTICAL ALUMINIUM BALUSTRADE GLAVANISED STEEL CLADDING

MT3 METAL PERGOLA GL1 GLAZING - DOUBLE CLEAR OBSCURE GLAZING - REEDED GL2 MS1 CABLE MESH

MESH FENCING MS3 MESH SCREEN ACOUSTIC WALL PANEL AS1 **SR1** SAFETY GUARD RAIL

__GENERAL NOTES

APARTMENT CEILING HEIGHT = MIN. 2700mm; EXCLUDING BULKHEAD AREAS OVER JOINERY, BATHROOMS AND HALLWAYS WHERE CEILING HEIGHT = MIN. 2400mm

1. THE PROJECT ACHIEVES A TOTAL BESS SCORE OF 73% WITH NO MANDATORY

CATEGORY (IEQ, ENERGY, WATER, STORMWATER) BELOW 50%.
2. 100% (41 OUT OF 41) OF THE DEVELOPMENT'S APARTMENTS AND 100% (21 OUT OF 21) OF THE DEVELOPMENT'S TOWNHOUSES ARE NATURALLY CROSS-VENTILATED. DAYLIGHT MODELLING HAS BEEN CONDUCTED FOR A REPRESENTATIVE SAMPLE OF APARTMENTS. THE SUMMARY RESULT IS AS FOLLOWS:
 88% OF LIVING FLOOR AREA ACHIEVES >90% ABOVE DF 1 92% OF BEDROOM FLOOR AREA ACHIEVES >90% ABOVE DF0.5
 THE NON-RESIDENTIAL AREAS ARE TARGETING A 2% DF TO 40% OF THE NOMINATED AREA.
5. 39% (16 OUT OF 41) OF APARTMENTS ACHIEVE AT LEAST 3 HOURS OF SUNLIGHT. 5. 39% (16 OUT OF 41) OF APARTMENTS ACHIEVE AT LEAST 3 HOURS OF SUNLIGHT.
6. THE DEVELOPMENT IS PROVIDED WITH A COMPREHENSIVE SHADING STRAFEY.
7. THE DEVELOPMENT IS TO ACHIEVE A 7.5 STAR AVERAGE NATHERS ENERGY RATING RESULT FOR THE APARTMENTS AND A 7.0 STAR AVERAGE NATHERS ENERGY RATING RESULT FOR THE TOWNHOUSES.
8. THE NON-RESIDENTIAL AREAS AIM TO REDUCE HEATING AND COOLING ENERGY CONSUMPTION BELOW THE REFERENCE CASE (BCA SECTION J 2019).
9. THE DEVELOPMENT IS TO UTILISE ELECTRIC HEAT PUMP HOT WATER SYSTEM.
10. A 9.6KW SOLAR PV SYSTEM IS TO BE LOCATED ON THE ROOF OF THE APARTMENT BUILDING.
11. A 2KW SOLAR PV SYSTEM IS TO BE PROVIDED FOR EACH TOWNHOUSE.
12. INDIVIDUAL COLD WATER AND ELECTRICITY METERS WILL BE REPOVIDED TO THE 12. INDIVIDUAL COLD WATER AND ELECTRICITY METERS WILL BE PROVIDED TO THE APARTMENTS, TOWNHOUSES AND COMMUNAL AREAS. AND COMMONDAL AREAS.

13. WATER EFFICIENT FITTINGS AND FIXTURES ARE APPLIED THROUGHOUT.

14. A 32,000-LITRE RAINWATER TANK AND A 30,000-LITRE RAINWATER TANK WILL HARVEST RAINWATER FROM THE APARTMENT ROOF AND TOWNHOUSE ROOFS RESPECTIVELY. THESE TANKS WILL BE CONNECTED TO ALL TOILETS.

15. A MELBOURNE STORM RATING OF 102% IS ACHIEVED. 15. A MELBOURNE STORM RATING OF 102% IS ACHIEVED.

16. ALL LANDSCAPING IS TO BE NATIVE SPECIES OR LANDSCAPING IRRIGATION IS TO BE CONNECTED TO THE RAINWATER TANK ONLY.

17. IN TOTAL 62 BICYCLE SPACES ARE TO BE PROVIDED FOR RESIDENTS.

18. IN TOTAL 2 BICYCLE SPACES ARE TO BE PROVIDED FOR STAFF.

19. IN TOTAL 16 BICYCLE SPACES ARE TO BE PROVIDED FOR RESIDENTIAL AND NON-RESIDENTIAL VISITORS.

NON-RESIDENTIAL VISITORS.
20. ONE CHARGING POINT FOR ELECTRICAL VEHICLES IS INTEGRATED IN THE PROPOSED DEVELOPMENT.
21. 141M2 OF COMMUNAL SPACE WILL BE PROVIDED AT THE ROOFTOP DECK.
22. 24M2 OF COMMUNAL FOOD PRODUCTION AREA WILL BE PROVIDED. REFER TO ESD CONSULANTS DOCUMENTATION FOR FULL DETAILS No. Date Description

18.11.2022 Issued for Town Planning 15.03.2023 Issued for RFI Response 27.07.2023 Amended TP Submission

> **TOWN PLANNING** NOT FOR CONSTRUCTION

__KTA

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www.kerstinthompson.com


DRAWING TITLE GA SECTIONS - SHEET 2

PROJECT 97 Alma Road AT St Kilda East

FOR Neometro 27.07.2023 JL/TM/LG

As indicated(A1) 2202

City of Port Phillip Advertised Plan Planning Application No. PDPL/00823/2022 No. of Pages: 21 of 50

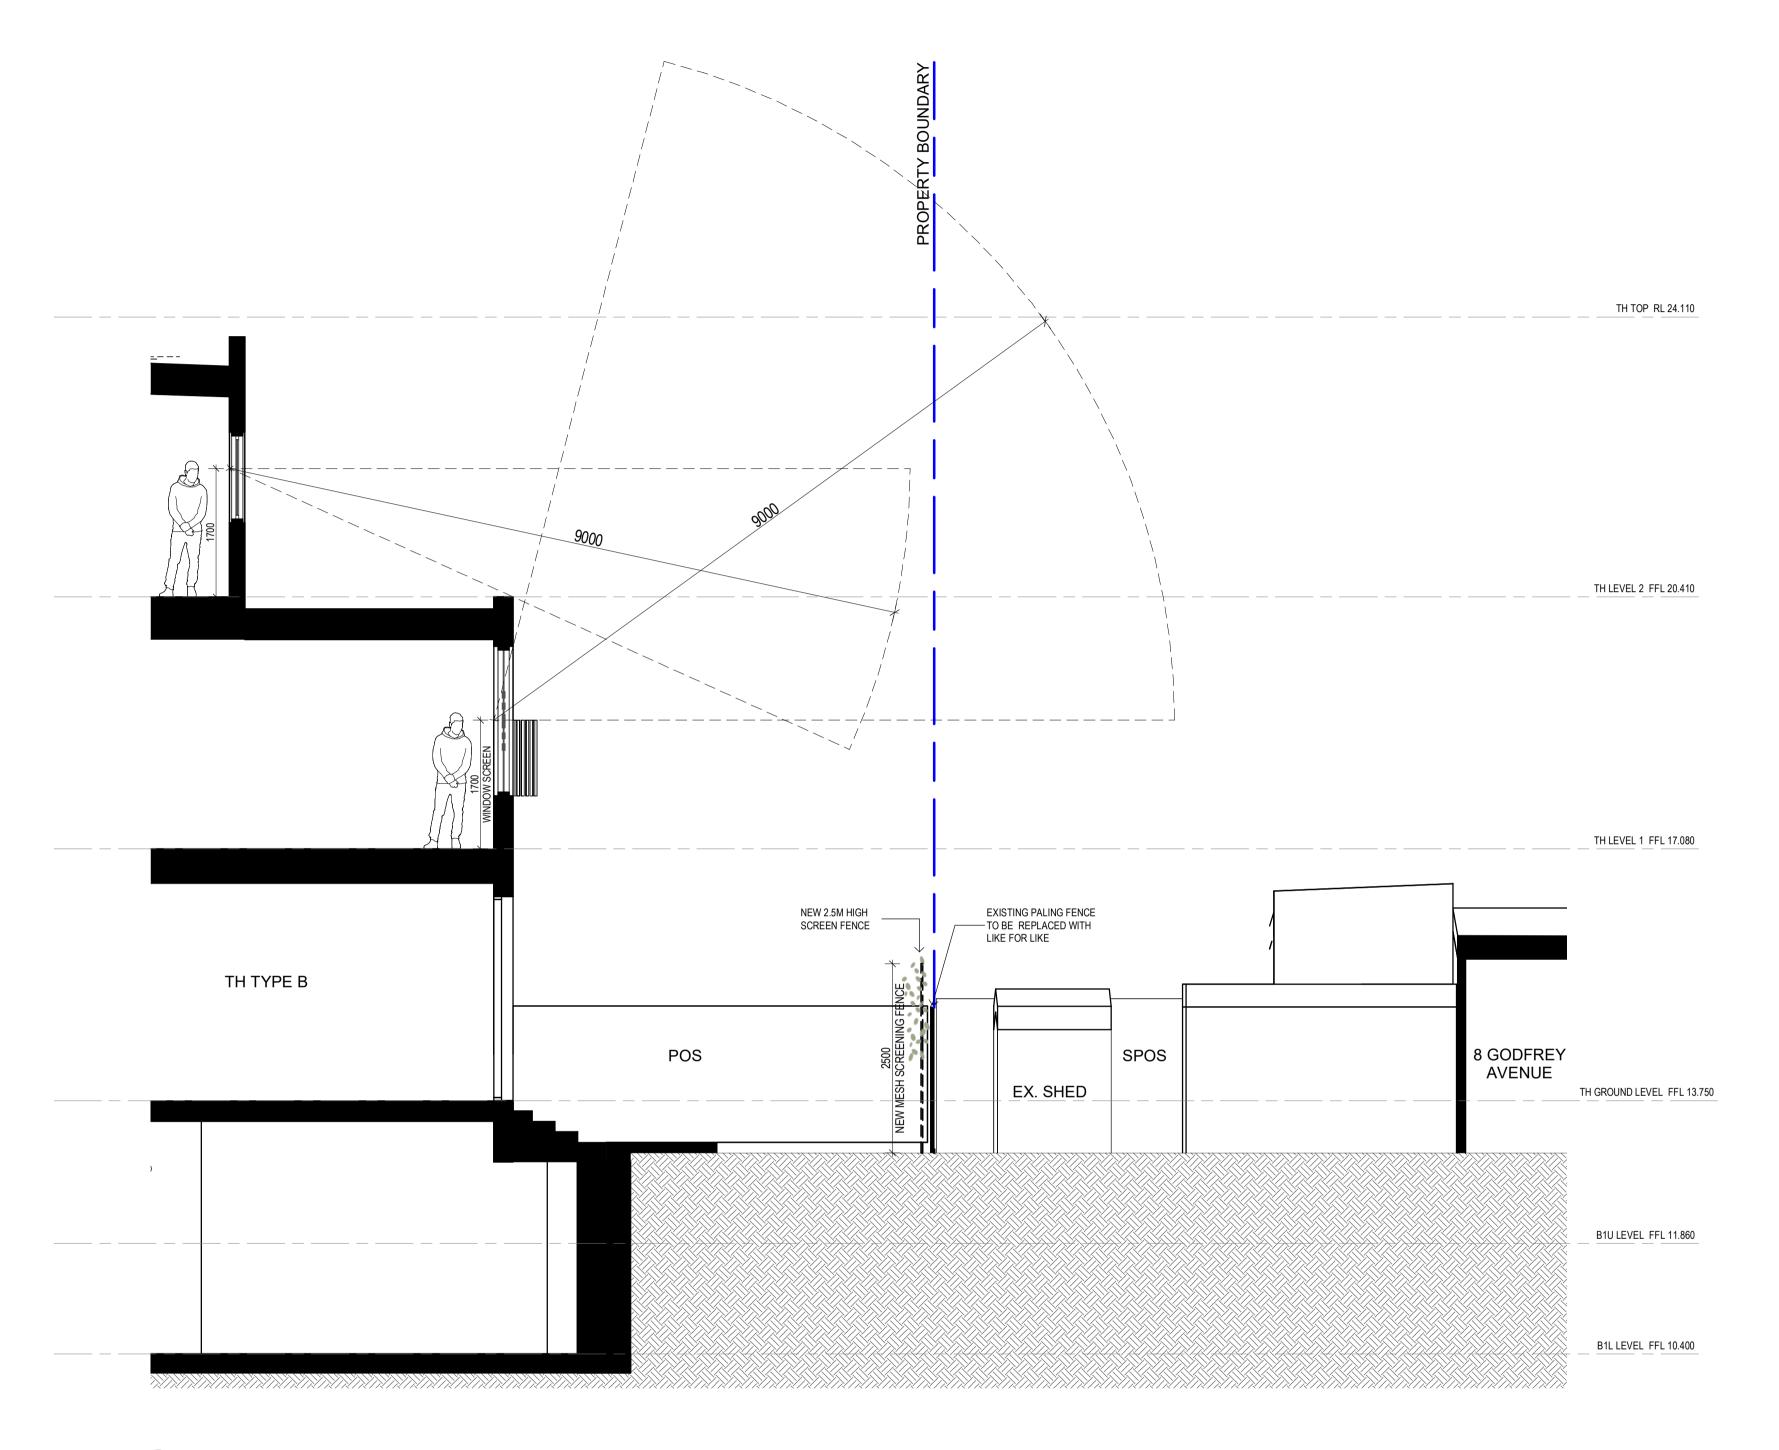


DETAIL SECTION - SCREENING SCALE 1:50

__GENERAL NOTES

DOCUMENTATION.

SURVEY: EXISTING SITE INFORMATION IS TAKEN FROM VERIS SURVEY NUMBER 303981-BG DATED 06/07/2023 AND IS PROVIDED HERE FOR ILLUSTRATIVE PURPOSES ONLY. FOR FULL SURVEY DETAILS REFER TO SURVEY DOCUMENTS PROVIDED WITHIN APPENDICIES.

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EXISTING TREE WITHIN PROJECT BOUNDARY TO BE RETAINED.
TREE NUMBER, TPZ AND CANOPY AS PER ARBORIST REPORT

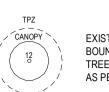ABBREVIATIONS:
AC CONDENSER UNIT
CL CLOTHES LINE
ELEC ELECTRICAL SERVICES

ELEC ELECTRICAL SERVICES
HYDR HYDRAULIC SERVICES
COM COMMS SERVICES
FCL FINISHED CEILING LEVEL
FFL FINISHED FLOOR LEVEL
FHR FIRE HOSE REEL
FHY FIRE HYDRANT
FIP FIRE INDICATOR PANEL
FW FLOOR WASTE
NGL NATURAL GROUND LEVEL

RL RELATIVE LEVEL
TP WATER TAP
HW HOT WATER UNIT HP HEAT PUMP HOT WATER UNIT
OW OPERABLE WINDOW

__ MATERIALS


BR1 BRICK WORK - BAGGED TEXTURE FINISH
BR2 BREEZE BLOCK
FC1 PAINTED FIBRE CEMENT SHEET TL1 EXTERNAL TILE

SC1 SUN SHADESCREEN
MT1 VERTICAL ALUMINIUM BALUSTRADE
MT2 GLAVANISED STEEL CLADDING MT3 METAL PERGOLA

MT3 METAL PERGOLA
GL1 GLAZING - DOUBLE CLEAR
GL2 OBSCURE GLAZING - REEDED
MS1 CABLE MESH
MS2 MESH FENCING
MS3 MESH SCREEN
AS1 ACOUSTIC WALL PANEL
SR1 SAFETY GUARD RAIL

No. Date Description
0 27.07.2023 Amended TP Submission

TOWN PLANNING NOT FOR CONSTRUCTION

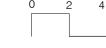

__KTA

Kerstin Thompson Architects Pty Ltd 277 Queensberry St, Melbourne Australia 3000 **T +61 3 8662 8800** kta@kerstinthompson.com www.kerstinthompson.com

DRAWING TITLE
DETAIL SECTION - SCREENING

PROJECT 97 Alma Road

AT St Kilda East Neometro



OVERALL COMPLIANCE DEVELOPMENT SUMMARY							
	No OF APARTMENTS						
APARTMENT BUILDING	41						

	CLAUSE 55.07 - APARTMENT DEVELOPMENTS COMPLIANCE MATRIX													
STANDARD B46 UNCTIONAL LAYOUT	STANDARD B47 ROOM DEPTH	STANDARD B44 STORAGE	STANDARD B49 NATURAL VENTILATION	STANDARD B43 PRIVATE OPEN SPACE	STANDARD B42 ACCESSIBILITY COMPLIANCE	STANDARD B38 DEE SOIL (WHOLE SITE								
41	41	41	41	41	26	763m2								

% COMPLIANT WITH CLAUSE 55.07 - APARTMENT DEVELOPMENT MIN. % COMPLAINCE REQUIREMENT

City of Port Phillip
Advertised Plan
Planning Application No. PDPL/00823/2022
No. of Pages: 22 of 50


C	OMLIANCE SI	JMMARY BY DWELLING			CLAUSE 55.07 - APARTMENT DEVELOPMENTS COMPLIANCE MATRIX DWELLING AMENITY																											
		WELLING		FUNCTIONAL LAYOUT ROOM DEPTH WINDOW STORAGE NATURAL VENTILA							ATION		PRIVAT	E OPEN	SPACE		Q	ACCESSIBILITY COMPLIANCE														
		l		1B	2B+	1B	2B+		SQ			1B		77	2B	Ĭ	=	3B	Ĭ			ANY	ANY	1B	2B	3B			I			
APARTMENT TYPE (BED No.)	SUBTYPE	APARTMENT No. ON PLAN	TOTAL No. OF APARTMENTS OF THIS TYPE	MAIN BEDROOM 3x3.4m	SECOND / THIRD BEDROOM 3x3m	LIVING AREA MIN. 3.3m WIDE / MIN. 10m2	LIVING AREA MIN. 3.6m WIDE / MIN. 12m2	APARTMENT DEPTH	CEILING HEIGHT, BEDROOMS & OPEN PLAN KITCHEN-LIVING-DIINING EXCL. BULKHEADS	COMLIANT SNORKEL, 1.5:1 RATIO	STORAGE WITHIN DWELLING 6m3 MIN.	EXTERNAL STORAGE VOLUME	TOTAL STORAGE VOLUME 10m3 MIN.	STORAGE WITHIN DWELLING 9m3 MIN.	EXTERNAL STORAGE VOLUME	TOTAL STORAGE VOLUME 14m3 MIN.	STORAGE WITHIN DWELLING 12m3 MIN.	EXTERNAL STORAGE VOLUME	TOTAL STORAGE VOLUME 18m3 MIN.	BREEZE PATH PARTMENT No. ON PLAN	BREEZE PATH TOTAL No. OF APARTMENTS	BALCONY NORTH 1.7m MINIMUM DIMENSION / 8m2	BALCONY SOUTH 1.2m MINIMUM DIMENSION / 8m2	BALCONY OTHER ORIENTATION 1.8m MINIMUM DIMENSION / 8m2	BALCONY OTHER ORIENTATION 2m MINIMUM DIMENSION / 8m2	BALCONY OTHER ORIENTATION 2.4m MINIMUM DIMENSION / 12m2	FRONT DOOR OPENING	DOOR DESIGN	CLEAR PATH TO MAIN BEDROOM, ADAPTABLE BATHROOM AND LIVING	MAIN BEDROOM ACCESS TO ADAPATBLE BATHROOM	ADAPTABLE BATHROOM	ADG ACCESSIBLE APARTMENTS TOTAL No. OF APARTMENTS
	1B-1	G.03	1	~	00	~		*	2.7m	NA	×.	1	~				y a			G.03	1			×		8 8	s		25	8 8		0
1 BED	1B-2	G.06 & G.07	2	~	3	~		1	2.7m	NA	~	1	1			6	D			G.06 & G.07	2			1					FR			0
	1B-3	G.09	1	~		~		~	2.7m	NA	~	€.	~			8			8	G.09	1			1			,					0
1 4 4 5 5 5	1B-4	2.02 & 2.10	2	~		~		~	2.7m	NA	~	*	~							2.02 & 2.10	2			~								0
TOTAL 1B			6																		6										,	0
	2B-1	G.01	1	~	1		1	1	2.7m	NA	\$		i i	1	1	1	D		8	G.01	1				1	0 0			\$C			0
	2B-2	1.01 & 2.01	2	~	1		~	4	2.7m	NA				~	~	~			8	1.01 & 2.01	2				V .				23			0
	2B-3	G.05, 1.04 & 2.05	3	~	~		1	`	2.7m	NA			<i>17</i>	*	1	1				G.05, 1.04 & 2.05	3				1		*	~	~	*	~	3
2 BED	2B-4	G.08, 1.07, 2.06	3	~	~		1	*	2.7m	NA				~	~	~				G.08, 1.07, 2.06	3				~		~	*	~	*	~	3
2 323	2B-5	G.12	1	~	~		1	~	2.7m	NA				1	1	1			s	G.12	1				1		1	~	1	4	1	1
	2B-6	1.11 & 2.09	2	~	/		~	~	2.7m	NA				1	1	1				1.11 & 2.09	2				1		1	~	~	1	~	2
	2B-7	G.14	1	~	1		1	<	2.7m	NA	5 3		es.	1	1	1	y - 0			G.14	1		5 8		1	s 8	5 %		165			0
	2B-8	1.12 & 2.11	2	~	1		~	1	2.7m	NA				~	~	1				1.12 & 2.11	2				~		1	1	~	V	1	2
TOTAL 2B			15																		15											11
	2BD-1	G.02	1	~	7	Ì	~	1	2.7m	NA				1	7	1				G.02	1				~							0
2 BED	2BD-2	G.13	1	~	V.		~	~	2.7m	NA				1	1	~				G.13	1				~							0
DUPLEX	2BD-3	1.05 & 1.06	2	~	1		1	1	2.7m	NA				1	1	1				1.05 & 1.06	2	c			1							0
3	2BD-4	1.08	1	~	~		~	~	2.7m	NA			č.	~	~	~	0		6	1.08	1				1	0 0			, či			0
TOTAL 2B D	OUPLEX		5	ai.			80 -31		30	*		,		*		ie.			***	30	5						20 0	,	is.			0
40 40	3B-1	G.04	1	_	1		1	4	2.7m	NA							1	1	1	G.04	1	1					·	1	_	·	~	1
33	3B-2	1.03	1	~	-		1	1	2.7m	NA	8		R.			6	·	1	1	1.03	1	1	0 0			0 9	·	1	1	·	V:	1
	3B-3	2.04	1	~	_		~	4	2.7m	NA			2			8	·	1	4	2.04	1	4					V	-	1	V	V-	1
59	3B-4	3.03	1	~	~		1	·	2.7m	NA	*	,	ý.	8		Ř.	~	-	~	3.03	1	·				i 10	~	·	~	_	~	1
	3B-5	G.10	1	~	~		1	~	2.7m	NA							~	-	1	G.10	1	7		,		*	4	-	1	~	~	1
	3B-6	1.09	1	-	~		~	~	2.7m	NA	0 1					9	1	~	~	1.09	1					1	1	~	~	1	~	1
3 BED	3B-7	2.07	1	~	~		~	1	2.7m	NA	3						1	1	1	2.07	1					1	1	1	~	1	~	1
JUED	3B-8	G.11	1	1	~		~	1	2.7m	NA			, c				1	1	1	G.11	1					4	1	1	1	1	1	1
	3B-9	1.10 & 2.08	2	~	~		1	1	2.7m	NA							1	1	1	1.10 & 2.08	2					4	1	1	~	~	~	2
	3B-10	1.02	1	~	~		1	1	2.7m	NA			i i	\$		6	1	1	1	1.02	1	¥	0			A 5	V	1	~	~	✓:	1
	3B-11	2.03	1	~	~		~	4	2.7m	NA							1	4	1	2.03	1	4					/	4	1	✓	V	1
	3B-12	3.02	1	~	*		1	~	2.7m	NA			(c)	*			1	1	4	3.02	1	· /					~	1	~	~	1	1
	3B-13	3.01	1	~	~		1	*	2.7m	NA							~	~	4	3.01	1					4	~	1	4	4	~	1
	3B-14	3.04	1	~	1		1	1	2.7m	NA							1	~	1	3.04	1					1	1	1	~	1	1	1
TOTAL 3B			15																		15											15
TOTAL APA	RTMENTS		41																		41											26

 No.
 Date
 Description

 0
 18.11.2022
 Issued for Town Planning

 1
 27.07.2023
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DRAWING TITLE
APARTMENT DESIGN GUIDELINES COMPLIANCE

APARTMENT DESIGN GUIDELINES CON SCHEDULES

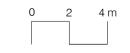PROJECT
97 Alma Road

AT St Kilda East
FOR Neometro

DATE DRAWN BY
27.07.2023 JL/TM/LG

SCALE PROJECT
(A1) 2202 TP60

APT T	TYPE 1B-1							
LEVEL	APT TYPE	NUMBER						
APT GROUND LEVEL	1B-1	G.03						
TOTAL: 1								

INTERNAL STORAGE APT 1B-1											
TYPE LOCATION VOLU											
1B-1	BEDROOM	3.6 m³									
1B-1	KITCHEN	0.9 m³									
1B-1	KITCHEN	0.4 m³									
1B-1	KITCHEN	0.3 m³									
1B-1	KITCHEN	0.2 m³									
1B-1	KITCHEN	1.0 m³									
1B-1	KITCHEN	0.1 m³									

LAUNDRY

TOTAL INTERNAL STORAGE

0.8 m³

EXTERNAL STORAGE APT 1B-1												
APT TYPE	LOCATION	VOLUME										
1B-1 TOTAL EXTERNAL	1B-1 G.03 BSMT STORAGE 6.1 m³ TOTAL EXTERNAL: 1											

<u></u>	
	PLANTER
	OW
3400	
L J J J J J J J J J J J J J J J J J J J	
	P
AP G.03 1B-1 56.3 m ²	3300 F 000 000
	D 233
PLANTER	
T L/WYLLIX	
FW	20
	3450
POS 19.2 m²	2
PLANTE	ER .
4275	; *

APT TYPE 1B-2			
LEVEL	APT TYPE	NUMBER	
APT GROUND LEVEL	1B-2	G.06	
APT GROUND LEVEL	1B-2	G.07	
TOTAL: 2			

INTERNAL STORAGE APT 1B-2			
TYPE	LOCATION	VOLUME	
1B-2	BEDROOM	3.6 m³	
1B-2	BEDROOM	0.4 m³	
1B-2	KITCHEN	0.9 m³	
1B-2	KITCHEN	0.4 m³	
1B-2	KITCHEN	0.3 m³	
1B-2	KITCHEN	0.1 m³	
1B-2	KITCHEN	0.2 m³	
1B-2	KITCHEN	1.0 m³	
1B-2	LAUNDRY	0.8 m³	
TOTAL INTERNAL STORAGE 7.7 m ³			

EXTERNAL STORAGE APT 1B-2			
APT TYPE	APT TYPE LOCATION VOLUME		
1B-2	G.06 BSMNT STORAGE	6.1 m³	
1B-2	G.07 BSMNT STORAGE	6.1 m³	
TOTAL EXTERNAL: 2			

¥ 4325	/
FW POS 10.3 m²	2085
3050 AP G.06 1B-2 55.2 m² F PLANTER	0009
PLAINIER	

APT TYPE	L STORAGE APT 1B-3 LOCATION VOLUM	IE
1B-3 COTAL EXTERNAL: 1	6.1 m ²	3
 	4325	
	POS 10.4 m²	=W
D D		
	3300	
	3050	
S		
		\\
○ ○ C	AP G.09	
	AP G.09 1B-3 59.6 m ²	
F		
P		
	3000	
	3400	

APT TYPE 1B-3

INTERNAL STORAGE APT 1B-3

LOCATION

BEDROOM

KITCHEN

KITCHEN KITCHEN

KITCHEN

KITCHEN

KITCHEN

LAUNDRY

APT GROUND LEVEL

APT TYPE NUMBER

VOLUME

0.4 m³

0.3 m³

0.1 m³

0.2 m³

0.8 m³

1B-3 G.09


APT TYPE 1B-4

LEVEL	APT TYPE	NUMBER
APT LEVEL 2	1B-4	2.02
APT LEVEL 2	1B-4	2.10
TOTAL: 2		

INTERNAL STORAGE APT 1B-4		
TYPE	LOCATION	VOLUME
1B-4	BEDROOM	3.6 m³
1B-4	BEDROOM	1.8 m³
1B-4	KITCHEN	0.9 m³
1B-4	KITCHEN	0.4 m³
1B-4	KITCHEN	0.3 m³
1B-4	KITCHEN	0.1 m ³
1B-4	KITCHEN	0.2 m ³
1B-4	KITCHEN	1.0 m³
1B-4	LAUNDRY	0.8 m³
TOTAL INTERNAL	STORAGE	9.0 m³

EXTERNAL STORAGE APT 1B-4			
APT TYPE LOCATION VOLUME			
1B-4	2.02 BSMNT STORAGE	6.1 m³	
1B-4	2.10 BSMNT STORAGE	6.1 m³	
TOTAL EXTERNAL: 2			

City of Port Phillip Advertised Plan Planning Application No. PDPL/00823/2022 No. of Pages: 23 of 50

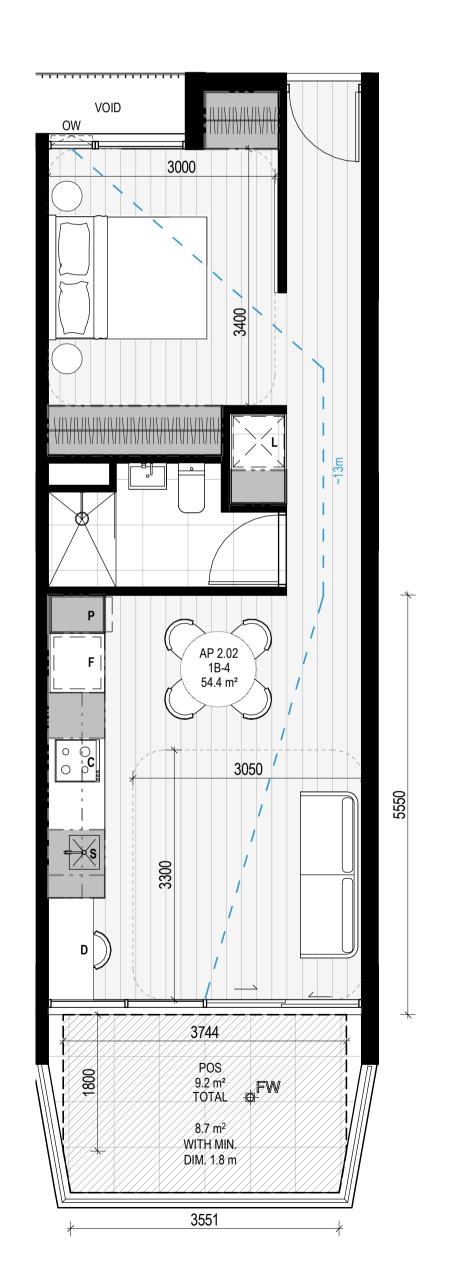

__APARTMENT NOTES

BATHROOM DESIGN OPTION UNDER APARTMENT DESIGN GUIDELINES FOR VICTORIA TABLE D4

L - LAUNDRY P - PANTRY

F - FRIDGE

S - SINK C - COOKTOP

D - DESK



GENERAL NOTES

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FIP FIRE INDICATOR PANEL FW FLOOR WASTE NGL NATURAL GROUND LEVEL RELATIVE LEVEL WATER TAP HW HOT WATER UNIT

__ MATERIALS

BR1 BRICK WORK - BAGGED TEXTURE FINISH
BR2 BREEZE BLOCK

FC1 PAINTED FIBRE CEMENT SHEET TL1 EXTERNAL TILE SC1 SUN SHADESCREEN

HP HEAT PUMP HOT WATER UNIT OW OPERABLE WINDOW

MT1 VERTICAL ALUMINIUM BALUSTRADE MT2 GLAVANISED STEEL CLADDING MT3 METAL PERGOLA GL1 GLAZING - DOUBLE CLEAR
GL2 OBSCURE GLAZING - REEDED

MS1 CABLE MESH MS2 MESH FENCING MS3 MESH SCREEN AS1 ACOUSTIC WALL PANEL

SR1 SAFETY GUARD RAIL

ESD:

1. THE PROJECT ACHIEVES A TOTAL BESS SCORE OF 73% WITH NO MANDATORY CATEGORY (IEQ, ENERGY, WATER, STORMWATER) BELOW 50%.

2. 100% (41 OUT OF 41) OF THE DEVELOPMENT'S APARTMENTS AND 100% (21 OUT OF 21) OF THE DEVELOPMENT'S TOWNHOUSES ARE NATURALLY CROSS-VENTILATED.

3. DAYLIGHT MODELLING HAS BEEN CONDUCTED FOR A REPRESENTATIVE SAMPLE OF APARTMENTS. THE SUMMARY RESULT IS AS FOLLOWS:

• 88% OF LIVING FLOOR AREA ACHIEVES >90% ABOVE DF 1

• 92% OF BEDROOM FLOOR AREA ACHIEVES >90% ABOVE DF 0.5

4. THE NON-RESIDENTIAL AREAS ARE TARGETING A 2% DF TO 40% OF THE NOMINATED AREA.

5. 39% (16 OUT OF 41) OF APARTMENTS ACHIEVE AT LEAST 3 HOURS OF SUNLIGHT.

6. THE DEVELOPMENT IS PROVIDED WITH A COMPREHENSIVE SHADING STRATEGY. 6. THE DEVELOPMENT IS PROVIDED WITH A COMPREHENSIVE SHADING STRATEGY.
7. THE DEVELOPMENT IS TO ACHIEVE A 7.5 STAR AVERAGE NATHERS ENERGY RATING RESULT FOR THE APARTMENTS AND A 7.0 STAR AVERAGE NATHERS

ENERGY RATING RESULT FOR THE TOWNHOUSES.

8. THE NON-RESIDENTIAL AREAS AIM TO REDUCE HEATING AND COOLING ENERGY CONSUMPTION BELOW THE REFERENCE CASE (BCA SECTION J 2019).

CONSUMPTION BELOW THE REFERENCE CASE (BCA SECTION J 2019).

9. THE DEVELOPMENT IS TO UTILISE ELECTRIC HEAT PUMP HOT WATER SYSTEM.

10. A 9.6KW SOLAR PV SYSTEM IS TO BE LOCATED ON THE ROOF OF THE APARTMENT BUILDING.

11. A 2KW SOLAR PV SYSTEM IS TO BE PROVIDED FOR EACH TOWNHOUSE.

12. INDIVIDUAL COLD WATER AND ELECTRICITY METERS WILL BE PROVIDED TO THE APARTMENTS, TOWNHOUSES

AND COMMUNAL AREAS.

13. WATER EFFICIENT FITTINGS AND FIXTURES ARE APPLIED THROUGHOUT.

14. A 32,000-LITRE RAINWATER TANK AND A 30,000-LITRE RAINWATER TANK WILL HARVEST RAINWATER FROM THE

APARTMENT ROOF AND TOWNHOUSE ROOFS RESPECTIVELY. THESE TANKS WILL BE CONNECTED TO ALL TOILETS.

15. A MELBOURNE STORM RATING OF 102% IS ACHIEVED.

16. ALL LANDSCAPING IS TO BE NATIVE SPECIES OR LANDSCAPING IRRIGATION IS TO BE CONNECTED TO THE RAINWATER TANK ONLY.

17. IN TOTAL 62 BICYCLE SPACES ARE TO BE PROVIDED FOR RESIDENTS.

18. IN TOTAL 2 BICYCLE SPACES ARE TO BE PROVIDED FOR RESIDENTIAL AND NON-RESIDENTIAL VISITORS.

20. ONE CHARGING POINT FOR ELECTRICAL VEHICLES IS INTEGRATED IN THE PROPOSED DEVELOPMENT.


21. 141M2 OF COMMUNAL SPACE WILL BE PROVIDED AT THE ROOFTOP DECK.

22. 24M2 OF COMMUNAL SPACE WILL BE PROVIDED.

REFER TO ESD CONSULANTS DOCUMENTATION FOR FULL DETAILS

No. Date Description 18.11.2022 Issued for Town Planning 15.03.2023 Issued for RFI Response 2 27.07.2023 Amended TP Submission

TOWN PLANNING NOT FOR CONSTRUCTION

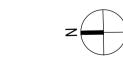

__KTA

Kerstin Thompson Architects Pty Ltd 277 Queensberry St, Melbourne Australia 3000 T +61 3 8662 8800 kta@kerstinthompson.com www.kerstinthompson.com

DRAWING TITLE APARTMENT PLAN - TYPE 1B-1, 1-B2, 1B-3 & 1B-4

PROJECT 97 Alma Road AT St Kilda East Neometro

DATE 27.07.2023 Author SCALE PROJECT TP61 As indicated(A1) 2202 k:/kta projects/

APT TYPE NUMBER

APT GROUND LEVEL 2B-1 G.01

INTERNAL STORAGE APT 2B-1

TYPE	LOCATION	VOLUME
2B-1	BEDROOM	3.0 m³
2B-1	BEDROOM	2.8 m³
2B-1	HALLWAY	2.9 m³
2B-1	KITCHEN	0.4 m³
2B-1	KITCHEN	0.3 m³
2B-1	KITCHEN	0.2 m ³
2B-1	KITCHEN	1.2 m³
2B-1	KITCHEN	0.1 m³
2B-1	KITCHEN	1.8 m³
2B-1	KITCHEN	0.3 m³
2B-1	LAUNDRY	0.8 m³
TOTAL INTERNAL STORAGE		13.9 m³

EXTERNAL STORAGE APT 2B-1

APT TYPE	LOCATION	VOLUME
2B-1	G.01 BSMNT STORAGE	6.1 m³
TOTAL EXTERNAL	:1	

APT TYPE 2B-2

LEVEL	APT TYPE	NUMBER
APT LEVEL 1	2B-2	1.01
APT LEVEL 2	2B-2	2.01
ΤΟΤΔΙ · 2		


City of Port Phillip Advertised Plan Planning Application No. PDPL/00823/2022 No. of Pages: 24 of 50


INTERNAL STORAGE APT 2B-2

TYPE	LOCATION	VOLUME
2B-2	BEDROOM	3.0 m ³
2B-2	BEDROOM	2.8 m³
2B-2	HALLWAY	2.9 m³
2B-2	KITCHEN	0.4 m³
2B-2	KITCHEN	0.3 m ³
2B-2	KITCHEN	0.2 m ³
2B-2	KITCHEN	1.2 m³
2B-2	KITCHEN	0.1 m ³
2B-2	KITCHEN	1.8 m³
2B-2	KITCHEN	0.3 m ³
2B-2	LAUNDRY	0.8 m ³
TOTAL INTERNAL	STORAGE	13.9 m³

EXTERNAL STORAGE APT 2B-2

APT TYPE	LOCATION	VOLUME
2B-2	1.01 BSMNT STORAGE	6.6 m³
2B-2	2.01 BSMNT STORAGE	6.1 m ³
TOTAL EXTERNAL	: 2	

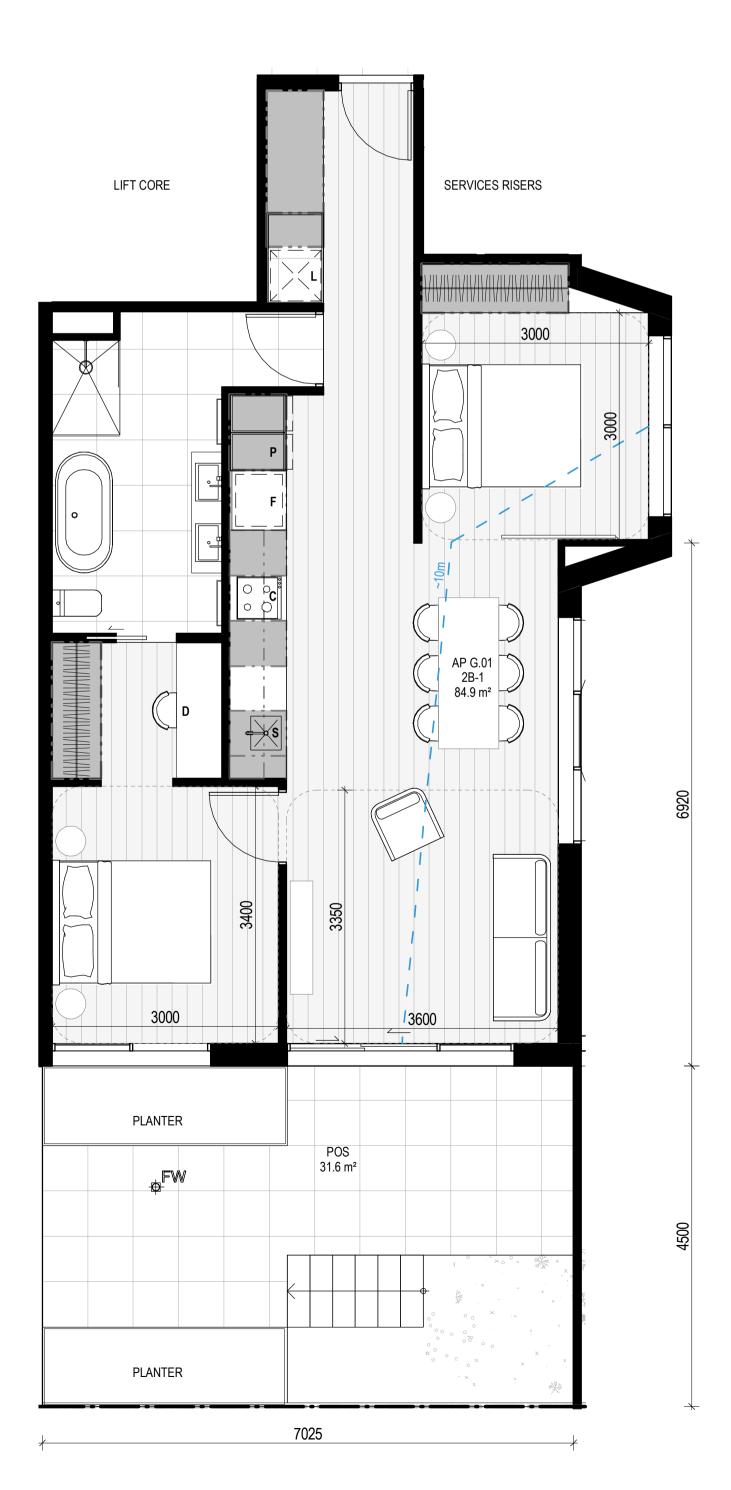

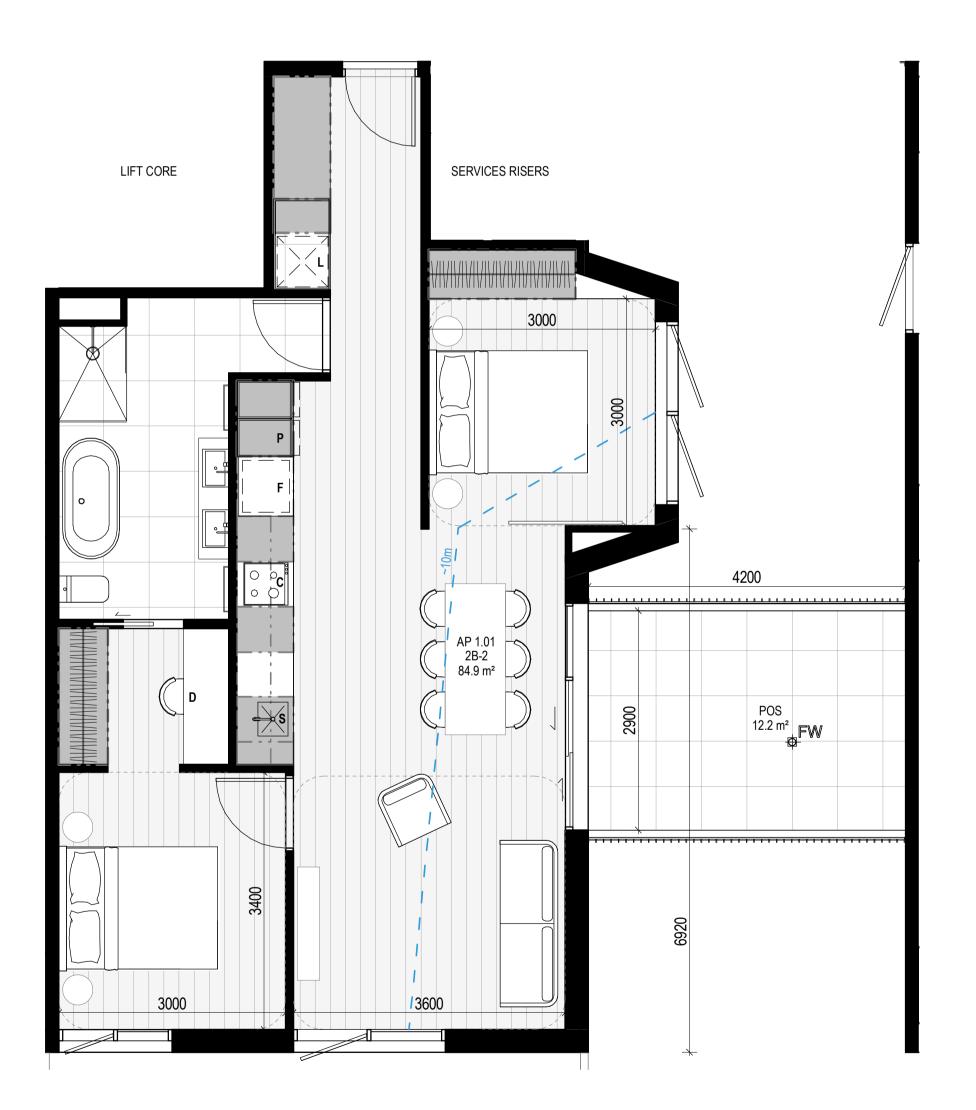

__APARTMENT NOTES

BATHROOM DESIGN OPTION UNDER APARTMENT DESIGN GUIDELINES FOR VICTORIA TABLE D4

L - LAUNDRY

P - PANTRY **F** - FRIDGE

S - SINK

C - COOKTOP D - DESK



_GENERAL NOTES

SURVEY: EXISTING SITE INFORMATION IS TAKEN FROM VERIS SURVEY NUMBER 303981-BG DATED 06/07/2023 AND IS PROVIDED HERE FOR ILLUSTRATIVE PURPOSES ONLY. FOR FULL SURVEY DETAILS REFER TO SURVEY DOCUMENTS PROVIDED WITHIN

APPENDICIES. LANDSCAPE DESIGN:

LANDSCAPE DESIGN IS SHOWN INDICATIVELY. FOR FULL LANDSCAPE DETAILS REFER TO LANDSCAPE ARCHITECT'S DOCUMENTATION.



EXISTING TREE WITHIN PROJECT BOUNDARY TO BE RETAINED. TREE NUMBER, TPZ AND CANOPY AS PER ARBORIST REPORT

AC CONDENSER UNIT
CL CLOTHES LINE
ELEC ELECTRICAL SERVICES HYDR HYDRAULIC SERVICES COM COMMS SERVICES FCL FINISHED CEILING LEVEL FFL FINISHED FLOOR LEVEL FHR FIRE HOSE REEL FHY FIRE HYDRANT
FIP FIRE INDICATOR PANEL FW FLOOR WASTE NGL NATURAL GROUND LEVEL

ABBREVIATIONS:

HW HOT WATER UNIT HP HEAT PUMP HOT WATER UNIT OW OPERABLE WINDOW

__ MATERIALS

RL RELATIVE LEVEL TP WATER TAP

BR1 BRICK WORK - BAGGED TEXTURE FINISH
BR2 BREEZE BLOCK
FC1 PAINTED FIBRE CEMENT SHEET

TL1 EXTERNAL TILE

SC1 SUN SHADESCREEN MT1 VERTICAL ALUMINIUM BALUSTRADE

MT2 GLAVANISED STEEL CLADDING MT3 METAL PERGOLA

GL1 GLAZING - DOUBLE CLEAR
GL2 OBSCURE GLAZING - REEDED MS1 CABLE MESH

MS2 MESH FENCING

MS3 MESH SCREEN AS1 ACOUSTIC WALL PANEL

SR1 SAFETY GUARD RAIL

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4. THE NON-RESIDENTIAL AREAS ARE TARGETING A 2% DF TO 40% OF THE NOMINATED AREA.

5. 35% (16 OUT OF 41) OF APARTMENTS ACHIEVE AT LEAST 3 HOURS OF SUNLIGHT.

6. THE DEVELOPMENT IS PROVIDED WITH A COMPREHENSIVE SHADING STRATEGY.

7. THE DEVELOPMENT IS TO ACHIEVE A 7.5 STAR AVERAGE NATHERS ENERGY RATING RESULT FOR THE TOWNHOUSES.

ENERGY RATING RESULT FOR THE TOWNHOUSES.

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18. IN TOTAL 2 BICYCLE SPACES ARE TO BE PROVIDED FOR RESIDENTIAL AND NON-RESIDENTIAL VISITORS.

20. ONE CHARGING POINT FOR ELECTRICAL VEHICLES IS INTEGRATED IN THE PROPOSED DEVELOPMENT.

21. 141M2 OF COMMUNAL SPACE WILL BE PROVIDED AT THE ROOFTOP DECK.

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No. Date Description 18.11.2022 Issued for Town Planning 15.03.2023 Issued for RFI Response 2 27.07.2023 Amended TP Submission

TOWN PLANNING NOT FOR CONSTRUCTION



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DRAWING TITLE APARTMENT PLAN - TYPE 2B-1 & 2B-2

97 Alma Road

AT St Kilda East Neometro

27.07.2023 JL/TM/LG SCALE PROJECT As indicated(A1) 2202


LEVEL	APT TYPE	NUMBER
APT LEVEL 1	2B-3	1.04
APT LEVEL 2	2B-3	2.05
APT GROUND LEVEL	2B-3	G.05

INTERNAL STORAGE APT 2B-3

TYPE	LOCATION	VOLUME
2B-3	BEDROOM	2.9 m³
2B-3	BEDROOM	2.9 m³
2B-3	KITCHEN	1.4 m³
2B-3	KITCHEN	0.4 m³
2B-3	KITCHEN	1.1 m³
2B-3	KITCHEN	0.2 m³
2B-3	KITCHEN	0.1 m³
2B-3	KITCHEN	0.2 m³
2B-3	KITCHEN	0.3 m³
2B-3	LAUNDRY	0.8 m³
TOTAL INTERNAL	STORAGE	10.4 m³

EXTERNAL STORAGE APT 2B-3

APTIYPE	LOCATION	VOLUME
2B-3	1.04 BSMNT STORAGE	6.1 m³
2B-3	2.05 BSMNT STORAGE	6.1 m³
2B-3	G.05 BSMNT STORAGE	6.1 m³
TOTAL EXTERNAL	: 3	

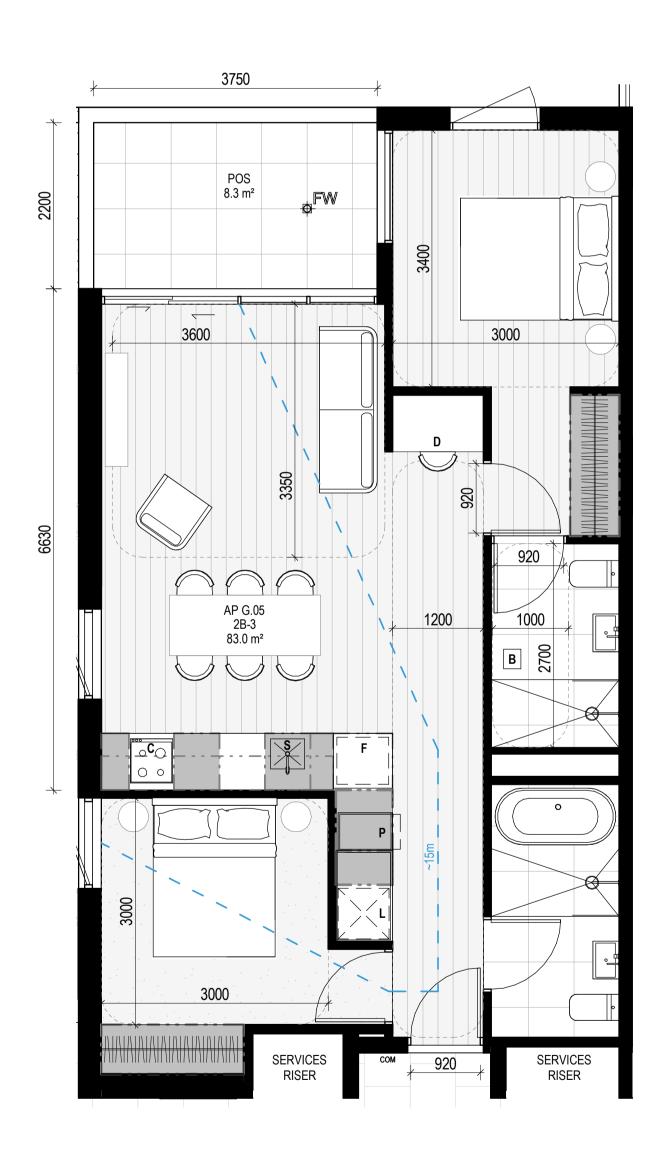

APT TYPE 2B-4

City of Port Phillip

Advertised Plan

Planning Application No. PDPL/00823/2022 No. of Pages: 25 of 50


LEVEL	APT TYPE	NUMBER
APT LEVEL 1	2B-4	1.07
APT LEVEL 2	2B-4	2.06
APT GROUND LEVEL	2B-4	G.08

INTERNAL STORAGE APT 2B-4

TYPE	LOCATION	VOLUME
2B-4	BEDROOM	4.7 m³
2B-4	BEDROOM	3.8 m³
2B-4	BEDROOM	1.9 m³
2B-4	KITCHEN	1.4 m³
2B-4	KITCHEN	0.4 m³
2B-4	KITCHEN	1.1 m³
2B-4	KITCHEN	0.2 m³
2B-4	KITCHEN	0.1 m³
2B-4	KITCHEN	0.2 m³
2B-4	KITCHEN	0.3 m³
2B-4	LAUNDRY	0.8 m³
TOTAL INTERNAL	STORAGE	15.0 m³

EXTERNAL STORAGE APT 2B-4

APT TYPE	LOCATION	VOLUME
2B-4	1.07 BSMNT STORAGE	6.1 m³
2B-4	2.06 BSMNT STORAGE	6.1 m ³
2B-4	G.08 BSMNT STORAGE	6.1 m ³
TOTAL EXTERNAL	: 3	

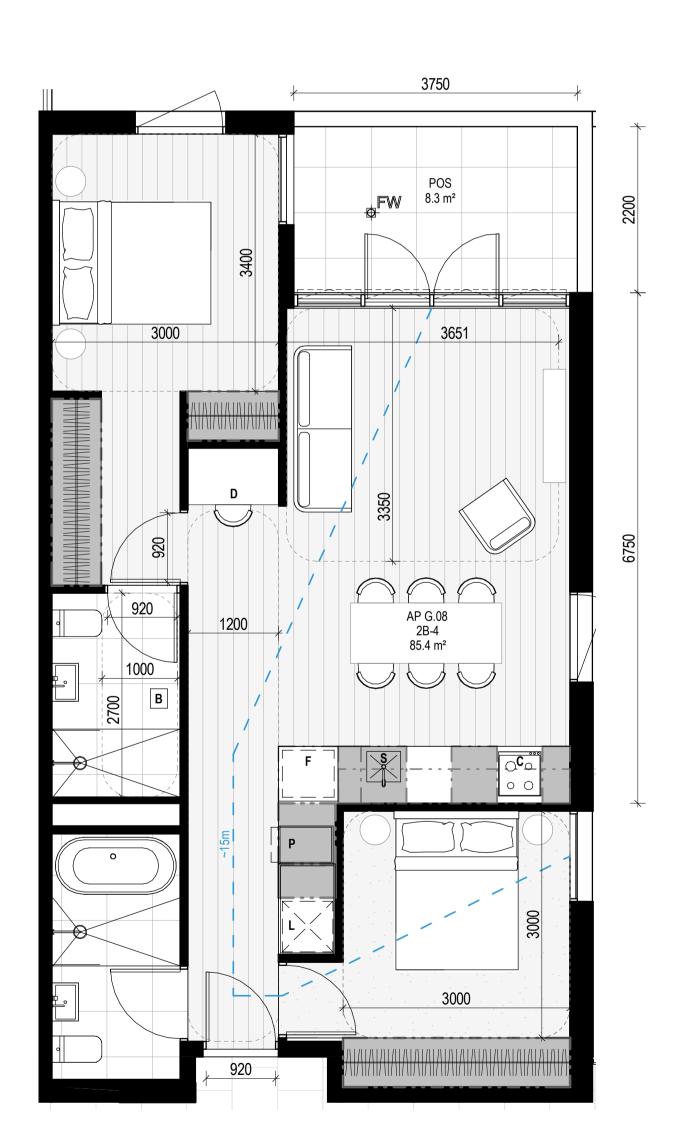

__APARTMENT NOTES

BATHROOM DESIGN OPTION UNDER APARTMENT DESIGN GUIDELINES FOR VICTORIA TABLE D4

L - LAUNDRY

P - PANTRY

F - FRIDGE

S - SINK

D - DESK



C - COOKTOP

_GENERAL NOTES

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DOCUMENTATION.

EXISTING TREE WITHIN PROJECT BOUNDARY TO BE RETAINED. TREE NUMBER, TPZ AND CANOPY

AS PER ARBORIST REPORT ABBREVIATIONS: AC CONDENSER UNIT
CL CLOTHES LINE
ELEC ELECTRICAL SERVICES

COM COMMS SERVICES FCL FINISHED CEILING LEVEL FFL FINISHED FLOOR LEVEL FHR FIRE HOSE REEL FHY FIRE HYDRANT
FIP FIRE INDICATOR PANEL FW FLOOR WASTE NGL NATURAL GROUND LEVEL RELATIVE LEVEL WATER TAP HW HOT WATER UNIT HP HEAT PUMP HOT WATER UNIT

HYDR HYDRAULIC SERVICES

__ MATERIALS

OW OPERABLE WINDOW

BR1 BRICK WORK - BAGGED TEXTURE FINISH
BR2 BREEZE BLOCK
FC1 PAINTED FIBRE CEMENT SHEET

TL1 EXTERNAL TILE

SC1 SUN SHADESCREEN MT1 VERTICAL ALUMINIUM BALUSTRADE

MT2 GLAVANISED STEEL CLADDING MT3 METAL PERGOLA GL1 GLAZING - DOUBLE CLEAR
GL2 OBSCURE GLAZING - REEDED

MS1 CABLE MESH MS2 MESH FENCING

MS3 MESH SCREEN

AS1 ACOUSTIC WALL PANEL SR1 SAFETY GUARD RAIL

ESD:

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5. 33% (16 OUT OF 41) OF APARTMENTS ACHIEVE AT LEAST 3 HOURS OF SUNLIGHT.

6. THE DEVELOPMENT IS PROVIDED WITH A COMPREHENSIVE SHADING STRATEGY.

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13. WATER EFFICIENT FITTINGS AND FIXTURES ARE APPLIED THROUGHOUT.

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20. ONE CHARGING POINT FOR ELECTRICAL VEHICLES IS INTEGRATED IN THE PROPOSED DEVELOPMENT.

21. 141M 20 F COMMUNAL SPACE WILL BE PROVIDED AT THE ROOFTOP DECK.

22. 24M2 OF COMMUNAL FOOD PRODUCTION AREA WILL BE PROVIDED.

REFER TO ESD CONSULANTS DOCUMENTATION FOR FULL DETAILS

No. Date Description 18.11.2022 Issued for Town Planning 15.03.2023 Issued for RFI Response

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DRAWING TITLE APARTMENT PLAN - TYPE 2B-3 & 2B-4

97 Alma Road

AT St Kilda East Neometro

DATE DRAWN BY 27.07.2023 JL/TM/LG SCALE PROJECT TP6.2 As indicated(A1) 2202



APT TYPE NUMBER APT GROUND LEVEL 2B-5 G.12

INTERNAL STORAGE APT 2B-5

TYPE	LOCATION	VOLUME
2B-5	BEDROOM	4.7 m³
2B-5	BEDROOM	3.9 m³
2B-5	BEDROOM	2.2 m³
2B-5	HALLWAY	1.7 m³
2B-5	KITCHEN	2.0 m³
2B-5	KITCHEN	0.6 m³
2B-5	KITCHEN	0.3 m³
2B-5	KITCHEN	0.5 m³
2B-5	KITCHEN	0.4 m³
2B-5	KITCHEN	0.1 m³
2B-5	KITCHEN	0.6 m³
2B-5	LAUNDRY	2.8 m³
TOTAL INTERNAL STORAGE		19.9 m³

EXTERNAL STORAGE APT 2B-5

2B-5	G.12 BSMNT STORAGE	6.3 m³
TOTAL EVEEDMAN	4	

LOCATION

VOLUME

TOTAL EXTERNAL: 1

APT TYPE 2B-6

LEVEL	APT TYPE	NUMBER
APT LEVEL 1	2B-6	1.11
APT LEVEL 2	2B-6	2.09
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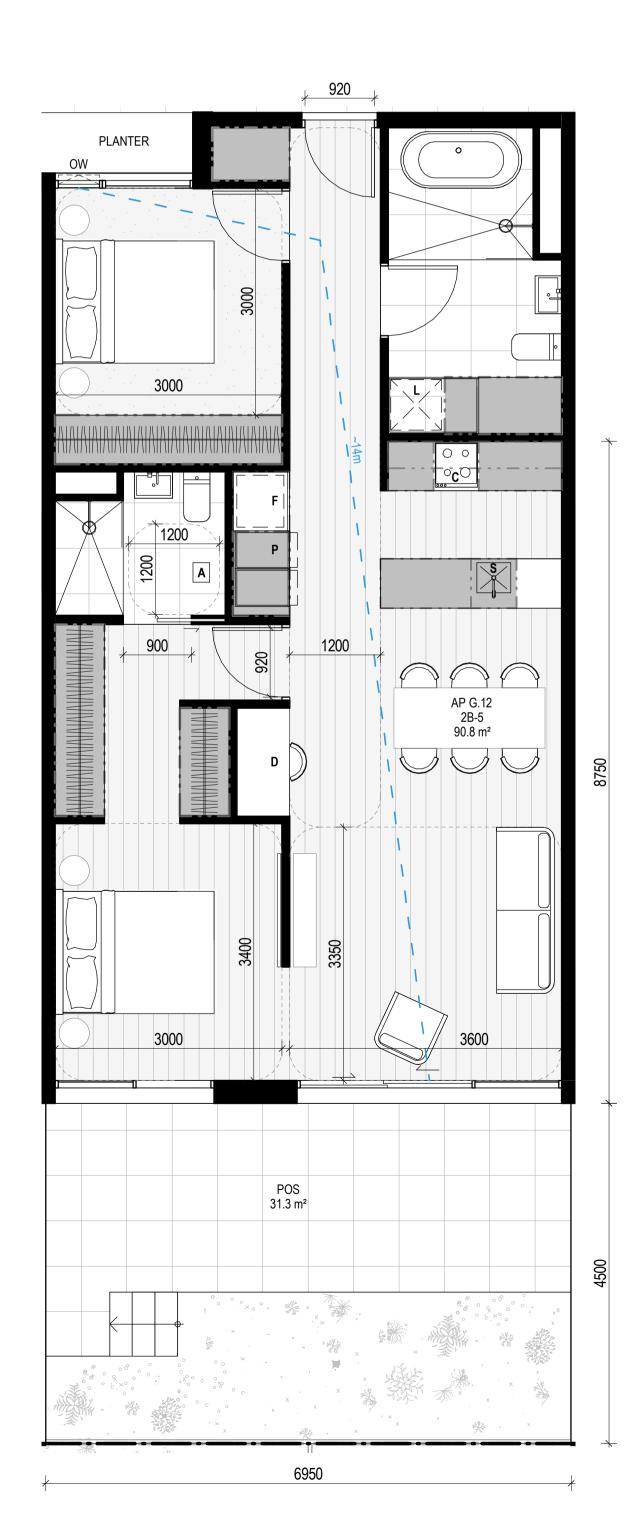
City of Port Phillip Advertised Plan Planning Application No. PDPL/00823/2022 No. of Pages: 26 of 50


INTERNAL STORAGE APT 2B-6

TYPE	LOCATION	VOLUME
2B-6	BEDROOM	4.7 m³
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2B-6	BEDROOM	2.2 m³
2B-6	HALLWAY	1.7 m³
2B-6	KITCHEN	2.0 m³
2B-6	KITCHEN	0.6 m³
2B-6	KITCHEN	0.3 m ³
2B-6	KITCHEN	0.5 m³
2B-6	KITCHEN	0.4 m³
2B-6	KITCHEN	0.1 m³
2B-6	KITCHEN	0.6 m³
2B-6	LAUNDRY	2.8 m³
TOTAL INTER	RNAL STORAGE	19.9 m³

EXTERNAL STORAGE APT 2B-6

APT TYPE	LOCATION	VOLUME
2B-6	1.11 BSMNT STORAGE	6.6 m ³
2B-6	2.09 BSMNT STORAGE	6.1 m ³
TOTAL EXTERNAL	: 2	



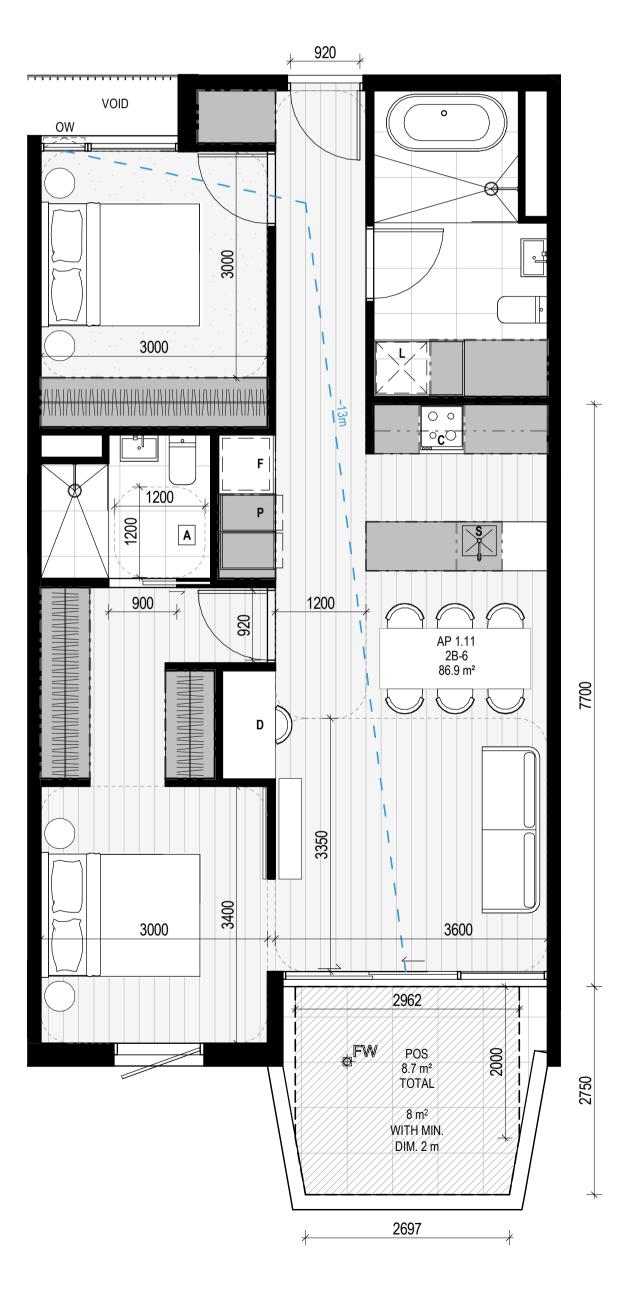

__APARTMENT NOTES

BATHROOM DESIGN OPTION UNDER APARTMENT DESIGN GUIDELINES FOR VICTORIA TABLE D4

L - LAUNDRY

P - PANTRY

F - FRIDGE

S - SINK

C - COOKTOP

D - DESK

-13m - BREEZE PATH



ABBREVIATIONS: AC CONDENSER UNIT CL CLOTHES LINE

SURVEY:



GENERAL NOTES

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CONSUMPTION BELOW THE REFERENCE CASE (BCA SECTION J 2019).

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10. A 9.6KW SOLAR PV SYSTEM IS TO BE LOCATED ON THE ROOF OF THE APARTMENT BUILDING.

11. A 2KW SOLAR PV SYSTEM IS TO BE PROVIDED FOR EACH TOWNHOUSE.

12. INDIVIDUAL COLD WATER AND ELECTRICITY METERS WILL BE PROVIDED TO THE APARTMENTS, TOWNHOUSES AND COMMUNAL AREAS.

13. WATER EFFICIENT FITTINGS AND FIXTURES ARE APPLIED THROUGHOUT.

14. A 32,000-LITRE RAINWATER TANK AND A 30,000-LITRE RAINWATER TANK WILL HARVEST RAINWATER FROM THE APARTMENT ROOF AND TOWNHOUSE ROOFS RESPECTIVELY. THESE TANKS WILL BE CONNECTED TO ALL TOILETS.

15. A MELBOURNE STORM RATING OF 102% IS ACHIEVED.

16. ALL LANDSCAPING IS TO BE NATIVE SPECIES OR LANDSCAPING IRRIGATION IS TO BE CONNECTED TO THE RAINWATER TANK ONLY.

17. IN TOTAL 62 BICYCLE SPACES ARE TO BE PROVIDED FOR RESIDENTS.

18. IN TOTAL 2 BICYCLE SPACES ARE TO BE PROVIDED FOR RESIDENTIAL AND NON-RESIDENTIAL VISITORS.

20. ONE CHARGING POINT FOR ELECTRICAL VEHICLES IS INTEGRATED IN THE PROPOSED DEVELOPMENT.

21. 141M2 OF COMMUNAL SPACE WILL BE PROVIDED AT THE ROOFTOP DECK.


22. 24M2 OF COMMUNAL SPACE WILL BE PROVIDED.

REFER TO ESD CONSULANTS DOCUMENTATION FOR FULL DETAILS

No. Date Description 18.11.2022 Issued for Town Planning

1 15.03.2023 Issued for RFI Response 2 27.07.2023 Amended TP Submission

> **TOWN PLANNING** NOT FOR CONSTRUCTION

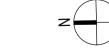

__KTA

Kerstin Thompson Architects Pty Ltd 277 Queensberry St, Melbourne Australia 3000 T +61 3 8662 8800 kta@kerstinthompson.com www.kerstinthompson.com

DRAWING TITLE APARTMENT PLAN - TYPE 2B-5 & 2B-6

97 Alma Road

AT St Kilda East Neometro

27.07.2023 JL/TM/LG As indicated(A1) 2202






APT TYPE NUMBER APT GROUND LEVEL 2B-7 G.14

INTERNAL STORAGE APT 2B-7

TYPE	LOCATION	VOLUME
2B-7	BEDROOM	3.0 m³
2B-7	BEDROOM	3.0 m³
2B-7	KITCHEN	0.4 m³
2B-7	KITCHEN	1.8 m³
2B-7	KITCHEN	0.7 m³
2B-7	KITCHEN	0.3 m³
2B-7	KITCHEN	0.1 m³
2B-7	KITCHEN	0.1 m³
2B-7	LAUNDRY	0.8 m³
TOTAL INTERNAL STORAGE 10.1 m ³		

EXTERNAL STORAGE APT 2B-7

AFITTEL	LOCATION	VOLUME
2B-7	G.14 BSMNT STORAGE	5.9 m³
TOTAL EXTERNAL	:1	•

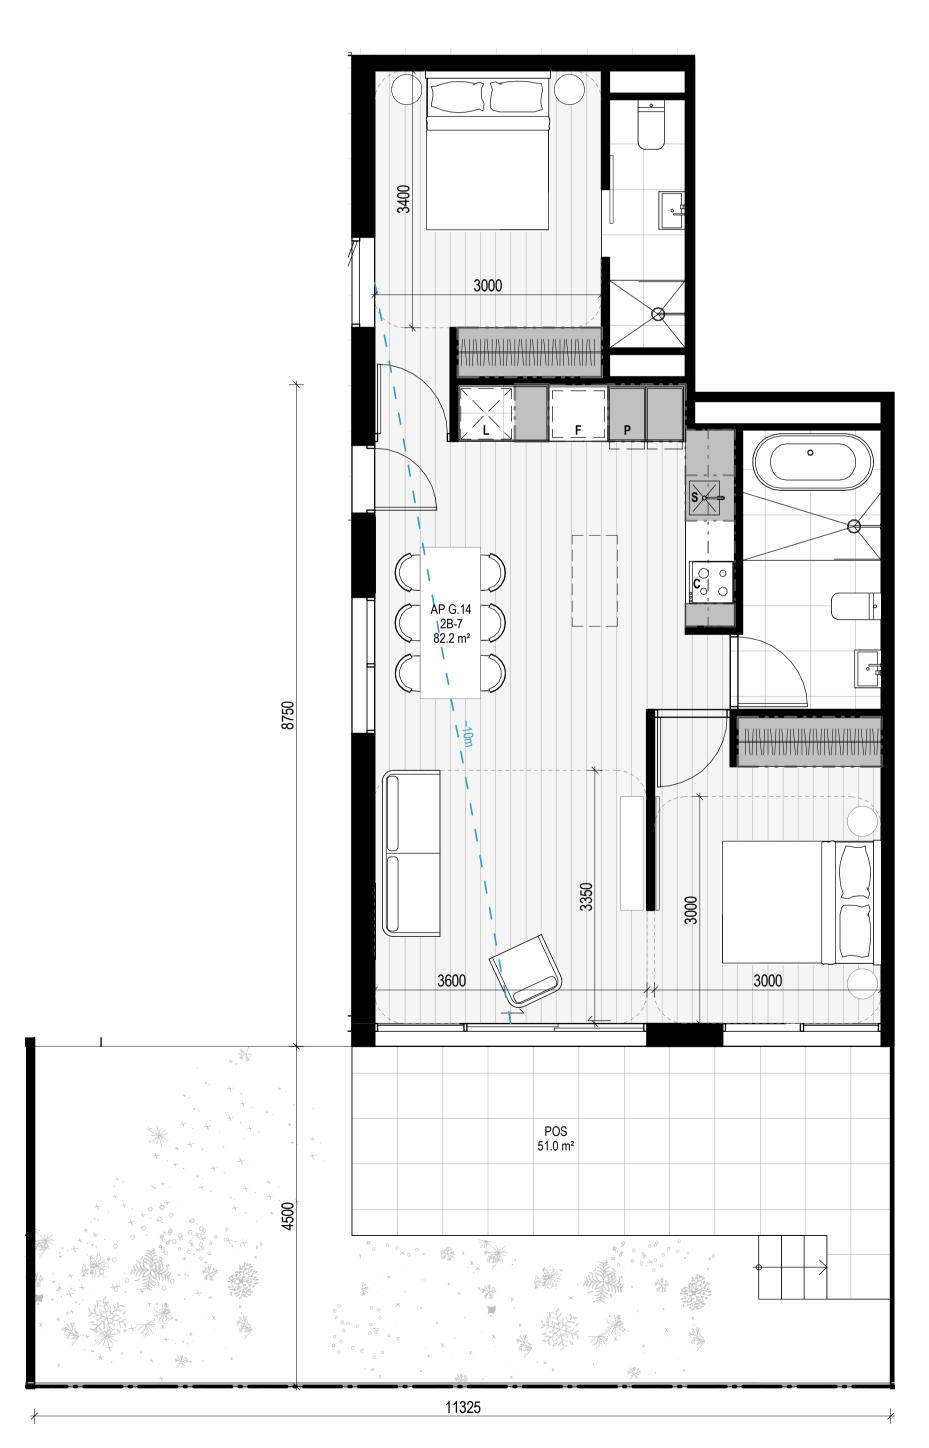

APT TYPE 2B-8


LEVEL	APTTYPE	NUMBER
APT LEVEL 1	2B-8	1.12
APT LEVEL 2	2B-8	2.11
TOTAL: 2	•	

INTERNAL STORAGE APT 2B-8

TYPE	LOCATION	VOLUME
2B-8	BEDROOM	4.7 m³
2B-8	BEDROOM	3.9 m³
2B-8	BEDROOM	2.2 m³
2B-8	KITCHEN	2.0 m ³
2B-8	KITCHEN	0.6 m ³
2B-8	KITCHEN	0.3 m ³
2B-8	KITCHEN	0.5 m ³
2B-8	KITCHEN	0.4 m³
2B-8	KITCHEN	0.1 m ³
2B-8	KITCHEN	0.6 m ³
2B-8	LAUNDRY	2.8 m³
TOTAL INTERNAL	STORAGE	18.2 m³

EXTERNAL STORAGE APT 2B-8

APT TYPE	LOCATION	VOLUM
2B-8	1.12 BSMNT STORAGE	5.9 m ³
2B-8	2.11 BSMNT STORAGE	5.9 m ³
TOTAL EXTERNAL	: 2	•

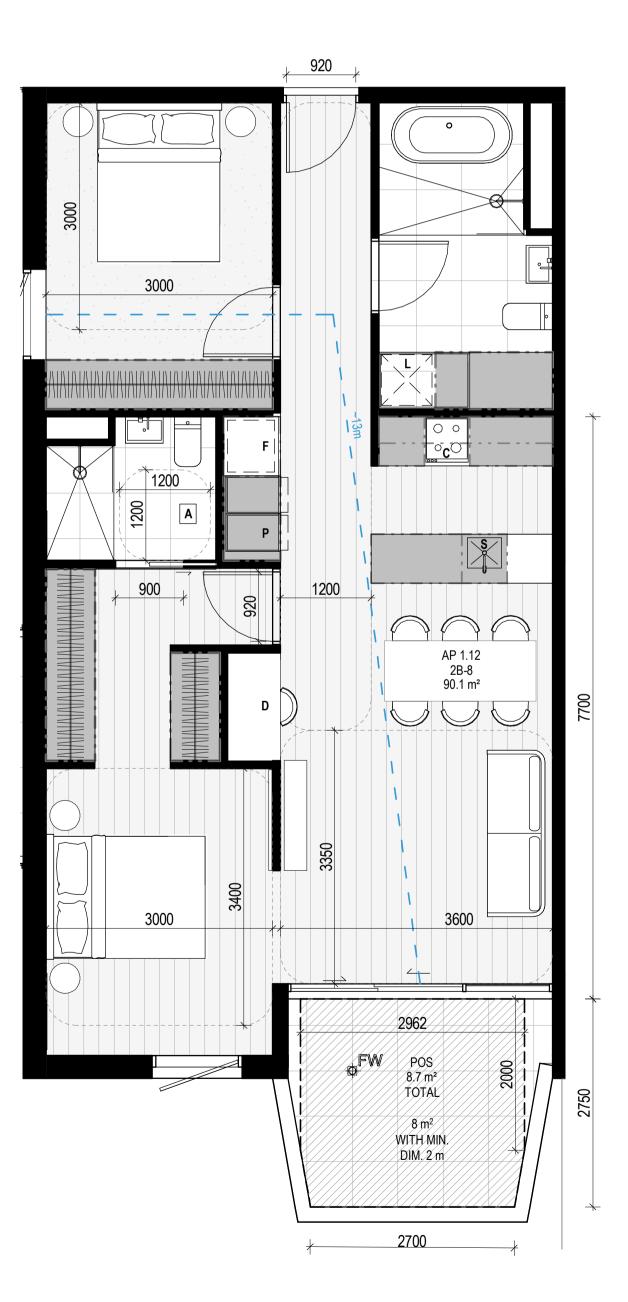

__APARTMENT NOTES

BATHROOM DESIGN OPTION UNDER APARTMENT DESIGN GUIDELINES FOR VICTORIA TABLE D4

L - LAUNDRY

P - PANTRY **F** - FRIDGE

S - SINK C - COOKTOP

D - DESK



City of Port Phillip Advertised Plan

Planning Application No. PDPL/00823/2022 No. of Pages: 27 of 50

_GENERAL NOTES SURVEY:

EXISTING SITE INFORMATION IS TAKEN FROM VERIS SURVEY NUMBER 303981-BG DATED 06/07/2023 AND IS PROVIDED HERE FOR ILLUSTRATIVE PURPOSES ONLY. FOR FULL SURVEY DETAILS REFER TO SURVEY DOCUMENTS PROVIDED WITHIN

APPENDICIES. LANDSCAPE DESIGN: LANDSCAPE DESIGN IS SHOWN INDICATIVELY. FOR FULL LANDSCAPE DETAILS REFER TO LANDSCAPE ARCHITECT'S



DOCUMENTATION.

EXISTING TREE WITHIN PROJECT BOUNDARY TO BE RETAINED. TREE NUMBER, TPZ AND CANOPY AS PER ARBORIST REPORT

ABBREVIATIONS: AC CONDENSER UNIT
CL CLOTHES LINE
ELEC ELECTRICAL SERVICES

HYDR HYDRAULIC SERVICES COM COMMS SERVICES FCL FINISHED CEILING LEVEL FFL FINISHED FLOOR LEVEL FHR FIRE HOSE REEL FHY FIRE HYDRANT
FIP FIRE INDICATOR PANEL

FW FLOOR WASTE NGL NATURAL GROUND LEVEL RELATIVE LEVEL WATER TAP HW HOT WATER UNIT

HP HEAT PUMP HOT WATER UNIT OW OPERABLE WINDOW

__ MATERIALS

BR1 BRICK WORK - BAGGED TEXTURE FINISH
BR2 BREEZE BLOCK

FC1 PAINTED FIBRE CEMENT SHEET TL1 EXTERNAL TILE

SC1 SUN SHADESCREEN MT1 VERTICAL ALUMINIUM BALUSTRADE

MT2 GLAVANISED STEEL CLADDING MT3 METAL PERGOLA GL1 GLAZING - DOUBLE CLEAR
GL2 OBSCURE GLAZING - REEDED

MS1 CABLE MESH MS2 MESH FENCING

MS3 MESH SCREEN AS1 ACOUSTIC WALL PANEL

SR1 SAFETY GUARD RAIL

ESD:

1. THE PROJECT ACHIEVES A TOTAL BESS SCORE OF 73% WITH NO MANDATORY CATEGORY (IEQ, ENERGY, WATER, STORMWATER) BELOW 50%.

2. 100% (41 OUT OF 41) OF THE DEVELOPMENT'S APARTMENTS AND 100% (21 OUT OF 21) OF THE DEVELOPMENT'S TOWNHOUSES ARE NATURALLY CROSS-VENTILATED.

3. DAYLIGHT MODELLING HAS BEEN CONDUCTED FOR A REPRESENTATIVE SAMPLE OF APARTMENTS. THE SUMMARY RESULT IS AS FOLLOWS:

• 88% OF LIVING FLOOR AREA ACHIEVES >90% ABOVE DF 1

• 92% OF BEDROOM FLOOR AREA ACHIEVES >90% ABOVE DF 0.5

4. THE NON-RESIDENTIAL AREAS ARE TARGETING A 2% DF TO 40% OF THE NOMINATED AREA.

5. 39% (16 OUT OF 41) OF APARTMENTS ACHIEVE AT LEAST 3 HOURS OF SUNLIGHT.

6. THE DEVELOPMENT IS PROVIDED WITH A COMPREHENSIVE SHADING STRATEGY. 6. THE DEVELOPMENT IS PROVIDED WITH A COMPREHENSIVE SHADING STRATEGY.
7. THE DEVELOPMENT IS TO ACHIEVE A 7.5 STAR AVERAGE NATHERS ENERGY RATING RESULT FOR THE APARTMENTS AND A 7.0 STAR AVERAGE NATHERS ENERGY RATING RESULT FOR THE TOWNHOUSES.

8. THE NON-RESIDENTIAL AREAS AIM TO REDUCE HEATING AND COOLING ENERGY CONSUMPTION BELOW THE REFERENCE CASE (BCA SECTION J 2019).

CONSUMPTION BELOW THE REFERENCE CASE (BCA SECTION J 2019).

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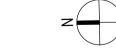
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No. Date Description 18.11.2022 Issued for Town Planning 15.03.2023 Issued for RFI Response 2 27.07.2023 Amended TP Submission

TOWN PLANNING NOT FOR CONSTRUCTION



__KTA

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DRAWING TITLE APARTMENT PLAN - TYPE 2B-7 & 2B-8

97 Alma Road

AT St Kilda East Neometro

27.07.2023 JL/TM/LG SCALE PROJECT As indicated(A1) 2202



APT TYPE NUMBER APT GROUND LEVEL 2BD-1 G.02

INTERNAL STORAGE APT 2BD-1

TYPE	LOCATION	VOLUME
2BD-1	BEDROOM	4.0 m³
2BD-1	BEDROOM	4.7 m³
2BD-1	BEDROOM	3.2 m³
2BD-1	DINING	2.2 m³
2BD-1	KITCHEN	1.1 m³
2BD-1	KITCHEN	0.2 m³
2BD-1	KITCHEN	0.3 m³
2BD-1	KITCHEN	0.9 m³
2BD-1	KITCHEN	0.4 m³
2BD-1	KITCHEN	0.2 m³
2BD-1	KITCHEN	0.1 m³
2BD-1	LAUNDRY	1.2 m³

EXTERNAL STORAGE APT 2BD-1

TOTAL INTERNAL STORAGE

LOCATION

G.02 BSMNT STORAGE 5.9 m³

City of Port Phillip Advertised Plan Planning Application No. PDPL/00823/2022 No. of Pages: 28 of 50



APT TYPE NUMBER APT GROUND LEVEL 2BD-2 G.13


INTERNAL STORAGE APT 2BD-2


III	LOCATION	VOLUME
2BD-2	BEDROOM	3.2 m³
2BD-2	BEDROOM	4.0 m ³
2BD-2	BEDROOM	4.7 m ³
2BD-2	DINING	2.2 m ³
2BD-2	KITCHEN	1.0 m ³
2BD-2	KITCHEN	0.2 m ³
2BD-2	KITCHEN	0.3 m ³
2BD-2	KITCHEN	0.9 m ³
2BD-2	KITCHEN	0.4 m ³
2BD-2	KITCHEN	0.2 m ³
2BD-2	KITCHEN	0.1 m ³
2BD-2	LAUNDRY	1.0 m ³
TOTAL INTERNAL	STORAGE	18.0 m³


EXTERNAL STORAGE APT 2BD-2


LOCATION

2BD-2 G.13 BSMNT STORAGE 5.9 m³

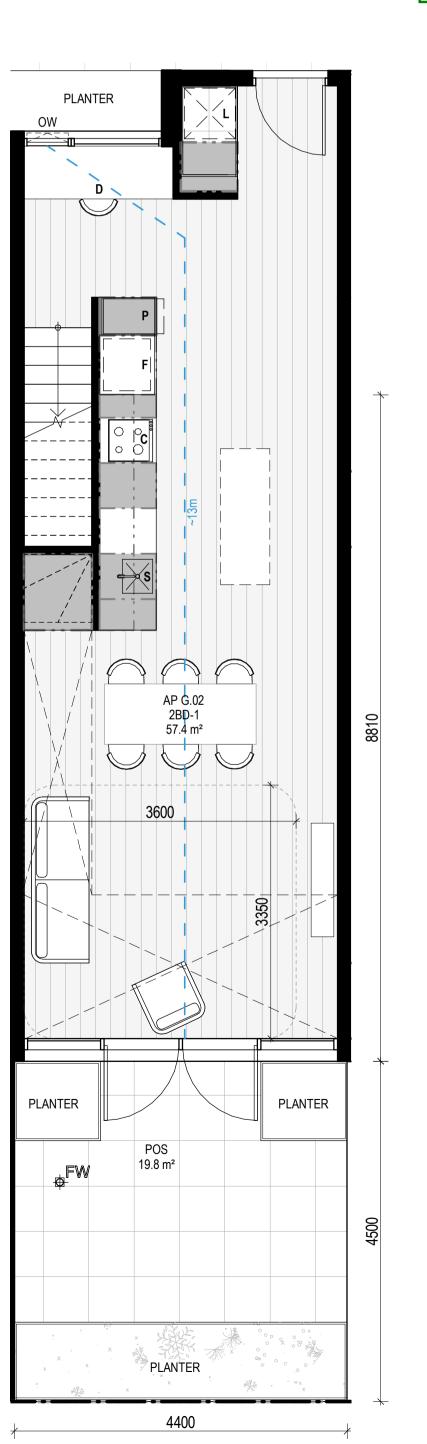

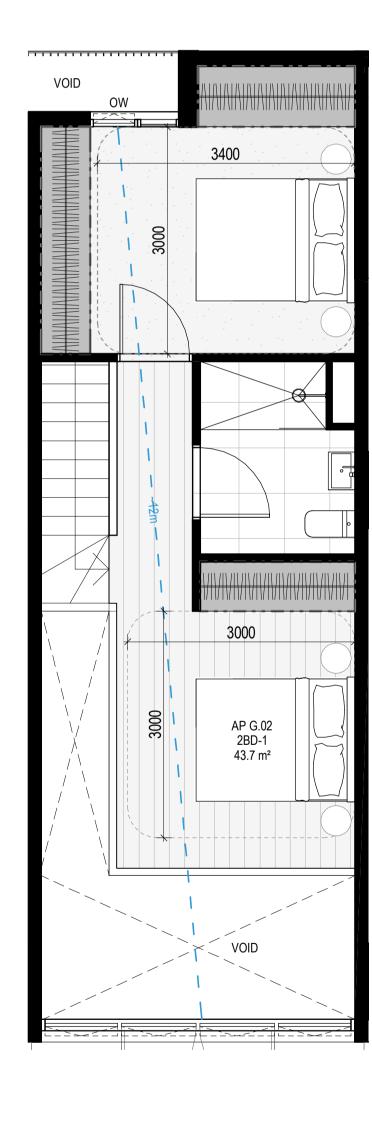

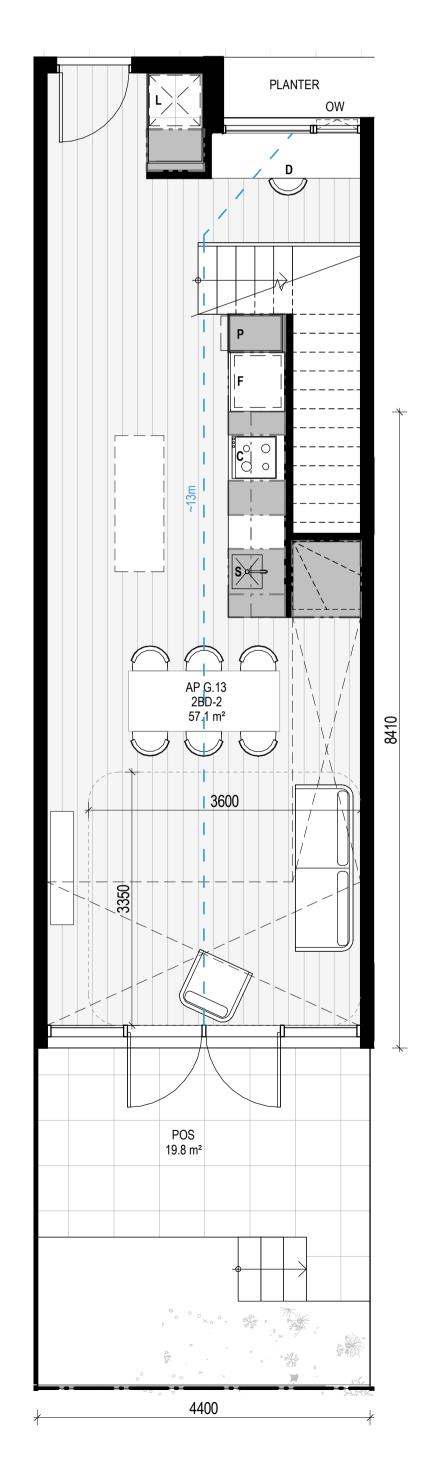

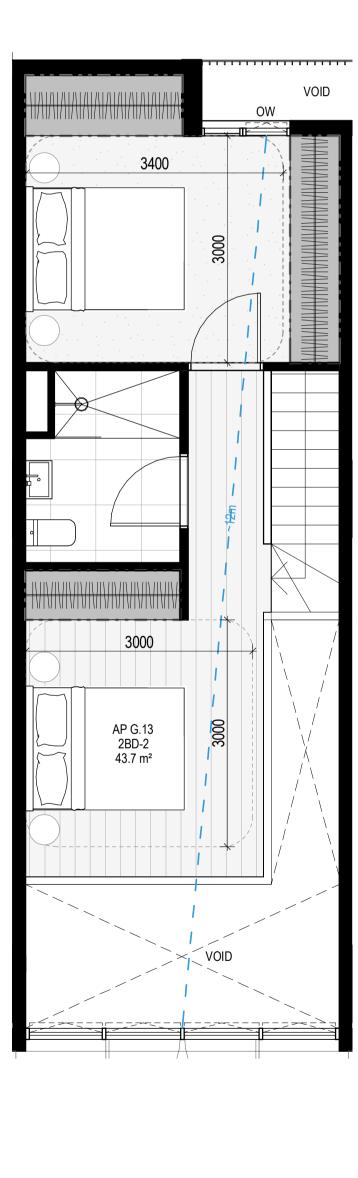

__APARTMENT NOTES

BATHROOM DESIGN OPTION UNDER APARTMENT DESIGN GUIDELINES FOR VICTORIA TABLE D4

- LAUNDRY

P - PANTRY **F** - FRIDGE

S - SINK

C - COOKTOP


D - DESK

-13m - BREEZE PATH

GENERAL NOTES

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LANDSCAPE DESIGN: LANDSCAPE DESIGN IS SHOWN INDICATIVELY. FOR FULL LANDSCAPE DETAILS REFER TO LANDSCAPE ARCHITECT'S

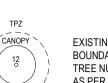

EXISTING TREE WITHIN PROJECT BOUNDARY TO BE RETAINED. TREE NUMBER, TPZ AND CANOPY AS PER ARBORIST REPORT

AC CONDENSER UNIT CL CLOTHES LINE ELEC ELECTRICAL SERVICES HYDR HYDRAULIC SERVICES COM COMMS SERVICES FCL FINISHED CEILING LEVEL FFL FINISHED FLOOR LEVEL FHR FIRE HOSE REEL FHY FIRE HYDRANT
FIP FIRE INDICATOR PANEL FW FLOOR WASTE NGL NATURAL GROUND LEVEL RELATIVE LEVEL WATER TAP

ABBREVIATIONS:

OW OPERABLE WINDOW

HP HEAT PUMP HOT WATER UNIT

HW HOT WATER UNIT

__ MATERIALS

BR1 BRICK WORK - BAGGED TEXTURE FINISH BR2 BREEZE BLOCK

FC1 PAINTED FIBRE CEMENT SHEET TL1 EXTERNAL TILE

SC1 SUN SHADESCREEN MT1 VERTICAL ALUMINIUM BALUSTRADE

MT2 GLAVANISED STEEL CLADDING MT3 METAL PERGOLA

GL1 GLAZING - DOUBLE CLEAR
GL2 OBSCURE GLAZING - REEDED

MS1 CABLE MESH MS2 MESH FENCING

MS3 MESH SCREEN

AS1 ACOUSTIC WALL PANEL SR1 SAFETY GUARD RAIL

ESD:

1. THE PROJECT ACHIEVES A TOTAL BESS SCORE OF 73% WITH NO MANDATORY 1. THE PROJECT ACHIEVES A TOTAL BESS SCORE OF 73% WITH NO MANDATORY CATEGORY (IEQ, ENERGY, WATER, STORMWATER) BELOW 50%.
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3. DAYLIGHT MODELLING HAS BEEN CONDUCTED FOR A REPRESENTATIVE SAMPLE OF APARTMENTS. THE SUMMARY RESULT IS AS FOLLOWS:

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4. THE NON-RESIDENTIAL AREAS ARE TARGETING A 2% DF TO 40% OF THE NOMINATED AREA.
5. 39% (16 OUT OF 41) OF APARTMENTS ACHIEVE AT LEAST 3 HOURS OF SUNLIGHT.
6. THE DEVELOPMENT IS PROVIDED WITH A COMPREHENSIVE SHADING STRATEGY. 6. THE DEVELOPMENT IS PROVIDED WITH A COMPREHENSIVE SHADING STRATEGY.
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ENERGY RATING RESULT FOR THE TOWNHOUSES.

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CONSUMPTION BELOW THE REFERENCE CASE (BCA SECTION J 2019).

9. THE DEVELOPMENT IS TO UTILISE ELECTRIC HEAT PUMP HOT WATER SYSTEM.

10. A 96KW SOLAR PV SYSTEM IS TO BE LOCATED ON THE ROOF OF THE APARTMENT BUILDING.

11. A 2KW SOLAR PV SYSTEM IS TO BE PROVIDED FOR EACH TOWNHOUSE.

12. INDIVIDUAL COLD WATER AND ELECTRICITY METERS WILL BE PROVIDED TO THE APARTMENTS, TOWNHOUSES
AND COMMUNAL AREAS.

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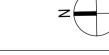
21. 141M2 OF COMMUNAL SPACE WILL BE PROVIDED AT THE ROOFTOP DECK.

22. 24M2 OF COMMUNAL SPACE WILL BE PROVIDED.

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No. Date Description 18.11.2022 Issued for Town Planning 15.03.2023 Issued for RFI Response 2 27.07.2023 Amended TP Submission

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DRAWING TITLE APARTMENT PLAN - TYPE 2BD-1 & 2BD-2

97 Alma Road

AT St Kilda East Neometro

27.07.2023 JL/TM/LG

As indicated(A1) 2202



LEVEL	APT TYPE	NUMBER	
PT LEVEL 1	2BD-3	1.05	
PT LEVEL 1	2BD-3	1.06	

INTERNAL STORAGE APT 2BD-3

TYPE	LOCATION	VOLUME
2BD-3	BEDROOM	3.7 m³
2BD-3	BEDROOM	4.7 m³
2BD-3	BEDROOM	3.2 m³
2BD-3	DINING	2.2 m³
2BD-3	KITCHEN	1.1 m³
2BD-3	KITCHEN	0.2 m³
2BD-3	KITCHEN	0.3 m³
2BD-3	KITCHEN	0.9 m³
2BD-3	KITCHEN	0.4 m³
2BD-3	KITCHEN	0.2 m³
2BD-3	KITCHEN	0.1 m³
2BD-3	LAUNDRY	0.8 m ³

EXTERNAL STORAGE APT 2BD-3

TOTAL INTERNAL STORAGE

APT TYPE	LOCATION	VOLUME
2BD-3	1.05 BSMNT STORAGE	5.9 m³
2BD-3	1.06 BSMNT STORAGE	2.8 m³
2BD-3	1.06 BSMNT STORAGE	2.5 m³
TOTAL EXTERNAL	: 3	

APT TY	PE 2BD-4	
LEVEL	APT TYPE	NUMBER
APT LEVEL 1	2BD-4	1.08
TOTAL: 1		


INTERNAL STORAGE APT 2BD-4


TYPE	LOCATION	VOLUME
2BD-4	BEDROOM	6.0 m³
2BD-4	BEDROOM	5.0 m ³
2BD-4	BEDROOM	3.2 m ³
2BD-4	KITCHEN	1.1 m³
2BD-4	KITCHEN	0.2 m ³
2BD-4	KITCHEN	0.3 m ³
2BD-4	KITCHEN	0.9 m ³
2BD-4	KITCHEN	0.4 m ³
2BD-4	KITCHEN	0.2 m ³
2BD-4	KITCHEN	0.1 m ³
2BD-4	LAUNDRY	2.1 m ³
TOTAL INTERNAL	STORAGE	19.5 m³


EXTERNAL STORAGE APT 2BD-4


APT TYPE	LOCATION	VOLUME
2BD-4	1.08 BSMNT STORAGE	5.9 m³
TOTAL EXTERNAL	: 1	

City of Port Phillip
Advertised Plan
Planning Application No. PDPL/00823/2022
No. of Pages: 29 of 50

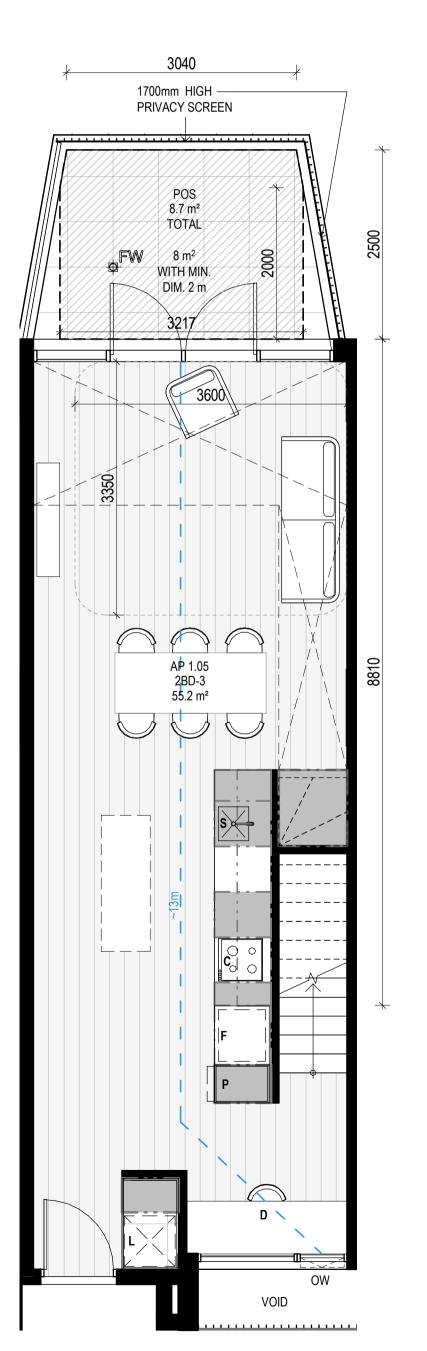

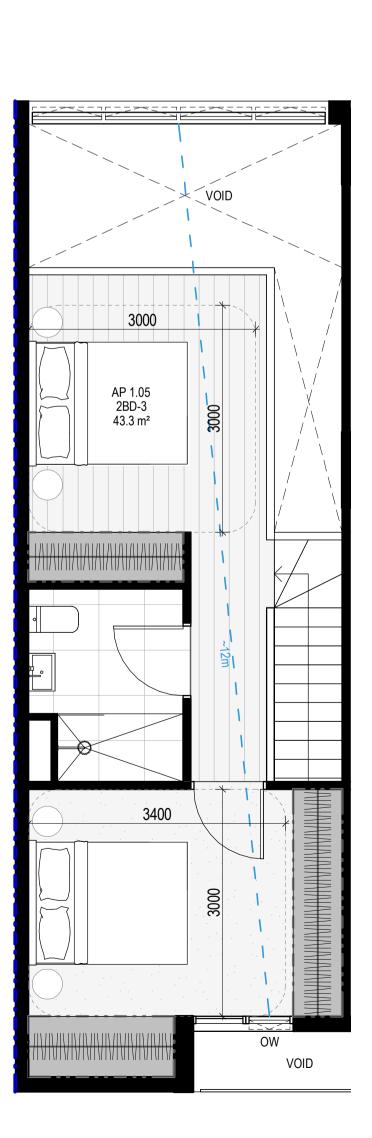

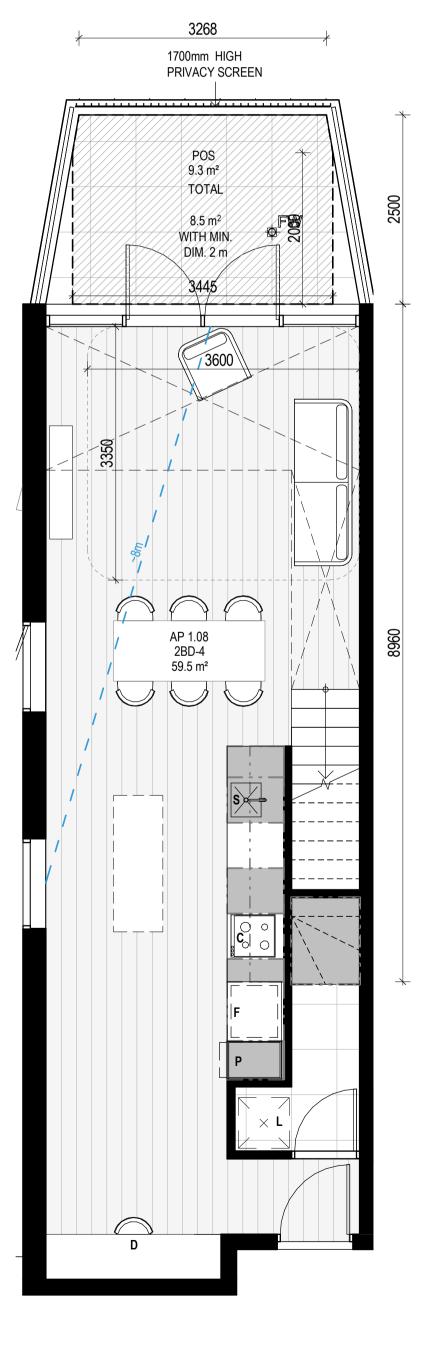

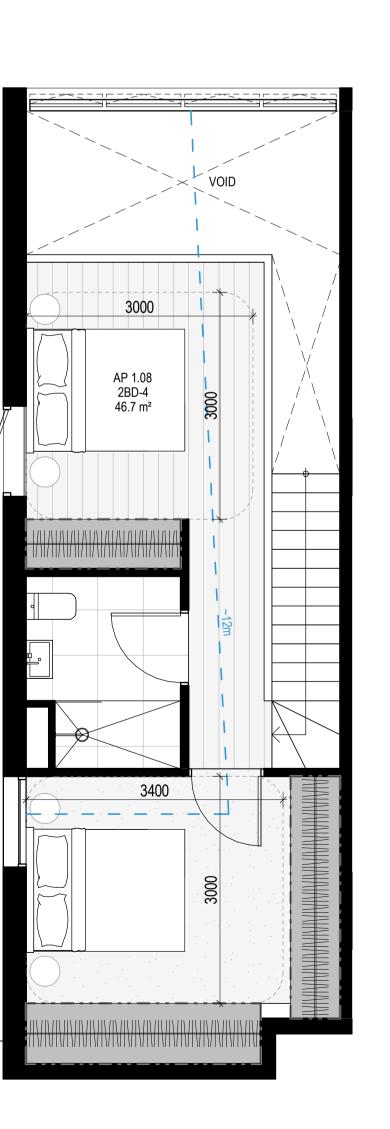

__APARTMENT NOTES

BATHROOM DESIGN OPTION UNDER APARTMENT DESIGN GUIDELINES FOR VICTORIA TABLE D4

L - LAUNDRY

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S - SINK

C - COOKTOP D - DESK



_GENERAL NOTES

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AS PER ARBORIST REPORT

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5. 35% (16 OUT OF 41) OF APARTMENTS ACHIEVE AT LEAST 3 HOURS OF SUNLIGHT.

6. THE DEVELOPMENT IS PROVIDED WITH A COMPREHENSIVE SHADING STRATEGY.

7. THE DEVELOPMENT IS TO ACHIEVE A 7.5 STAR AVERAGE NATHERS ENERGY RATING RESULT FOR THE TOWNHOUSES.

ENERGY RATING RESULT FOR THE TOWNHOUSES.

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APARTMENT BUILDING.

11. A 2KW SOLAR PV SYSTEM IS TO BE PROVIDED FOR EACH TOWNHOUSE.

12. INDIVIDUAL COLD WATER AND ELECTRICITY METERS WILL BE PROVIDED TO THE APARTMENTS, TOWNHOUSES AND COMMUNAL AREAS.

13. WATER EFFICIENT FITTINGS AND FIXTURES ARE APPLIED THROUGHOUT.

14. A 32,000-LITRE RAINWATER TANK AND A 30,000-LITRE RAINWATER TANK WILL HARVEST RAINWATER FROM THE APARTMENT ROOF AND TOWNHOUSE ROOFS RESPECTIVELY. THESE TANKS WILL BE CONNECTED TO ALL TOILETS.

15. A MELBOURNE STORM RATING OF 102% IS ACHIEVED.

16. ALL LANDSCAPING IS TO BE NATIVE SPECIES OR LANDSCAPING IRRIGATION IS TO BE CONNECTED TO THE RAINWATER TANK ONLY.

17. IN TOTAL 62 BICYCLE SPACES ARE TO BE PROVIDED FOR RESIDENTS.

18. IN TOTAL 16 BICYCLE SPACES ARE TO BE PROVIDED FOR RESIDENTIAL AND NON-RESIDENTIAL VISITORS.

20. ONE CHARGING POINT FOR ELECTRICAL VEHICLES IS INTEGRATED IN THE


NON-RESIDENTIAL VISITORS.
20. ONE CHARGING POINT FOR ELECTRICAL VEHICLES IS INTEGRATED IN THE PROPOSED DEVELOPMENT.
21. 141M2 OF COMMUNAL SPACE WILL BE PROVIDED AT THE ROOFTOP DECK.
22. 24M2 OF COMMUNAL FOOD PRODUCTION AREA WILL BE PROVIDED.

REFER TO ESD CONSULANTS DOCUMENTATION FOR FULL DETAILS

No. Date Description 18.11.2022 Issued for Town Planning 15.03.2023 Issued for RFI Response

2 27.07.2023 Amended TP Submission

TOWN PLANNING NOT FOR CONSTRUCTION

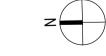

__KTA

Kerstin Thompson Architects Pty Ltd 277 Queensberry St, Melbourne Australia 3000 T +61 3 8662 8800 kta@kerstinthompson.com www.kerstinthompson.com

DRAWING TITLE APARTMENT PLAN - TYPE 2BD-3 & 2BD-4

97 Alma Road

AT St Kilda East Neometro

As indicated(A1) 2202

27.07.2023 JL/TM/LG



APT TYPE 3B-1	APT TYPE 3B-2	APT TYPE 3B-3	APT TYPE 3B-4		
LEVEL APT TYPE NUMBER	LEVEL APT TYPE NUMBER	LEVEL APT TYPE NUMBER	LEVEL APT TYPE NUMBER		GENERAL NOTES
APT GROUND LEVEL 3B-1 G.04 TOTAL: 1	APT LEVEL 1 3B-2 1.03 TOTAL: 1	APT LEVEL 2 3B-3 2.04 TOTAL: 1	APT LEVEL 3 3B-4 3.03 TOTAL: 1		RVEY: STING SITE INFORMATION IS TAKEN FROM VERIS SURVEY
				RATHROOM DESIGN OPTION LINDER APARTMENT NUM	MBER 303981-BG DATED 06/07/2023 AND IS PROVIDED HERE R ILLUSTRATIVE PURPOSES ONLY. FOR FULL SURVEY
INTERNAL STORAGE APT 3B-1	INTERNAL STORAGE APT 3B-2 & 3B-3	EXTERNAL STORAGE APT 3B-3	INTERNAL STORAGE APT 3B-4	DET	TAILS REFER TO SURVEY DOCUMENTS PROVIDED WITHIN PENDICIES.
TYPE LOCATION VOLUME	TYPE LOCATION VOLUME	APT TYPE LOCATION VOLUME	TYPE LOCATION VOLUME	D DANTEY LAN	IDSCAPE DESIGN:
3B-1 BEDROOM 2.1 m³	3B-2 BEDROOM 2.1 m³	3B-3 2.04 BSMNT STORAGE 8.0 m³		E FRIDE	IDSCAPE DESIGN IS SHOWN INDICATIVELY. FOR FULL IDSCAPE DETAILS REFER TO LANDSCAPE ARCHITECT'S CUMENTATION.
3B-1 BEDROOM 4.4 m ³ 3B-1 BEDROOM 3.8 m ³	3B-2 BEDROOM 4.4 m³ 3B-2 BEDROOM 4.6 m³	TOTAL EXTERNAL: 1	3B-4 BEDROOM 2.1 m³ 3B-4 BEDROOM 4.4 m³ 3B-4 BEDROOM 6.6 m³	S - SINK	SOMENTATION.
3B-1 BEDROOW 3.0 III 3B-1 HALLWAY 0.4 m ³ 3B-1 KITCHEN 0.9 m ³	3B-2 HALLWAY 0.4 m³ 3B-2 KITCHEN 0.9 m³	APT 3B-3 / 2.04 LAYOUT AND STORAGE ARE AS	3B-4 HALLWAY 0.4 m ³ 3B-4 KITCHEN 0.9 m ³	C - COOKTOP	CANOPY EXISTING TREE WITHIN PROJECT
3B-1 KITCHEN 0.4 m³	3B-2 KITCHEN 0.4 m³	APT 3B-2 / 1.03.	3B-4 KITCHEN 0.4 m³	D - DESK	BOUNDARY TO BE RETAINED. TREE NUMBER, TPZ AND CANOPY
3B-1 KITCHEN 1.0 m³	3B-2 KITCHEN 1.0 m³		3B-4 KITCHEN 1.0 m ³	— - BREEZE PATH	AS PER ARBORIST REPORT
3B-1 KITCHEN 0.9 m³ 3B-1 KITCHEN 0.7 m³	3B-2 KITCHEN 0.9 m³ 3B-2 KITCHEN 0.7 m³		3B-4 KITCHEN 0.9 m³ 3B-4 KITCHEN 0.7 m³	~13m	
3B-1 KITCHEN 0.1 m³ 3B-1 LAUNDRY 0.7 m³	3B-2 KITCHEN 0.1 m³ 3B-2 LAUNDRY 0.7 m³	020	3B-4 KITCHEN 0.1 m³ 3B-4 LAUNDRY 0.7 m³	ABE	BREVIATIONS: CONDENSER UNIT
TOTAL INTERNAL STORAGE 15.8 m³	TOTAL INTERNAL STORAGE 16.6 m³		TOTAL INTERNAL STORAGE 18.5 m³	CL	CLOTHES LINE CC ELECTRICAL SERVICES
				HYD	DR HYDRAULIC SERVICES M COMMS SERVICES
				FCL FFL	FINISHED CEILING LEVEL FINISHED FLOOR LEVEL
EXTERNAL STORAGE APT 3B-1	EXTERNAL STORAGE APT 3B-2	1350	EXTERNAL STORAGE APT 3B-4	FHY	
APT TYPE LOCATION VOLUME	APT TYPE LOCATION VOLUME		APT TYPE LOCATION VOLUME	FIP FW NGL	FLOOR WASTE
3B-1 G.04 BSMNT STORAGE 8.0 m³ TOTAL EXTERNAL: 1	3B-2 1.03 BSMNT STORAGE 8.0 m³ TOTAL EXTERNAL: 1	82	3B-4 3.03 BSMNT STORAGE 8.0 m³ TOTAL EXTERNAL: 1	RL TP	RELATIVE LEVEL WATER TAP
		33		HP	HOT WATER UNIT HEAT PUMP HOT WATER UNIT
				OW	OPERABLE WINDOW
					MATERIALS
				-	_ IVIA I LIVIALO
				В	BRICK WORK - BAGGED TEXTURE FINISH BREEZE BLOCK
		*		F T	C1 PAINTED FIBRE CEMENT SHEET L1 EXTERNAL TILE
City of Port Phillip Advertised Plan		1250		N	SUN SHADESCREEN VERTICAL ALUMINIUM BALUSTRADE
Advertised Plan Planning Application No. PDPL /0/	0823/2022			N	IT2 GLAVANISED STEEL CLADDING IT3 METAL PERGOLA GL1 GLAZING - DOUBLE CLEAR
Planning Application No. PDPL/00 No. of Pages: 30 of 50	0023/2022	AP 2.04 POS 15.6 m ²		G	SL2 OBSCURE GLAZING - REEDED 1S1 CABLE MESH
110. or rageo. oo or oo		15.6 m² TOTAL		N	IS2 MESH FENCING IS3 MESH SCREEN
		10.2 m ²		A	AS1 ACOUSTIC WALL PANEL SAFETY GUARD RAIL
		WITH MIN DIM. 1.7 m			
		DIWIZ I. P III			
<u>∤ 1350</u> ∤ 4370	1350 + 4370		1250 4370	─ ¥	D: HE PROJECT ACHIEVES A TOTAL BESS SCORE OF 73% WITH NO MANDATORY TEGORY (IEQ, ENERGY, WATER, STORMWATER) BELOW 50%.
				2.1 21) 3.0	00% (41 OUT OF 41) OF THE DEVELOPMENT'S ÁPARTMENTS AND 100% (21 OUT OF OF THE DEVELOPMENT'S TOWNHOUSES ARE NATURALLY CROSS-VENTILATED. DAYLIGHT MODELLING HAS BEEN CONDUCTED FOR A REPRESENTATIVE SAMPLE
				• 92	AYLIGHT MODELLING HAS BEEN CONDUCTED FOR A REPRESENTATIVE SAMPLE APARTMENTS. THE SUMMARY RESULT IS AS FOLLOWS: (% OF LVING FLOOR AREA ACHIEVES >90% ABOVE DF 1 (% OF BEDROOM FLOOR AREA ACHIEVES >90% ABOVE DF 0.5 HE NON-RESIDENTIAL AREAS ARE TARGETING A 2% DF TO 40% OF THE
3000		3000	3600	3000 NOI 5.3	MINATED AREA. 9% (16 OUT OF 41) OF APARTMENTS ACHIEVE AT LEAST 3 HOURS OF SUNLIGHT.
3600	3600			7.T RA	HE DEVELOPMENT IS PROVIDED WITH A COMPREHENSIVE SHADING STRATEGY. HE DEVELOPMENT IS TO ACHIEVE A 7.5 STAR AVERAGE NATHERS ENERGY TING RESULT FOR THE APARTMENTS AND A 7.0 STAR AVERAGE NATHERS
				8.T	ERGY RATING RESULT FOR THE TOWNHOUSES. HE NON-RESIDENTIAL AREAS AIM TO REDUCE HEATING AND COOLING ENERGY NSUMPTION BELOW THE REFERENCE CASE (BCA SECTION J 2019). HE REVEL ORMENT IS TO LITTLES ELECTRIC HEAT DIMED HOT WATER SYSTEM.
				AP/	HE DEVELOPMENT IS TO UTILISE ELECTRIC HEAT PUMP HOT WATER SYSTEM. A 9.6KW SOLAR PV SYSTEM IS TO BE LOCATED ON THE ROOF OF THE ARTMENT BUILDING. A 2KW SOLAR PV SYSTEM IS TO BE PROVIDED FOR EACH TOWNHOUSE.
338	338		332	12. AP/	INDIVIDUAL COLD WATER AND ELECTRICITY METERS WILL BE PROVIDED TO THE ARTMENTS, TOWNHOUSES D COMMUNAL AREAS.
1 1 250	13.	WATER EFFICIENT FITTINGS AND FIXTURES ARE APPLIED THROUGHOUT. A 32,000-LITRE RAINWATER TANK AND A 30,000-LITRE RAINWATER TANK WILL RVEST RAINWATER FROM THE
			7 00	AP/ COI	ARTMENT ROOF AND TOWNHOUSE ROOFS RESPECTIVELY. THESE TANKS WILL BE NNECTED TO ALL TOLLETS. A MELBOURNE STORM RATING OF 102% IS ACHIEVED.
				16. BE	ALL LANDSCAPING IS TO BE NATIVE SPECIES OR LANDSCAPING IRRIGATION IS TO CONNECTED TO THE RAINWATER TANK ONLY. IN TOTAL 62 BICYCLE SPACES ARE TO BE PROVIDED FOR RESIDENTS.
				18. 19.	IN TOTAL 2 BICYCLE SPACES ARE TO BE PROVIDED FOR STAFF. IN TOTAL 16 BICYCLE SPACES ARE TO BE PROVIDED FOR RESIDENTIAL AND N-RESIDENTIAL VISITORS.
				20. PR	ONE CHARGING POINT FOR ELECTRICAL VEHICLES IS INTEGRATED IN THE OPOSED DEVELOPMENT. 141M2 OF COMMUNAL SPACE WILL BE PROVIDED AT THE ROOFTOP DECK.
	AP 1.03				24M2 OF COMMUNAL FOOD PRODUCTION AREA WILL BE PROVIDED. FER TO ESD CONSULANTS DOCUMENTATION FOR FULL DETAILS
AP G.04 3B-1	3B-2 121.7 m²	2000			
119.1 m ² 3000		3000	AD 202	3000	
FW J			AP 3.03 3B-4		
1250	1250		1250 1700 129.7 m ²		No. Date Description 0 18.11.2022 Issued for Town Planning
POS	POS 16.6 m ²		Pos	3000	1 15.03.2023 Issued for RFI Response 2 27.07.2023 Amended TP Submission
POS 16.6 m² TOTAL S	16.6 m²		16.8 m ²		Z Z1.01.2020 Amended II Gustiliosion
10.2 m ²	10.2 m ²		10.2 m ²		
WITH MIN. DIM. 1.7 m	WITH MIN. DIM. X.7. m		WITH MIN		
F P 1200	F	P 1200			
1200		1200		1200	TOWN PLANNING
			310		NOT FOR CONSTRUCTION
3000 A A		A 7 A 7	F P		
	3000				Z
				1200	
					_KTA
8					Kerstin Thompson Architects Pty Ltd
			8	L	277 Queensberry St, Melbourne Australia 3000 T +61 3 8662 8800
			3000		kta@kerstinthompson.com www.kerstinthompson.com
					AWING TITLE
FIP		000	a d	AP	ARTMENT PLAN - TYPE 3B-1, 3B-2, 3B-3 & 3B-4
SERVICES RISER		→ 920 → SERVICES RISER	8	920 SERVICES RISER PRO 97	DJECT Alma Poad
1 1	n		340	AT	Alma Road St Kilda East Neometro
				FOF DAT	TE DRAWN BY DRAWING NO. REV.
				27. SC/	07.2023 JL/TM/LG ALE PROJECT 101dicated(A1) PROJECT 2202 TP630 2
				K://kt	a projects/ copyright 2022

APT TYPE 3B-4

APT TYPE 3B-2

APT TYPE 3B-1

LEVEL	APT TYPE	NUMBER	
APT GROUND LEVEL	3B-5	G.10]


INTERNAL STORAGE APT 3B-5 & 3B-6

TYPE	LOCATION	VOLUME
3B-5	BEDROOM	2.3 m³
3B-5	BEDROOM	4.0 m³
3B-5	BEDROOM	2.5 m³
3B-5	BEDROOM	1.6 m³
3B-5	HALLWAY	2.1 m³
3B-5	KITCHEN	0.9 m³
3B-5	KITCHEN	0.4 m³
3B-5	KITCHEN	0.4 m³
3B-5	KITCHEN	0.7 m³
3B-5	KITCHEN	1.2 m³
3B-5	KITCHEN	0.8 m³
3B-5	KITCHEN	0.1 m³
3B-5	LAUNDRY	0.7 m ³

EXTERNAL STORAGE APT 3B-5

TOTAL INTERNAL STORAGE

APT TYPE	LOCATION	VOLUME
3B-5	G.10 BSMNT STORAGE	8.0 m³

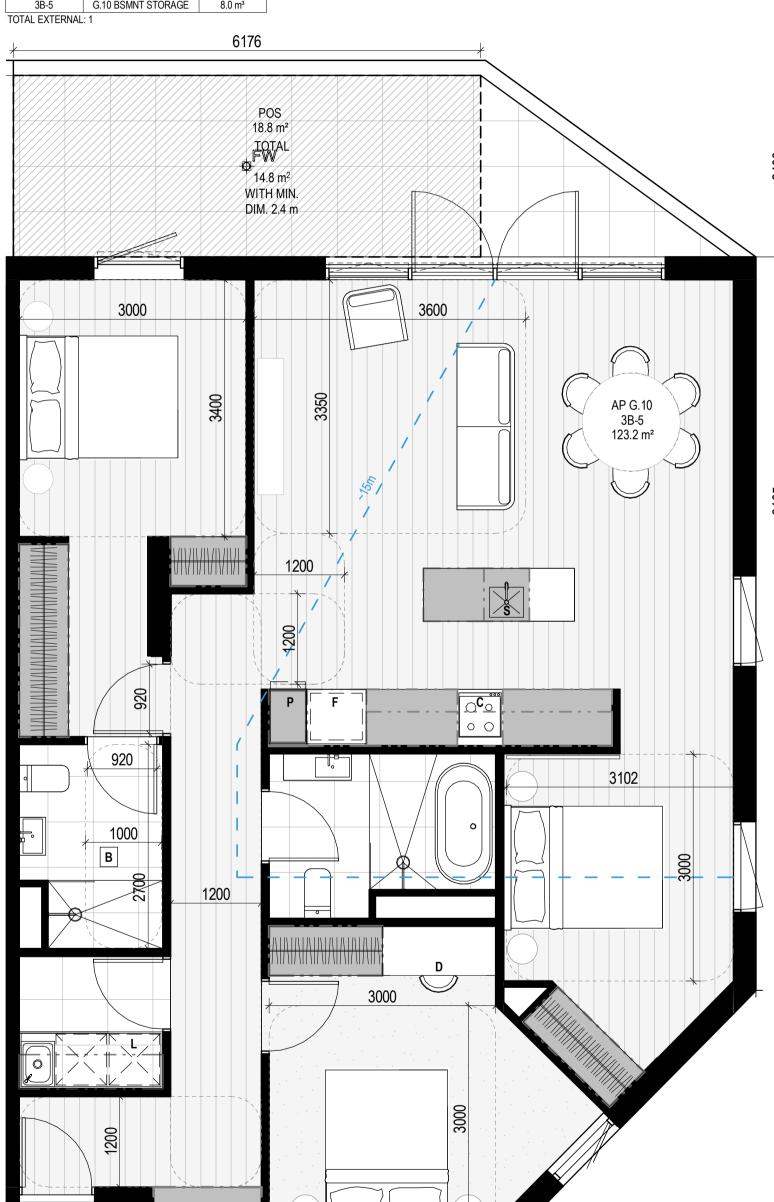

APT TYPE 3B-6

LEVEL	APT TYPE	NUMBER
PT LEVEL 1	3B-6	1.09


EXTERNAL STORAGE APT 3B-6

1.09 BSMNT STORAGE 8.0 m³

APT 3B-6 / 1.09 LAYOUT AND STORAGE ARE AS APT 3B-5 / G.10.

TOTAL EXTERNAL: 1

City of Port Phillip Advertised Plan Planning Application No. PDPL/00823/2022 No. of Pages: 31 of 50

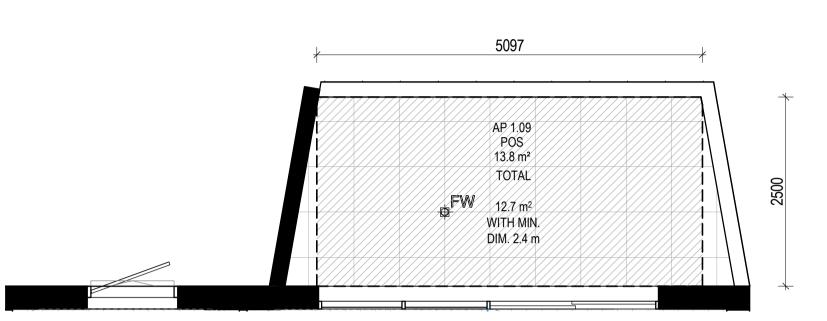

APT TYPE 3B-7


LEVEL	APT TYPE	NUMBER	
APT LEVEL 2	3B-7	2.07	
TOTAL · 1			

INTERNAL STORAGE APT 3B-7

	TYPE	LOCATION	VOLUME
	3B-7	BEDROOM	3.1 m³
	3B-7	BEDROOM	4.2 m³
	3B-7	BEDROOM	4.4 m³
	3B-7	BEDROOM	4.4 m³
	3B-7	KITCHEN	0.9 m³
	3B-7	KITCHEN	0.6 m³
	3B-7	KITCHEN	0.4 m³
	3B-7	KITCHEN	0.7 m³
	3B-7	KITCHEN	1.5 m³
	3B-7	KITCHEN	1.3 m³
	3B-7	KITCHEN	0.9 m³
	3B-7	KITCHEN	0.6 m³
	3B-7	KITCHEN	0.1 m³
	3B-7	LAUNDRY	0.7 m³
	3B-7	LAUNDRY	0.5 m³
TC	TAL INTERNAL	STORAGE	24.2 m ³

EXTERNAL STORAGE APT 3B-7

APT TYPE	LOCATION	VOLUME
3B-7	2.07 BSMNT STORAGE	8.0 m³
TOTAL EXTERNAL	:: 1	

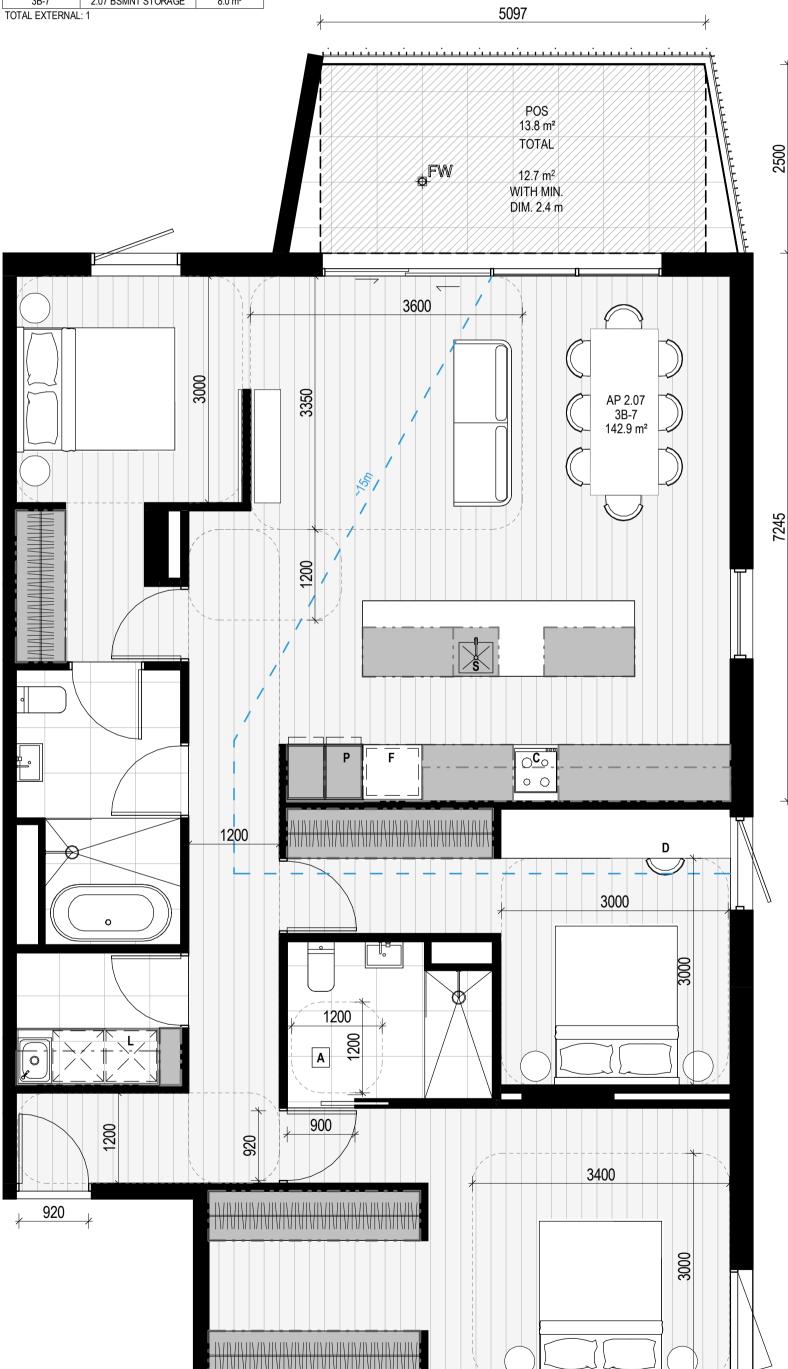

__APARTMENT NOTES

BATHROOM DESIGN OPTION UNDER APARTMENT DESIGN GUIDELINES FOR VICTORIA TABLE D4

L - LAUNDRY

P - PANTRY **F** - FRIDGE S - SINK

C - COOKTOP

D - DESK -13m - BREEZE PATH

SURVEY: EXISTING SITE INFORMATION IS TAKEN FROM VERIS SURVEY NUMBER 303981-BG DATED 06/07/2023 AND IS PROVIDED HERE FOR ILLUSTRATIVE PURPOSES ONLY. FOR FULL SURVEY DETAILS REFER TO SURVEY DOCUMENTS PROVIDED WITHIN

APPENDICIES. LANDSCAPE DESIGN: LANDSCAPE DESIGN IS SHOWN INDICATIVELY. FOR FULL LANDSCAPE DETAILS REFER TO LANDSCAPE ARCHITECT'S



DOCUMENTATION.

GENERAL NOTES

EXISTING TREE WITHIN PROJECT BOUNDARY TO BE RETAINED. TREE NUMBER, TPZ AND CANOPY AS PER ARBORIST REPORT

ABBREVIATIONS: AC CONDENSER UNIT
CL CLOTHES LINE
ELEC ELECTRICAL SERVICES

HYDR HYDRAULIC SERVICES COM COMMS SERVICES FCL FINISHED CEILING LEVEL FFL FINISHED FLOOR LEVEL FHR FIRE HOSE REEL FHY FIRE HYDRANT
FIP FIRE INDICATOR PANEL FW FLOOR WASTE NGL NATURAL GROUND LEVEL RELATIVE LEVEL TP WATER TAP
HW HOT WATER UNIT

__ MATERIALS

OW OPERABLE WINDOW

BR1 BRICK WORK - BAGGED TEXTURE FINISH BREEZE BLOCK PAINTED FIBRE CEMENT SHEET

HEAT PUMP HOT WATER UNIT

TL1 EXTERNAL TILE SC1 SUN SHADESCREEN MT1 VERTICAL ALUMINIUM BALUSTRADE MT2 GLAVANISED STEEL CLADDING

MT3 METAL PERGOLA GL1 GLAZING - DOUBLE CLEAR
GL2 OBSCURE GLAZING - REEDED MS1 CABLE MESH

MS2 MESH FENCING MS3 MESH SCREEN AS1 ACOUSTIC WALL PANEL SR1 SAFETY GUARD RAIL

ESD:

1. THE PROJECT ACHIEVES A TOTAL BESS SCORE OF 73% WITH NO MANDATORY CATEGORY (IEQ, ENERGY, WATER, STORMWATER) BELOW 50%.

2. 100% (41 OUT OF 41) OF THE DEVELOPMENT'S APARTMENTS AND 100% (21 OUT OF 21) OF THE DEVELOPMENT'S TOWNHOUSES ARE NATURALLY CROSS-VENTILATED.

3. DAYLIGHT MODELLING HAS BEEN CONDUCTED FOR A REPRESENTATIVE SAMPLE OF APARTMENTS. THE SUMMARY RESULT IS AS FOLLOWS:

• 88% OF LIVING FLOOR AREA ACHIEVES >90% ABOVE DF 1

• 92% OF BEDROOM FLOOR AREA ACHIEVES >90% ABOVE DF 0.5

4. THE NON-RESIDENTIAL AREAS ARE TARGETING A 2% DF TO 40% OF THE NOMINATED AREA.

5. 39% (16 OUT OF 41) OF APARTMENTS ACHIEVE AT LEAST 3 HOURS OF SUNLIGHT.

6. THE DEVELOPMENT IS PROVIDED WITH A COMPREHENSIVE SHADING STRATEGY. 6. THE DEVELOPMENT IS PROVIDED WITH A COMPREHENSIVE SHADING STRATEGY.
7. THE DEVELOPMENT IS TO ACHIEVE A 7.5 STAR AVERAGE NATHERS ENERGY
RATING RESULT FOR THE APARTMENTS AND A 7.0 STAR AVERAGE NATHERS ENERGY RATING RESULT FOR THE TOWNHOUSES.

8. THE NON-RESIDENTIAL AREAS AIM TO REDUCE HEATING AND COOLING ENERGY CONSUMPTION BELOW THE REFERENCE CASE (BCA SECTION J 2019).

CONSUMPTION BELOW THE REFERENCE CASE (BCA SECTION J 2019).

9. THE DEVELOPMENT IS TO UTILISE ELECTRIC HEAT PUMP HOT WATER SYSTEM.

10. A 9.6KW SOLAR PV SYSTEM IS TO BE LOCATED ON THE ROOF OF THE APARTMENT BUILDING.

11. A 2KW SOLAR PV SYSTEM IS TO BE PROVIDED FOR EACH TOWNHOUSE.

12. INDIVIDUAL COLD WATER AND ELECTRICITY METERS WILL BE PROVIDED TO THE APARTMENTS, TOWNHOUSES AND COMMUNAL AREAS.

13. WATER EFFICIENT FITTINGS AND FIXTURES ARE APPLIED THROUGHOUT.

14. A 32,000-LITRE RAINWATER TANK AND A 30,000-LITRE RAINWATER TANK WILL HARVEST RAINWATER FROM THE APARTMENT ROOF AND TOWNHOUSE ROOFS RESPECTIVELY. THESE TANKS WILL BE CONNECTED TO ALL TOILETS.

15. A MELBOURNE STORM RATING OF 102% IS ACHIEVED.

16. ALL LANDSCAPING IS TO BE NATIVE SPECIES OR LANDSCAPING IRRIGATION IS TO BE CONNECTED TO THE RAINWATER TANK ONLY.

17. IN TOTAL 62 BICYCLE SPACES ARE TO BE PROVIDED FOR RESIDENTS.

18. IN TOTAL 2 BICYCLE SPACES ARE TO BE PROVIDED FOR RESIDENTIAL AND NON-RESIDENTIAL VISITORS.

20. ONE CHARGING POINT FOR ELECTRICAL VEHICLES IS INTEGRATED IN THE PROPOSED DEVELOPMENT.

21. 141M2 OF COMMUNAL SPACE WILL BE PROVIDED AT THE ROOFTOP DECK.


22. 24M2 OF COMMUNAL SPACE WILL BE PROVIDED.

REFER TO ESD CONSULANTS DOCUMENTATION FOR FULL DETAILS

No. Date Description 18.11.2022 Issued for Town Planning 15.03.2023 Issued for RFI Response

2 27.07.2023 Amended TP Submission

TOWN PLANNING NOT FOR CONSTRUCTION

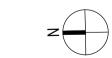

__KTA

Kerstin Thompson Architects Pty Ltd 277 Queensberry St, Melbourne Australia 3000 T +61 3 8662 8800 kta@kerstinthompson.com www.kerstinthompson.com

DRAWING TITLE APARTMENT PLAN - TYPE 3B-5, 3B-6 & 3B-7

97 Alma Road

AT St Kilda East Neometro 27.07.2023 JL/TM/LG

As indicated(A1) 2202



APT TYPE 3B-8 LEVEL APT TYPE NUMBER


APT GROUND LEVEL 3B-8 G.11
TOTAL: 1

INTERNAL STORAGE APT 3B-8

TYPE	LOCATION	VOLUME
3B-8	BEDROOM	2.0 m³
3B-8	BEDROOM	1.9 m³
3B-8	BEDROOM	1.2 m³
3B-8	BEDROOM	3.0 m³
3B-8	BEDROOM	2.7 m³
3B-8	KITCHEN	2.3 m³
3B-8	KITCHEN	0.4 m³
3B-8	KITCHEN	0.3 m³
3B-8	KITCHEN	0.7 m³
3B-8	KITCHEN	1.5 m³
3B-8	KITCHEN	0.3 m³
3B-8	KITCHEN	0.1 m³
3B-8	LAUNDRY	0.7 m ³
TOTAL INTERNAL	STORAGE	17.2 m³

EXTERNAL STORAGE APT 3B-8


APT TYPE	LOCATION	VOLUME		
3B-8	G.11 BSMNT STORAGE	7.4 m³		
TOTAL EXTERNAL·1				

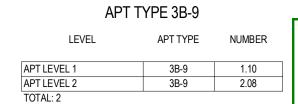


City of Port Phillip
Advertised Plan
Planning Application No. PDPL/00823/2022
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INTERNAL STORAGE APT 3B-9		
TYPE	LOCATION	VOLUME
3B-9	BEDROOM	2.9 m³
3B-9	BEDROOM	3.0 m³
3B-9	BEDROOM	3.4 m³
3B-9	BEDROOM	2.9 m³
3B-9	KITCHEN	2.1 m³
3B-9	KITCHEN	0.4 m³
3B-9	KITCHEN	0.3 m³
3B-9	KITCHEN	0.4 m³
3B-9	KITCHEN	1.3 m³
3B-9	KITCHEN	0.3 m³
3B-9	KITCHEN	0.1 m³
3B-9	LAUNDRY	0.7 m³
TOTAL INTERNAL	STORAGE	17.9 m³

EXTERNAL STORAGE APT 3B-9				
APT TYPE	LOCATION	VOLUME		
3B-9	1.10 BSMNT STORAGE	7.4 m³		
3B-9	2.08 BSMNT STORAGE	7.4 m³		



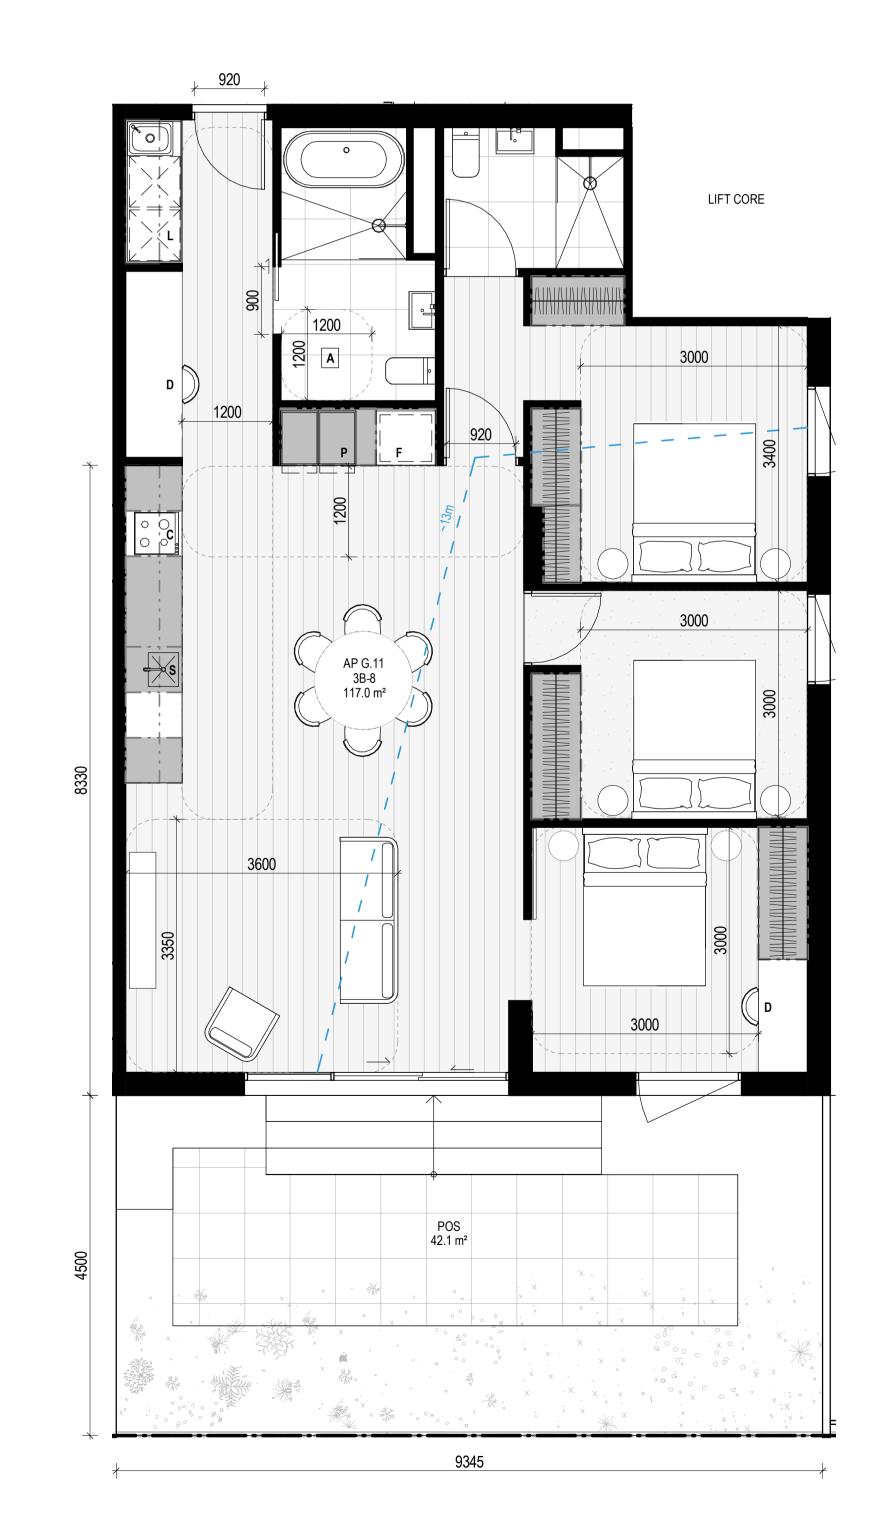

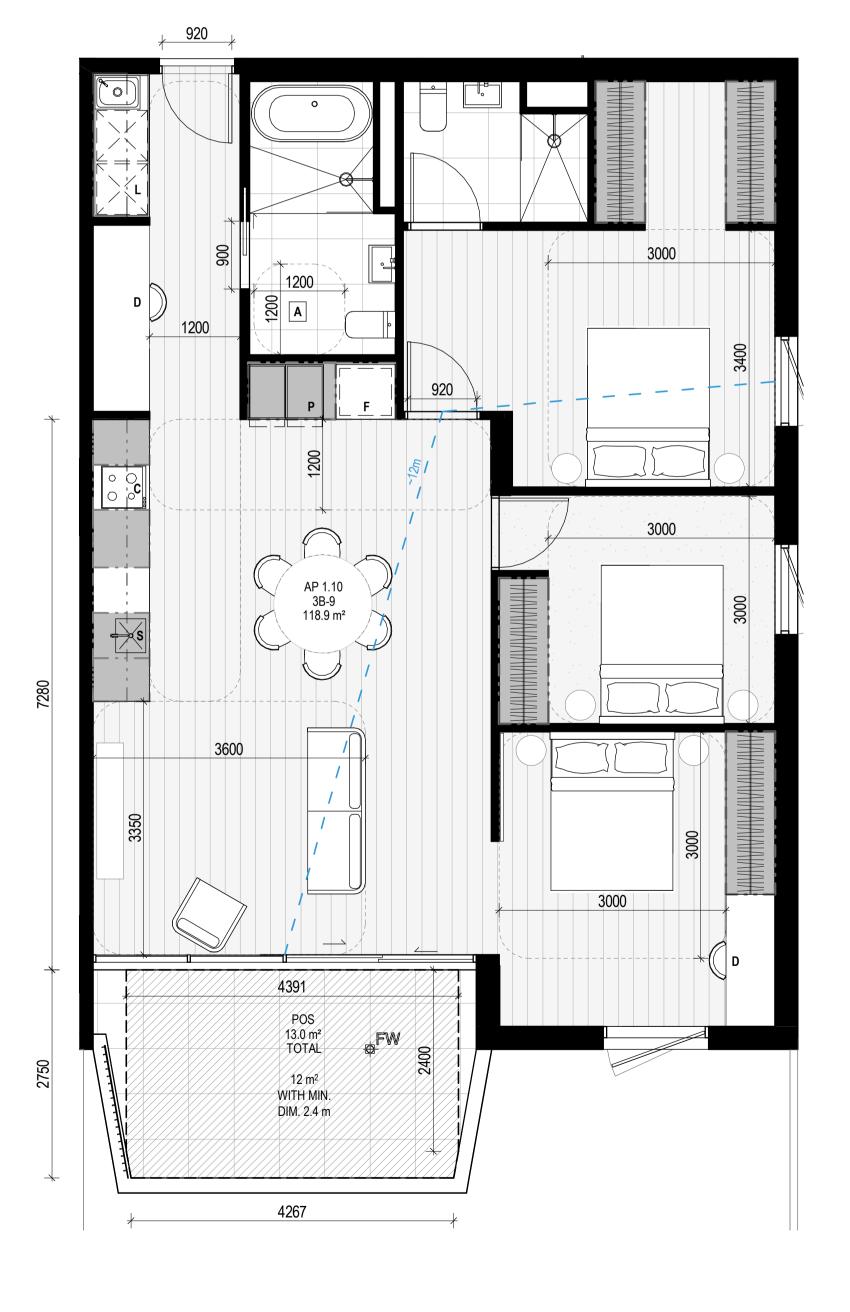__APARTMENT NOTES

A - BATHROOM DESIGN OPTION UNDER APARTMENT DESIGN GUIDELINES FOR VICTORIA TABLE D4

L - LAUNDRY


AUNDRY

P - PANTRY

F - FRIDGE

S - SINK

C - COOKTOP

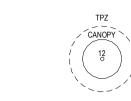

SURVEY:

APPENDICIES.

LANDSCAPE DESIGN:

DOCUMENTATION.

ABBREVIATIONS:

EXISTING TREE WITHIN PROJECT
BOUNDARY TO BE RETAINED.
TREE NUMBER, TPZ AND CANOPY
AS PER ARBORIST REPORT

AC CONDENSER UNIT
CL CLOTHES LINE
ELEC ELECTRICAL SERVICES
HYDR HYDRAULIC SERVICES
COM COMMS SERVICES
FCL FINISHED CEILING LEVEL
FFL FINISHED FLOOR LEVEL
FHR FIRE HOSE REEL
FHY FIRE HYDRANT
FIP FIRE INDICATOR PANEL
FW FLOOR WASTE
NGL NATURAL GROUND LEVEL
RL RELATIVE LEVEL
TP WATER TAP
HW HOT WATER UNIT

HP HEAT PUMP HOT WATER UNIT OW OPERABLE WINDOW

_GENERAL NOTES

EXISTING SITE INFORMATION IS TAKEN FROM VERIS SURVEY

LANDSCAPE DESIGN IS SHOWN INDICATIVELY. FOR FULL LANDSCAPE DETAILS REFER TO LANDSCAPE ARCHITECT'S

NUMBER 303981-BG DATED 06/07/2023 AND IS PROVIDED HERE FOR ILLUSTRATIVE PURPOSES ONLY. FOR FULL SURVEY DETAILS REFER TO SURVEY DOCUMENTS PROVIDED WITHIN

__ MATERIALS

BR1 BRICK WORK - BAGGED TEXTURE FINISH
BR2 BREEZE BLOCK
FC1 PAINTED FIBRE CEMENT SHEET

FC1 PAINTED FIBRE CEMENT SHI TL1 EXTERNAL TILE SC1 SUN SHADESCREEN

MT1 VERTICAL ALUMINIUM BALUSTRADE
MT2 GLAVANISED STEEL CLADDING
MT3 METAL PERGOLA
GL1 GLAZING - DOUBLE CLEAR
GL2 OBSCURE GLAZING - REEDED

MS1 CABLE MESH
MS2 MESH FENCING
MS3 MESH SCREEN
AS1 ACOUSTIC WALL PANEL

SR1 SAFETY GUARD RAIL

ESD:

1. THE PROJECT ACHIEVES A TOTAL BESS SCORE OF 73% WITH NO MANDATORY CATEGORY (IEQ, ENERGY, WATER, STORMWATER) BELOW 50%.

2. 100% (41 OUT OF 41) OF THE DEVELOPMENT'S APARTMENTS AND 100% (21 OUT OF 21) OF THE DEVELOPMENT'S TOWNHOUSES ARE NATURALLY CROSS-VENTILATED.

3. DAYLIGHT MODELLING HAS BEEN CONDUCTED FOR A REPRESENTATIVE SAMPLE OF APARTMENTS. THE SUMMARY RESULT IS AS FOLLOWS:

8.8% OF LIVING FLOOR AREA ACHIEVES >90% ABOVE DF 1

92% OF BEDROOM FLOOR AREA ACHIEVES >90% ABOVE DF 1

92% OF BEDROOM FLOOR AREA ACHIEVES >90% ABOVE DF 0.5

4. THE NON-RESIDENTIAL AREAS ARE TARGETING A 2% DF TO 40% OF THE NOMINATED AREA.

5. 39% (16 OUT OF 41) OF APARTMENTS ACHIEVE AT LEAST 3 HOURS OF SUNLIGHT.

6. THE DEVELOPMENT IS PROVIDED WITH A COMPREHENSIVE SHADING STRATEGY.

7. THE DEVELOPMENT IS TO ACHIEVE AT 7.5 STAR AVERAGE NATHERS ENERGY RATING RESULT FOR THE TOWNHOUSES.

8. THE NON-RESIDENTIAL AREAS AIM TO REDUCE HEATING AND COOLING ENERGY CONSUMPTION BELOW THE REFERENCE CASE (BCA SECTION J 2019).

9. THE DEVELOPMENT IS TO O'THISE ELECTRIC HEAT PUMP HOT WATER SYSTEM.

10. A 9 SKW SOLAR PV SYSTEM IS TO BE LOCATED ON THE ROOF OF THE APARTMENT BUILDING.

11. A ZKW SOLAR PV SYSTEM IS TO BE PROVIDED FOR EACH TOWNHOUSE.

12. INDIVIDUAL COLD WATER AND ELECTRICITY METERS WILL BE PROVIDED TO THE APARTMENTS, TOWNHOUSES.

AND COMMUNAL AREAS.

CONSUMPTION BELOW THE REFERENCE CASE (BCA SECTION J 2019).

9. THE DEVELOPMENT IS TO UTILISE ELECTRIC HEAT PUMP HOT WATER SYSTEM.

10. A 9.6KW SOLAR PV SYSTEM IS TO BE LOCATED ON THE ROOF OF THE APARTMENT BUILDING.

11. A 2KW SOLAR PV SYSTEM IS TO BE PROVIDED FOR EACH TOWNHOUSE.

12. INDIVIDUAL COLD WATER AND ELECTRICITY METERS WILL BE PROVIDED TO THE APARTMENTS, TOWNHOUSES

AND COMMUNAL AREAS.

13. WATER EFFICIENT FITTINGS AND FIXTURES ARE APPLIED THROUGHOUT.

14. A 32.000-LITRE RAINWATER TANK AND A 30,000-LITRE RAINWATER TANK WILL HARVEST RAINWATER FROM THE
APARTMENT ROOF AND TOWNHOUSE ROOFS RESPECTIVELY. THESE TANKS WILL BE CONNECTED TO ALL TOILETS.

15. A MELBOURNE STORM RATING OF 102% IS ACHIEVED.

16. ALL LANDSCAPING IS TO BE NATIVE SPECIES OR LANDSCAPING IRRIGATION IS TO BE CONNECTED TO THE RAINWATER TANK ONLY.

17. IN TOTAL 62 BICYCLE SPACES ARE TO BE PROVIDED FOR RESIDENTS.

18. IN TOTAL 12 BICYCLE SPACES ARE TO BE PROVIDED FOR RESIDENTIAL AND NON-RESIDENTIAL VISITORS.

20. ONE CHARGING POINT FOR ELECTRICAL VEHICLES IS INTEGRATED IN THE PROPOSED DEVELOPMENT.

21. 141M 20 F COMMUNAL FOAD PRODUCTION AREA WILL BE PROVIDED.

REFER TO ESD CONSULANTS DOCUMENTATION FOR FULL DETAILS


 No.
 Date
 Description

 0
 18.11.2022
 Issued for Town Planning

 1
 15.03.2023
 Issued for RFI Response

 2
 27.07.2023
 Amended TP Submission

TOWN PLANNING NOT FOR CONSTRUCTION

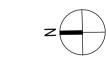

__KTA

Kerstin Thompson Architects Pty Ltd 277 Queensberry St, Melbourne Australia 3000 **T +61 3 8662 8800** kta@kerstinthompson.com www.kerstinthompson.com

DRAWING TITLE
APARTMENT PLAN - TYPE 3B-8 & 3B-9

PROJECT

97 Alma Road

AT St Kilda

AT St Kilda East
FOR Neometro

DATE DRAWN BY 27.07.2023 JL/TM/LG

27.07.2023 JL/TM/LG
SCALE PROJECT
As indicated(A1) 2202 TP632




APT TYPE 3B-10			
LEVEL	APT TYPE	NUMBER	
APT LEVEL 1	3B-10	1.02	
TOTAL: 1			

TYPE	LOCATION	VOLUME	
3B-10	BEDROOM	6.1 m³	
3B-10	BEDROOM	6.0 m³	
3B-10	BEDROOM	3.3 m³	
3B-10	KITCHEN	0.4 m³	
3B-10	KITCHEN	1.6 m³	
3B-10	KITCHEN	0.8 m³	
3B-10	KITCHEN	0.7 m³	
3B-10	KITCHEN	0.5 m³	
3B-10	KITCHEN	1.8 m³	
3B-10	KITCHEN	0.4 m³	
3B-10	KITCHEN	0.1 m³	
3B-10	LAUNDRY	0.6 m³	
3B-10	LAUNDRY	0.1 m³	
3B-10	LAUNDRY	0.3 m ³	
TOTAL INTERNAL	STORAGE	22.8 m³	

EXTERNAL STORAGE APT 3B-10 LOCATION


3B-10 1.02 BSMNT STORAGE 7.4 m³ TOTAL EXTERNAL: 1

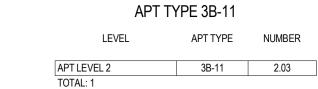

EXTERNAL STORAGE APT 3B-11		
APT TYPE	LOCATION	VOLUME

APT 3B-11 / 2.03 LAYOUT AND STORAGE ARE AS	
APT 3B-10 / 1.02.	

3B-11 2.03 BSMNT STORAGE 7.4 m³

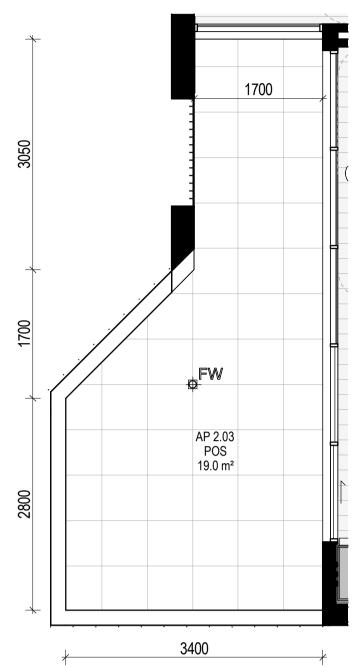

			* 3400
		SERVICES RISERS 920 920 1000 1200	VOID OW 3000
3350	1700 	3600	L
4200	POS 12.8 m² TOTAL 12 m² WITH MIN. DIM. 1.7 m	AP 1.02 3B-10 137.8 m ²	3000
+	1800	P F 0 0 0 0 0 0 0 0 0 0 0 0 0 0 0 0 0 0	

APT TYPE 3B-12

LEVEL	APT TYPE	NUMBER
T LEVEL 3	3B-12	3.02
ΤΔΙ · 1		

INTERNAL STORAGE APT 3B-12		
TYPE	LOCATION	VOLUME
3B-12	BEDROOM	5.2 m ³
3B-12	BEDROOM	6.0 m ³
3B-12	BEDROOM	3.3 m³
3B-12	KITCHEN	1.8 m³
3B-12	KITCHEN	0.4 m ³
3B-12	KITCHEN	1.6 m³
3B-12	KITCHEN	0.8 m ³
3B-12	KITCHEN	0.7 m ³
3B-12	KITCHEN	0.5 m ³
3B-12	KITCHEN	0.4 m ³
3B-12	KITCHEN	0.1 m ³
3B-12	LAUNDRY	0.6 m ³
3R-12	LALINDRY	0.1 m ³

EXTERNAL STORAGE APT 3B-12

APT TYPE	LOCATION	VOLUME	
3B-12	3.02 BSMNT STORAGE	7.4 m³	
TOTAL EXTERNAL: 1			

LAUNDRY

City of Port Phillip Advertised Plan Planning Application No. PDPL/00823/2022 No. of Pages: 33 of 50

__APARTMENT NOTES

BATHROOM DESIGN OPTION UNDER APARTMENT DESIGN GUIDELINES FOR VICTORIA TABLE D4

L - LAUNDRY

P - PANTRY F - FRIDGE

S - SINK

C - COOKTOP D - DESK

-13m - BREEZE PATH

_GENERAL NOTES

DOCUMENTATION.

ABBREVIATIONS:

SURVEY: EXISTING SITE INFORMATION IS TAKEN FROM VERIS SURVEY NUMBER 303981-BG DATED 06/07/2023 AND IS PROVIDED HERE FOR ILLUSTRATIVE PURPOSES ONLY. FOR FULL SURVEY DETAILS REFER TO SURVEY DOCUMENTS PROVIDED WITHIN

APPENDICIES. LANDSCAPE DESIGN: LANDSCAPE DESIGN IS SHOWN INDICATIVELY. FOR FULL LANDSCAPE DETAILS REFER TO LANDSCAPE ARCHITECT'S



EXISTING TREE WITHIN PROJECT BOUNDARY TO BE RETAINED. TREE NUMBER, TPZ AND CANOPY AS PER ARBORIST REPORT

AC CONDENSER UNIT
CL CLOTHES LINE
ELEC ELECTRICAL SERVICES HYDR HYDRAULIC SERVICES COM COMMS SERVICES FCL FINISHED CEILING LEVEL FFL FINISHED FLOOR LEVEL FHR FIRE HOSE REEL FHY FIRE HYDRANT
FIP FIRE INDICATOR PANEL FW FLOOR WASTE NGL NATURAL GROUND LEVEL RL RELATIVE LEVEL
TP WATER TAP
HW HOT WATER UNIT

HP HEAT PUMP HOT WATER UNIT OW OPERABLE WINDOW

__ MATERIALS

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MT1 VERTICAL ALUMINIUM BALUSTRADE
MT2 GLAVANISED STEEL CLADDING MT3 METAL PERGOLA

GL1 GLAZING - DOUBLE CLEAR
GL2 OBSCURE GLAZING - REEDED MS1 CABLE MESH MS2 MESH FENCING MS3 MESH SCREEN AS1 ACOUSTIC WALL PANEL

SR1 SAFETY GUARD RAIL

ESD:

1. THE PROJECT ACHIEVES A TOTAL BESS SCORE OF 73% WITH NO MANDATORY CATEGORY (IEQ, ENERGY, WATER, STORMWATER) BELOW 50%.

2. 100% (41 OUT OF 41) OF THE DEVELOPMENT'S APARTIMENTS AND 100% (21 OUT OF 21) OF THE DEVELOPMENT'S TOWNHOUSES ARE NATURALLY CROSS-VENTILATED.

3. DAYLIGHT MODELLING HAS BEEN CONDUCTED FOR A REPRESENTATIVE SAMPLE OF APARTIMENTS. THE SUMMARY RESULT IS AS FOLLOWS:

• 88% OF LIVING FLOOR AREA ACHIEVES >90% ABOVE DF 1

• 92% OF BEDROOM FLOOR AREA ACHIEVES >90% ABOVE DF 0.5

4. THE NON-RESIDENTIAL AREAS ARE TARGETING A 2% DF TO 40% OF THE NOMINATED AREA.

5. 35% (16 OUT OF 41) OF APARTMENTS ACHIEVE AT LEAST 3 HOURS OF SUNLIGHT.

6. THE DEVELOPMENT IS PROVIDED WITH A COMPREHENSIVE SHADING STRATEGY.

7. THE DEVELOPMENT IS TO ACHIEVE A 7.5 STAR AVERAGE NATHERS ENERGY RATING RESULT FOR THE TOWNHOUSES.

ENERGY RATING RESULT FOR THE TOWNHOUSES.

8. THE NON-RESIDENTIAL AREAS AIM TO REDUCE HEATING AND COOLING ENERGY CONSUMPTION BELOW THE REFERENCE CASE (BCA SECTION J 2019).

CONSUMPTION BELOW THE REFERENCE CASE (BCA SECTION J 2019).

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13. WATER EFFICIENT FITTINGS AND FIXTURES ARE APPLIED THROUGHOUT.

14. A 32,000-LITRE RAINWATER TANK AND A 30,000-LITRE RAINWATER TANK WILL HARVEST RAINWATER FROM THE APARTMENT ROOF AND TOWNHOUSE ROOFS RESPECTIVELY. THESE TANKS WILL BE CONNECTED TO ALL TOILETS.

15. A MELBOURNE STORM RATING OF 102% IS ACHIEVED.

16. ALL LANDSCAPING IS TO BE NATIVE SPECIES OR LANDSCAPING IRRIGATION IS TO BE CONNECTED TO THE RAINWATER TANK ONLY.

17. IN TOTAL 62 BICYCLE SPACES ARE TO BE PROVIDED FOR RESIDENTS.

18. IN TOTAL 2 BICYCLE SPACES ARE TO BE PROVIDED FOR RESIDENTIAL AND NON-RESIDENTIAL VISITORS.

20. ONE CHARGING POINT FOR ELECTRICAL VEHICLES IS INTEGRATED IN THE PROPOSED DEVELOPMENT.

21. 141M2 OF COMMUNAL SPACE WILL BE PROVIDED AT THE ROOFTOP DECK.


22. 24M2 OF COMMUNAL SPACE WILL BE PROVIDED.

REFER TO ESD CONSULANTS DOCUMENTATION FOR FULL DETAILS

No. Date Description 18.11.2022 Issued for Town Planning 15.03.2023 Issued for RFI Response

2 27.07.2023 Amended TP Submission

TOWN PLANNING NOT FOR CONSTRUCTION

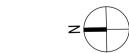

__KTA


Kerstin Thompson Architects Pty Ltd 277 Queensberry St, Melbourne Australia 3000 T +61 3 8662 8800
kta@kerstinthompson.com
www.kerstinthompson.com

DRAWING TITLE APARTMENT PLAN - TYPE 3B-10, 3B-11 & 3B-12

97 Alma Road

AT St Kilda East Neometro

DATE DRAWN BY DRAWING NO. 27.07.2023 JL/TM/LG SCALE PROJECT TP63 As indicated(A1) 2202

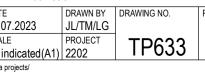



APT LEVEL 3 3B-13 3.01

INTERNAL STORAGE APT 3B-13

LOCATION

VOLUME


3B-13	BEDROOM	3.2 m³
3B-13	BEDROOM	3.0 m³
3B-13	BEDROOM	5.1 m³
3B-13	BEDROOM	2.3 m³
3B-13	HALLWAY	1.0 m³
3B-13	KITCHEN	0.3 m ³
3B-13	KITCHEN	0.4 m³
3B-13	KITCHEN	0.9 m³
3B-13	KITCHEN	0.8 m ³
3B-13	KITCHEN	0.3 m³
3B-13	KITCHEN	0.7 m ³
3B-13	KITCHEN	0.1 m³
3B-13	KITCHEN	0.3 m ³
3B-13	LAUNDRY	0.7 m ³
TOTAL INTERNAL STORAGE		19.2 m³

EXTERNAL STORAGE APT 3B-13

APT TYPE	LOCATION	VOL

3B-13 3.01 BSMNT STORAGE 7.4 m³ TOTAL EXTERNAL: 1



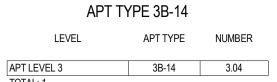


INTERNAL STORAGE APT 3B-14

TYPE	LOCATION	VOLUME
3B-14	BEDROOM	4.7 m³
3B-14	BEDROOM	3.7 m³
3B-14	BEDROOM	1.5 m³
3B-14	BEDROOM	3.3 m³
3B-14	BEDROOM	3.7 m³
3B-14	KITCHEN	1.8 m³
3B-14	KITCHEN	0.4 m³
3B-14	KITCHEN	0.3 m³
3B-14	KITCHEN	1.3 m³
3B-14	KITCHEN	1.3 m³
3B-14	KITCHEN	0.7 m³
3B-14	KITCHEN	0.0 m³
3B-14	LAUNDRY	0.7 m³
TOTAL INTERNAL	23.5 m³	

EXTERNAL STORAGE APT 3B-14 LOCATION

3B-14 3.04 BSMNT STORAGE 7.4 m³

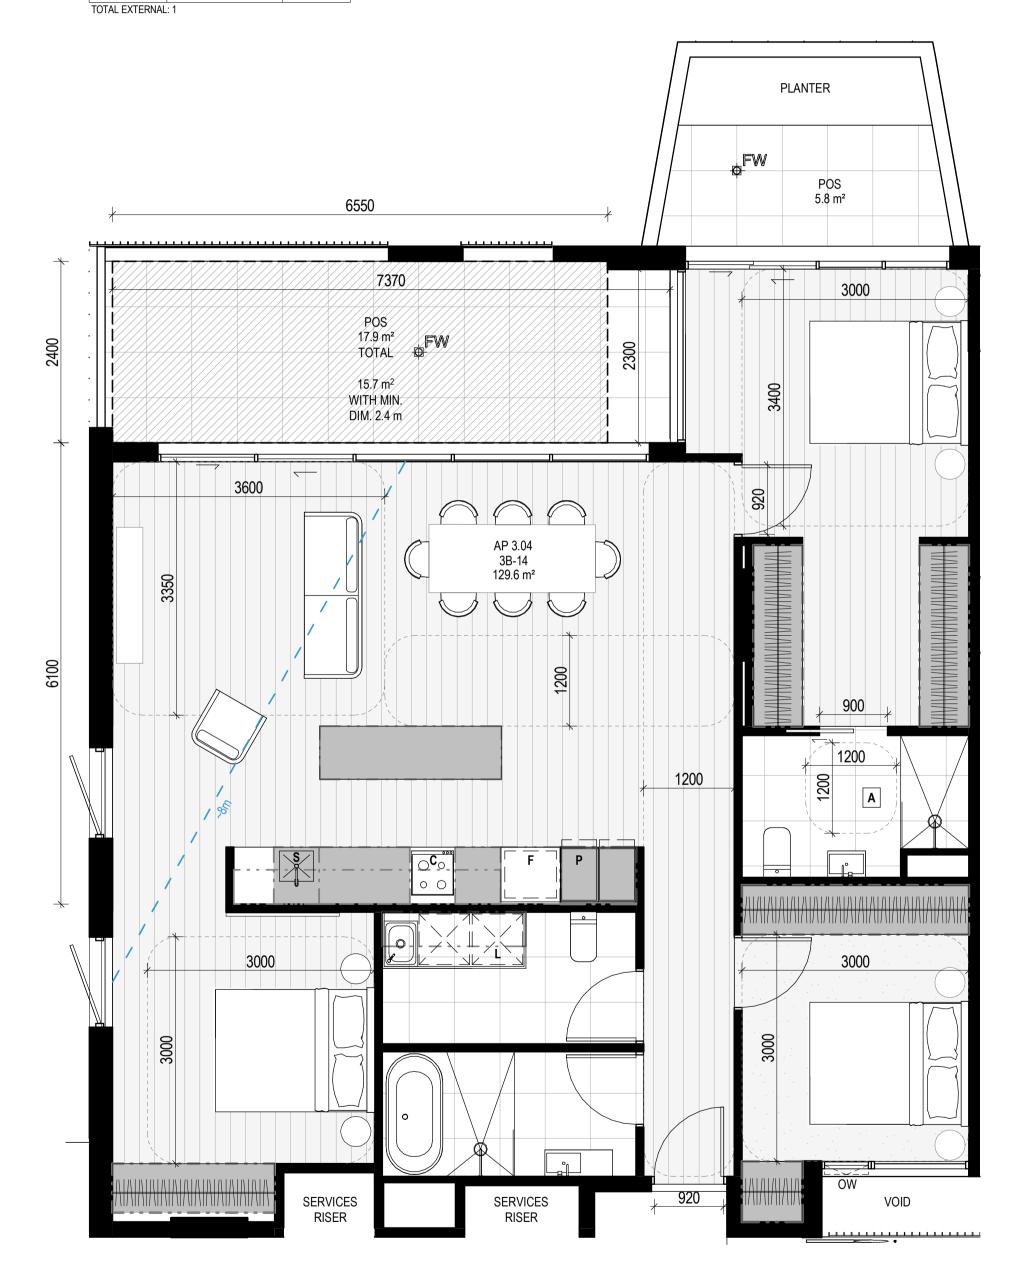

City of Port Phillip

Advertised Plan

Planning Application No. PDPL/00823/2022 No. of Pages: 34 of 50

__APARTMENT NOTES

BATHROOM DESIGN OPTION UNDER APARTMENT DESIGN GUIDELINES FOR VICTORIA TABLE D4

L - LAUNDRY

P - PANTRY

F - FRIDGE S - SINK

C - COOKTOP D - DESK

-13m - BREEZE PATH

GENERAL NOTES

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LANDSCAPE DESIGN: LANDSCAPE DESIGN IS SHOWN INDICATIVELY. FOR FULL LANDSCAPE DETAILS REFER TO LANDSCAPE ARCHITECT'S



DOCUMENTATION.

EXISTING TREE WITHIN PROJECT BOUNDARY TO BE RETAINED. TREE NUMBER, TPZ AND CANOPY AS PER ARBORIST REPORT

ABBREVIATIONS: AC CONDENSER UNIT
CL CLOTHES LINE
ELEC ELECTRICAL SERVICES HYDR HYDRAULIC SERVICES COM COMMS SERVICES FCL FINISHED CEILING LEVEL FFL FINISHED FLOOR LEVEL

FHR FIRE HOSE REEL FHY FIRE HYDRANT
FIP FIRE INDICATOR PANEL FW FLOOR WASTE NGL NATURAL GROUND LEVEL RELATIVE LEVEL WATER TAP HW HOT WATER UNIT HEAT PUMP HOT WATER UNIT OW OPERABLE WINDOW

__ MATERIALS

BR1 BRICK WORK - BAGGED TEXTURE FINISH BREEZE BLOCK

FC1 PAINTED FIBRE CEMENT SHEET TL1 EXTERNAL TILE SC1 SUN SHADESCREEN

MT1 VERTICAL ALUMINIUM BALUSTRADE MT2 GLAVANISED STEEL CLADDING MT3 METAL PERGOLA GL1 GLAZING - DOUBLE CLEAR
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MS1 CABLE MESH MS2 MESH FENCING MS3 MESH SCREEN AS1 ACOUSTIC WALL PANEL

SR1 SAFETY GUARD RAIL

ESD:

1. THE PROJECT ACHIEVES A TOTAL BESS SCORE OF 73% WITH NO MANDATORY 1. THE PROJECT ACHIEVES A TOTAL BESS SCORE OF 73% WITH NO MANDATORY CATEGORY (IEQ, ENERGY, WATER, STORMWATER) BELOW 50%.
2. 100% (41 OUT OF 41) OF THE DEVELOPMENT'S APARTMENTS AND 100% (21 OUT OF 21) OF THE DEVELOPMENT'S TOWNHOUSES ARE NATURALLY CROSS-VENTILATED.
3. DAYLIGHT MODELLING HAS BEEN CONDUCTED FOR A REPRESENTATIVE SAMPLE OF APARTMENTS. THE SUMMARY RESULT IS AS FOLLOWS:

1. 88% OF LIVING FLOOR AREA ACHIEVES -90% ABOVE DF 1

2. 92% OF BEDROOM FLOOR AREA ACHIEVES -90% ABOVE DF 0.5

4. THE NON-RESIDENTIAL AREAS ARE TARGETING A 2% DF TO 40% OF THE NOMINATED AREA.
5. 39% (16 OUT OF 41) OF APARTMENTS ACHIEVE AT LEAST 3 HOURS OF SUNLIGHT.
6. THE DEVELOPMENT IS PROVIDED WITH A COMPREHENSIVE SHADING STRATEGY. 6. THE DEVELOPMENT IS PROVIDED WITH A COMPREHENSIVE SHADING STRATEGY.
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ENERGY RATING RESULT FOR THE TOWNHOUSES.

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10. A 9.6KW SOLAR PV SYSTEM IS TO BE LOCATED ON THE ROOF OF THE
APARTMENT BUILDING.

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APART MENT BUILDING.

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No. Date Description 18.11.2022 Issued for Town Planning 15.03.2023 Issued for RFI Response 2 27.07.2023 Amended TP Submission

> **TOWN PLANNING** NOT FOR CONSTRUCTION



__KTA

Kerstin Thompson Architects Pty Ltd 277 Queensberry St, Melbourne Australia 3000 T +61 3 8662 8800 kta@kerstinthompson.com www.kerstinthompson.com

DRAWING TITLE APARTMENT PLAN - TYPE 3B-13 & 3B-14

97 Alma Road

AT St Kilda East Neometro


27.07.2023 JL/TM/LG PROJECT As indicated(A1) 2202





City of Port Phillip Advertised Plan Planning Application No. PDPL/00823/2022 No. of Pages: 35 of 50



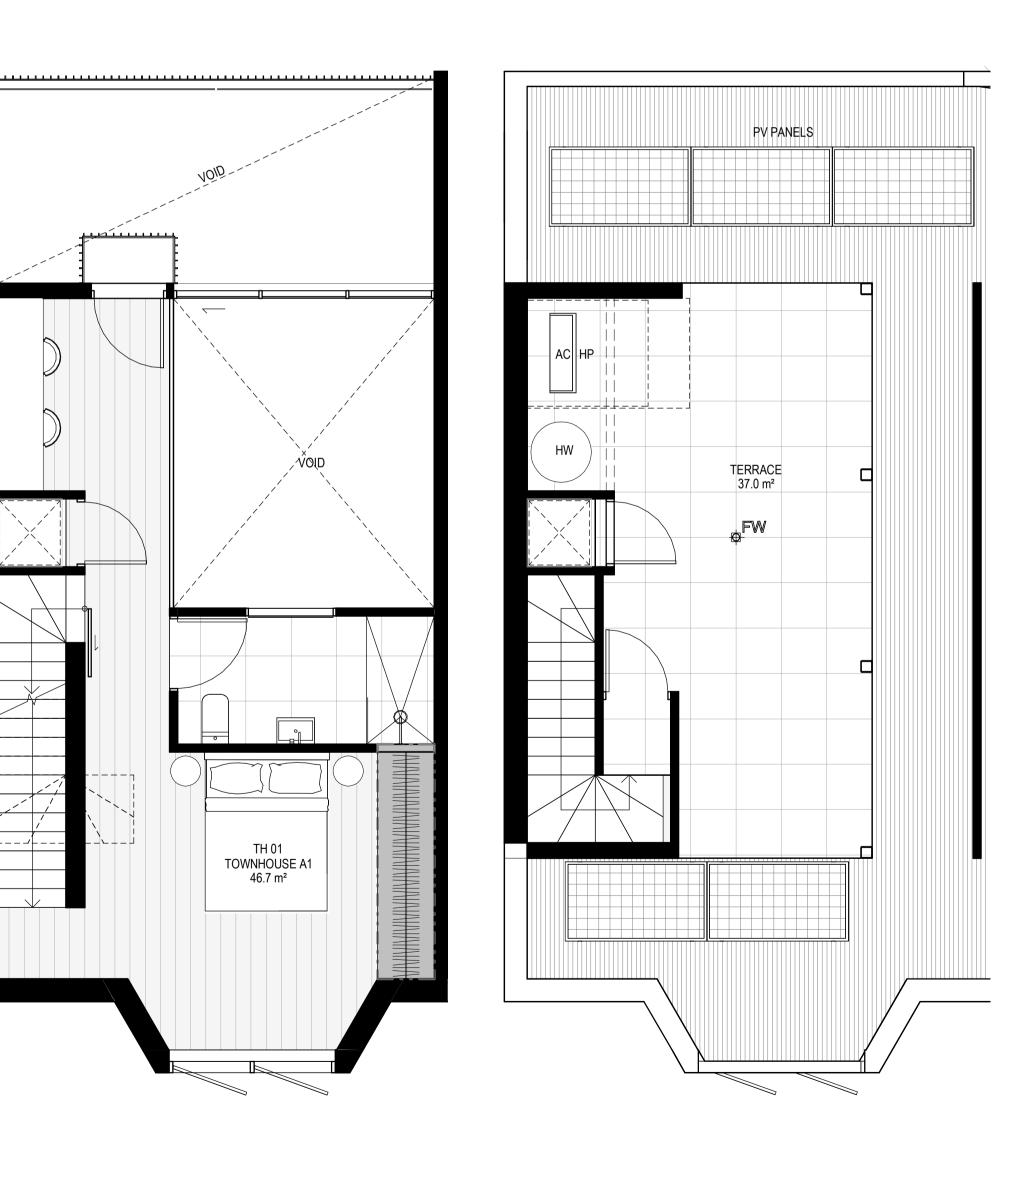

LEVEL 2 LEVEL GROUND LEVEL 1 LEVEL ROOF

TH 01 **TOWNHOUSE A1**

62.3 m²

5775

POS

15.4 m²

28.1 m²

TOWNHOUSE A1


65.6 m²

5775

_GENERAL NOTES

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DOCUMENTATION.

EXISTING TREE WITHIN PROJECT BOUNDARY TO BE RETAINED. TREE NUMBER, TPZ AND CANOPY AS PER ARBORIST REPORT

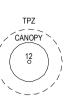ABBREVIATIONS: AC CONDENSER UNIT
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ELEC ELECTRICAL SERVICES HYDR HYDRAULIC SERVICES COM COMMS SERVICES

FCL FINISHED CEILING LEVEL
FFL FINISHED FLOOR LEVEL
FHR FIRE HOSE REEL FHY FIRE HYDRANT
FIP FIRE INDICATOR PANEL FW FLOOR WASTE
NGL NATURAL GROUND LEVEL

INTERNAL STORAGE TH-01

TH 01 TH 01 TH 01 TH 01 TH 01 TH 01

TOTAL INTERNAL STORAGE

LOCATION

BEDROOM

BEDROOM BEDROOM

KITCHEN KITCHEN KITCHEN **VOLUME**

5.7 m³

5.7 m³ 5.6 m³

1.1 m³ 1.5 m³ 0.8 m³

EXTERNAL STORAGE TH 01

RL RELATIVE LEVEL
TP WATER TAP
HW HOT WATER UNIT HEAT PUMP HOT WATER UNIT OW OPERABLE WINDOW

__ MATERIALS

BR1 BRICK WORK - BAGGED TEXTURE FINISH BREEZE BLOCK PAINTED FIBRE CEMENT SHEET

TL1 EXTERNAL TILE SC1 SUN SHADESCREEN MT1 VERTICAL ALUMINIUM BALUSTRADE
MT2 GLAVANISED STEEL CLADDING

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MS1 CABLE MESH MS2 MESH FENCING MS3 MESH SCREEN AS1 ACOUSTIC WALL PANEL SR1 SAFETY GUARD RAIL

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5. 39% (16 OUT OF 41) OF APARTMENTS ACHIEVE AT LEAST 3 HOURS OF SUNLIGHT.

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7. THE DEVELOPMENT IS TO ACHIEVE A 7.5 STAR AVERAGE NATHERS ENERGY RATING RESULT FOR THE APARTMENTS AND A 7.0 STAR AVERAGE NATHERS ENERGY ENERGY RATING RESULT FOR THE APARTMENTS AND A 7.0 STAR AVERAGE NATHERS

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CONSUMPTION BELOW THE REFERENCE CASE (BCA SECTION J 2019).

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10. A 9.6KW SOLAR PV SYSTEM IS TO BE LOCATED ON THE ROOF OF THE APARTMENT BUILDING.

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12. INDIVIDUAL COLD WATER AND ELECTRICITY METERS WILL BE PROVIDED TO THE APARTMENTS, TOWNHOUSES

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13. WATER EFFICIENT FITTINGS AND FIXTURES ARE APPLIED THROUGHOUT.

14. A 32.000-LITRE RAINWATER TANK AND A 30,000-LITRE RAINWATER TANK WILL HARVEST RAINWATER FROM THE
APARTMENT ROOF AND TOWNHOUSE ROOFS RESPECTIVELY. THESE TANKS WILL BE CONNECTED TO ALL TOILETS.

15. A MELBOURNE STORM RATING OF 102% IS ACHIEVED.

16. ALL LANDSCAPING IS TO BE NATIVE SPECIES OR LANDSCAPING IRRIGATION IS TO BE CONNECTED TO THE RAINWATER TANK ONLY.

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18. IN TOTAL 12 BICYCLE SPACES ARE TO BE PROVIDED FOR RESIDENTIAL AND NON-RESIDENTIAL VISITORS.

20. ONE CHARGING POINT FOR ELECTRICAL VEHICLES IS INTEGRATED IN THE PROPOSED DEVELOPMENT.


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No. Date Description 18.11.2022 Issued for Town Planning 15.03.2023 Issued for RFI Response

2 27.07.2023 Amended TP Submission

TOWN PLANNING NOT FOR CONSTRUCTION





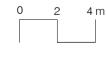

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DRAWING TITLE TOWNHOUSE PLANS - TYPE A1

97 Alma Road


AT St Kilda East Neometro

27.07.2023 JL/TM/LG As indicated(A1) 2202






City of Port Phillip Advertised Plan Planning Application No. PDPL/00823/2022 No. of Pages: 36 of 50

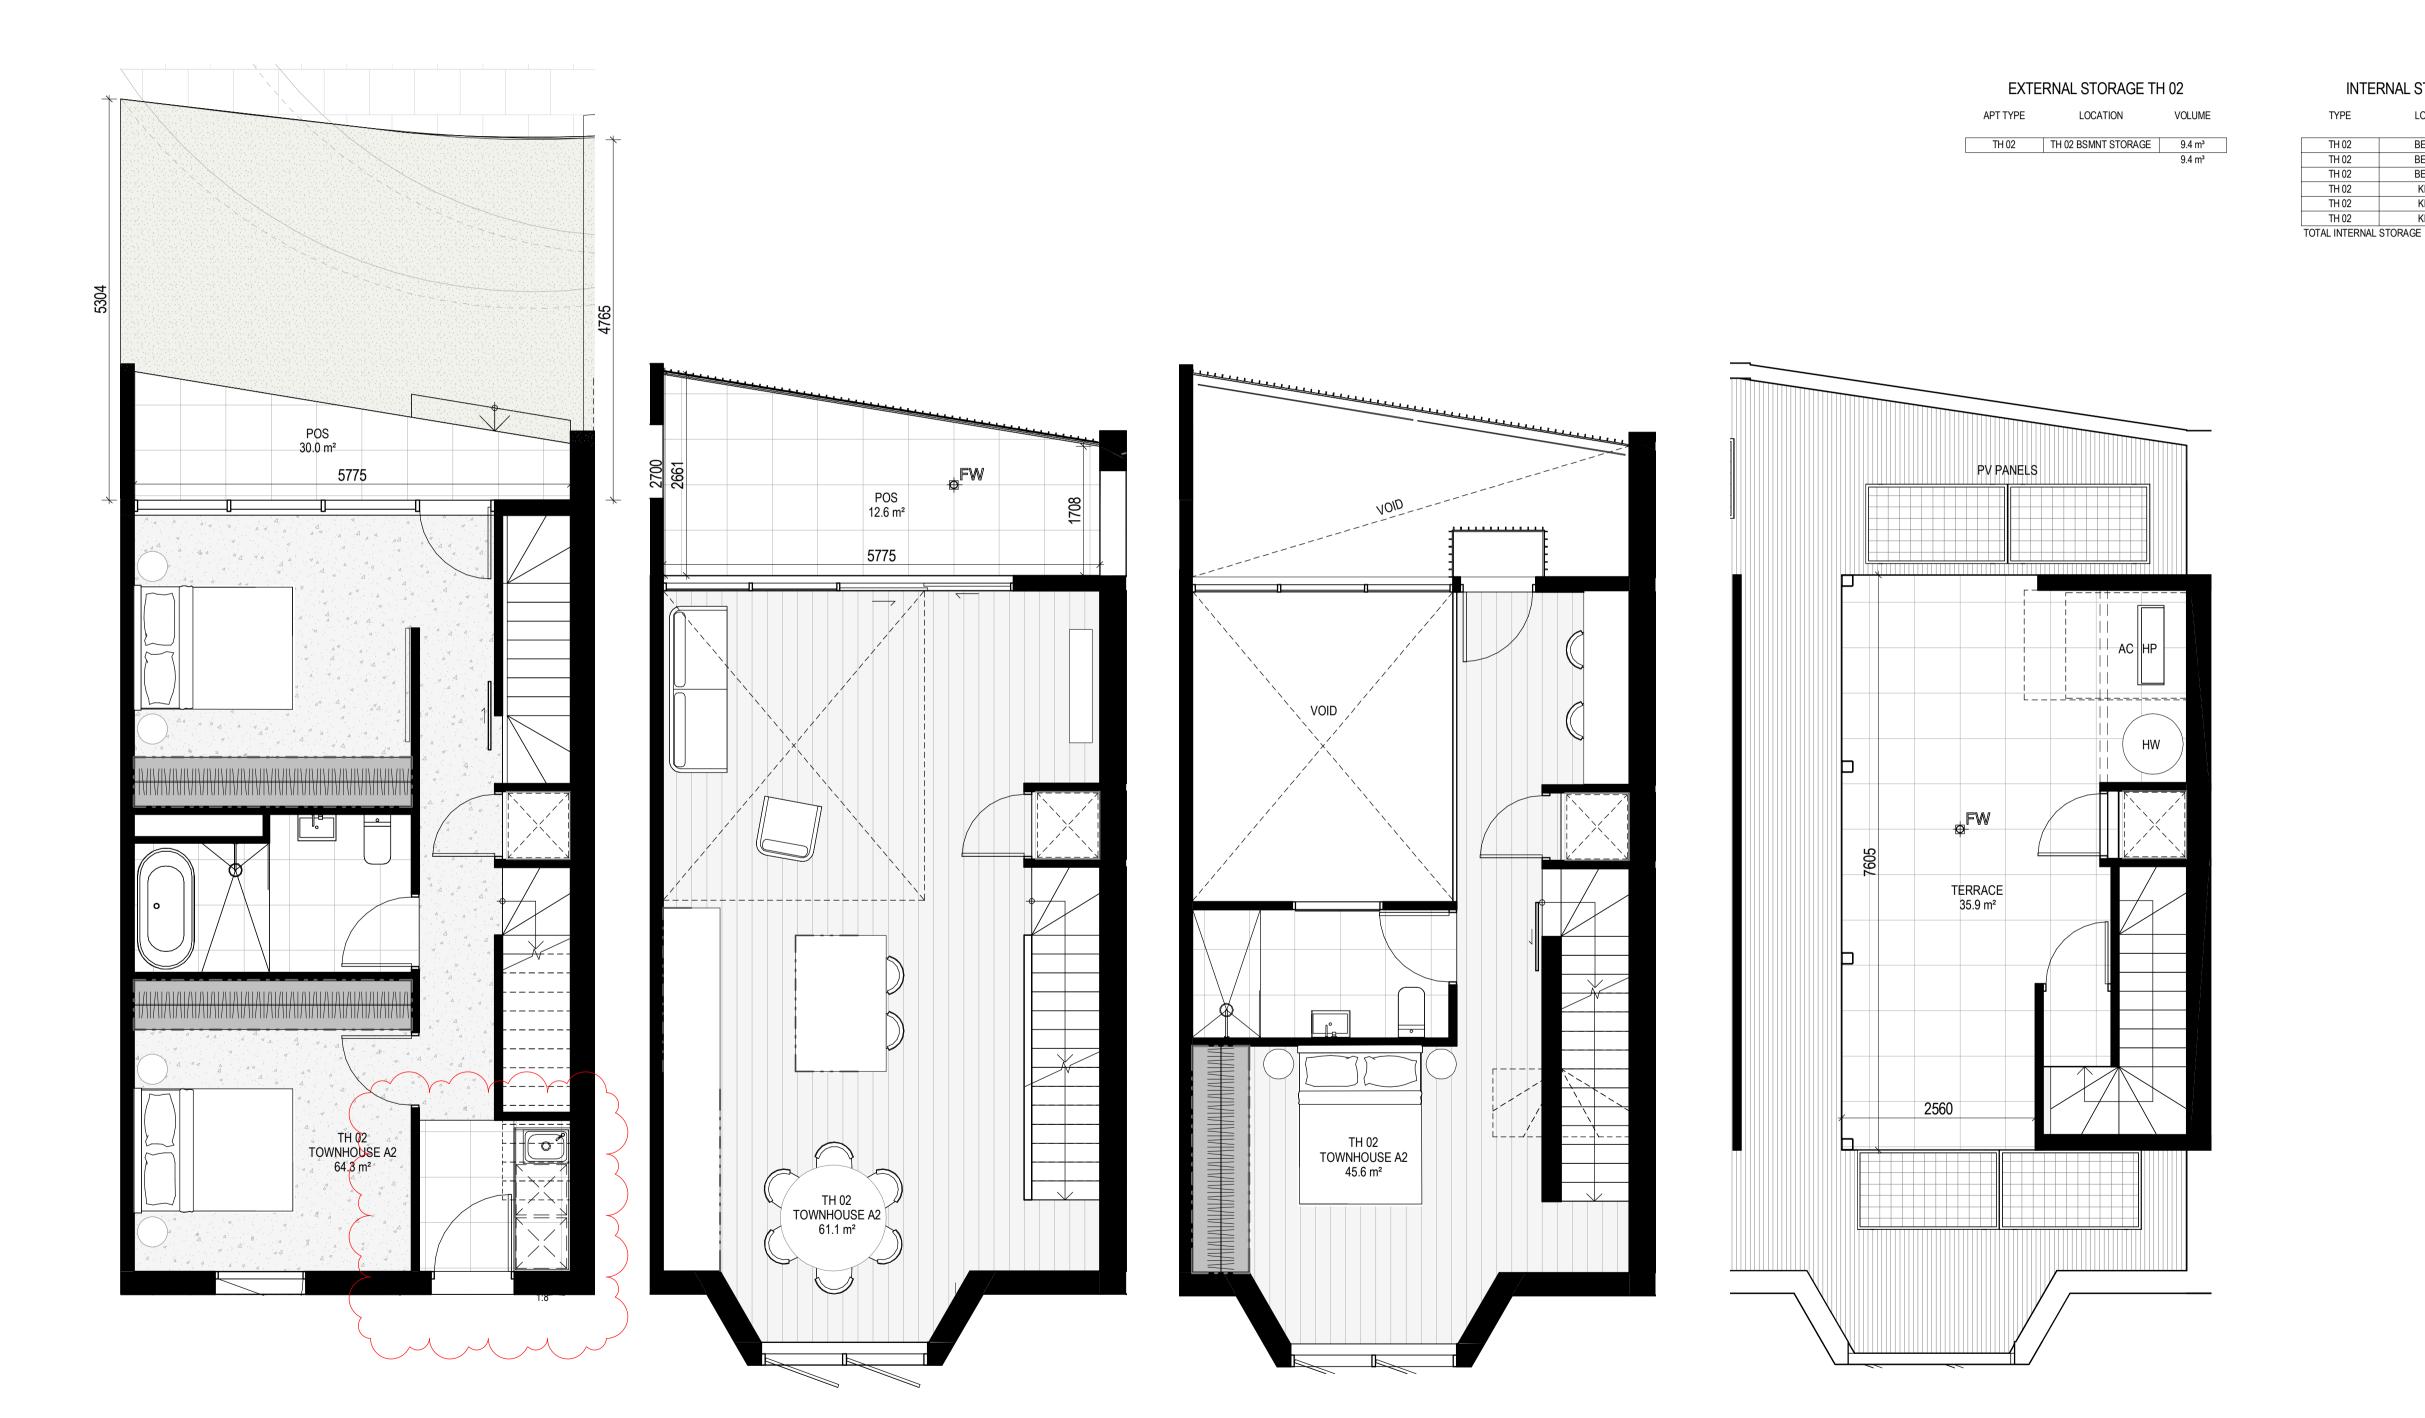

LEVEL 2 LEVEL GROUND LEVEL 1 LEVEL ROOF GENERAL NOTES

SURVEY: EXISTING SITE INFORMATION IS TAKEN FROM VERIS SURVEY NUMBER 303981-BG DATED 06/07/2023 AND IS PROVIDED HERE FOR ILLUSTRATIVE PURPOSES ONLY. FOR FULL SURVEY DETAILS REFER TO SURVEY DOCUMENTS PROVIDED WITHIN APPENDICIES.

LANDSCAPE DESIGN: LANDSCAPE DESIGN IS SHOWN INDICATIVELY. FOR FULL LANDSCAPE DETAILS REFER TO LANDSCAPE ARCHITECT'S

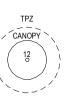

DOCUMENTATION.

EXISTING TREE WITHIN PROJECT BOUNDARY TO BE RETAINED. TREE NUMBER, TPZ AND CANOPY AS PER ARBORIST REPORT

ABBREVIATIONS:

AC CONDENSER UNIT
CL CLOTHES LINE
ELEC ELECTRICAL SERVICES HYDR HYDRAULIC SERVICES COM COMMS SERVICES FCL FINISHED CEILING LEVEL
FFL FINISHED FLOOR LEVEL
FHR FIRE HOSE REEL

FHY FIRE HYDRANT
FIP FIRE INDICATOR PANEL FW FLOOR WASTE NGL NATURAL GROUND LEVEL RL RELATIVE LEVEL
TP WATER TAP
HW HOT WATER UNIT

INTERNAL STORAGE TH-02

LOCATION

BEDROOM BEDROOM

KITCHEN

KITCHEN

KITCHEN

VOLUME

5.7 m³

5.4 m³ 1.4 m³

1.1 m³

0.6 m³

HEAT PUMP HOT WATER UNIT OW OPERABLE WINDOW

__ MATERIALS

BR1 BRICK WORK - BAGGED TEXTURE FINISH
BR2 BREEZE BLOCK
FC1 PAINTED FIBRE CEMENT SHEET

TL1 EXTERNAL TILE SC1 SUN SHADESCREEN MT1 VERTICAL ALUMINIUM BALUSTRADE
MT2 GLAVANISED STEEL CLADDING

MT3 METAL PERGOLA GL1 GLAZING - DOUBLE CLEAR
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MS1 CABLE MESH MS2 MESH FENCING

MS3 MESH SCREEN AS1 ACOUSTIC WALL PANEL SR1 SAFETY GUARD RAIL

ESD:

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TOWN PLANNING NOT FOR CONSTRUCTION





__KTA

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DRAWING TITLE TOWNHOUSE PLANS - TYPE A2

PROJECT 97 Alma Road

AT St Kilda East Neometro

27.07.2023 JL/TM/LG


As indicated(A1) 2202



City of Port Phillip Advertised Plan
Planning Application No. PDPL/00823/2022
No. of Pages: 37 of 50

EXTERNAL STORAGE TH 03

INTER	RNAL STORAGE TH	l-03
TYPE	LOCATION	VOLUME
TH 03	BEDROOM	5.7 m ³
TH 03	BEDROOM	5.7 m³
TH 03	BEDROOM	4.6 m³
TH 03	KITCHEN	1.5 m³
TH 03	KITCHEN	3.2 m³
TH 03	KITCHEN	0.9 m³
TOTAL INTERNAL STORAGE		21.7 m ³

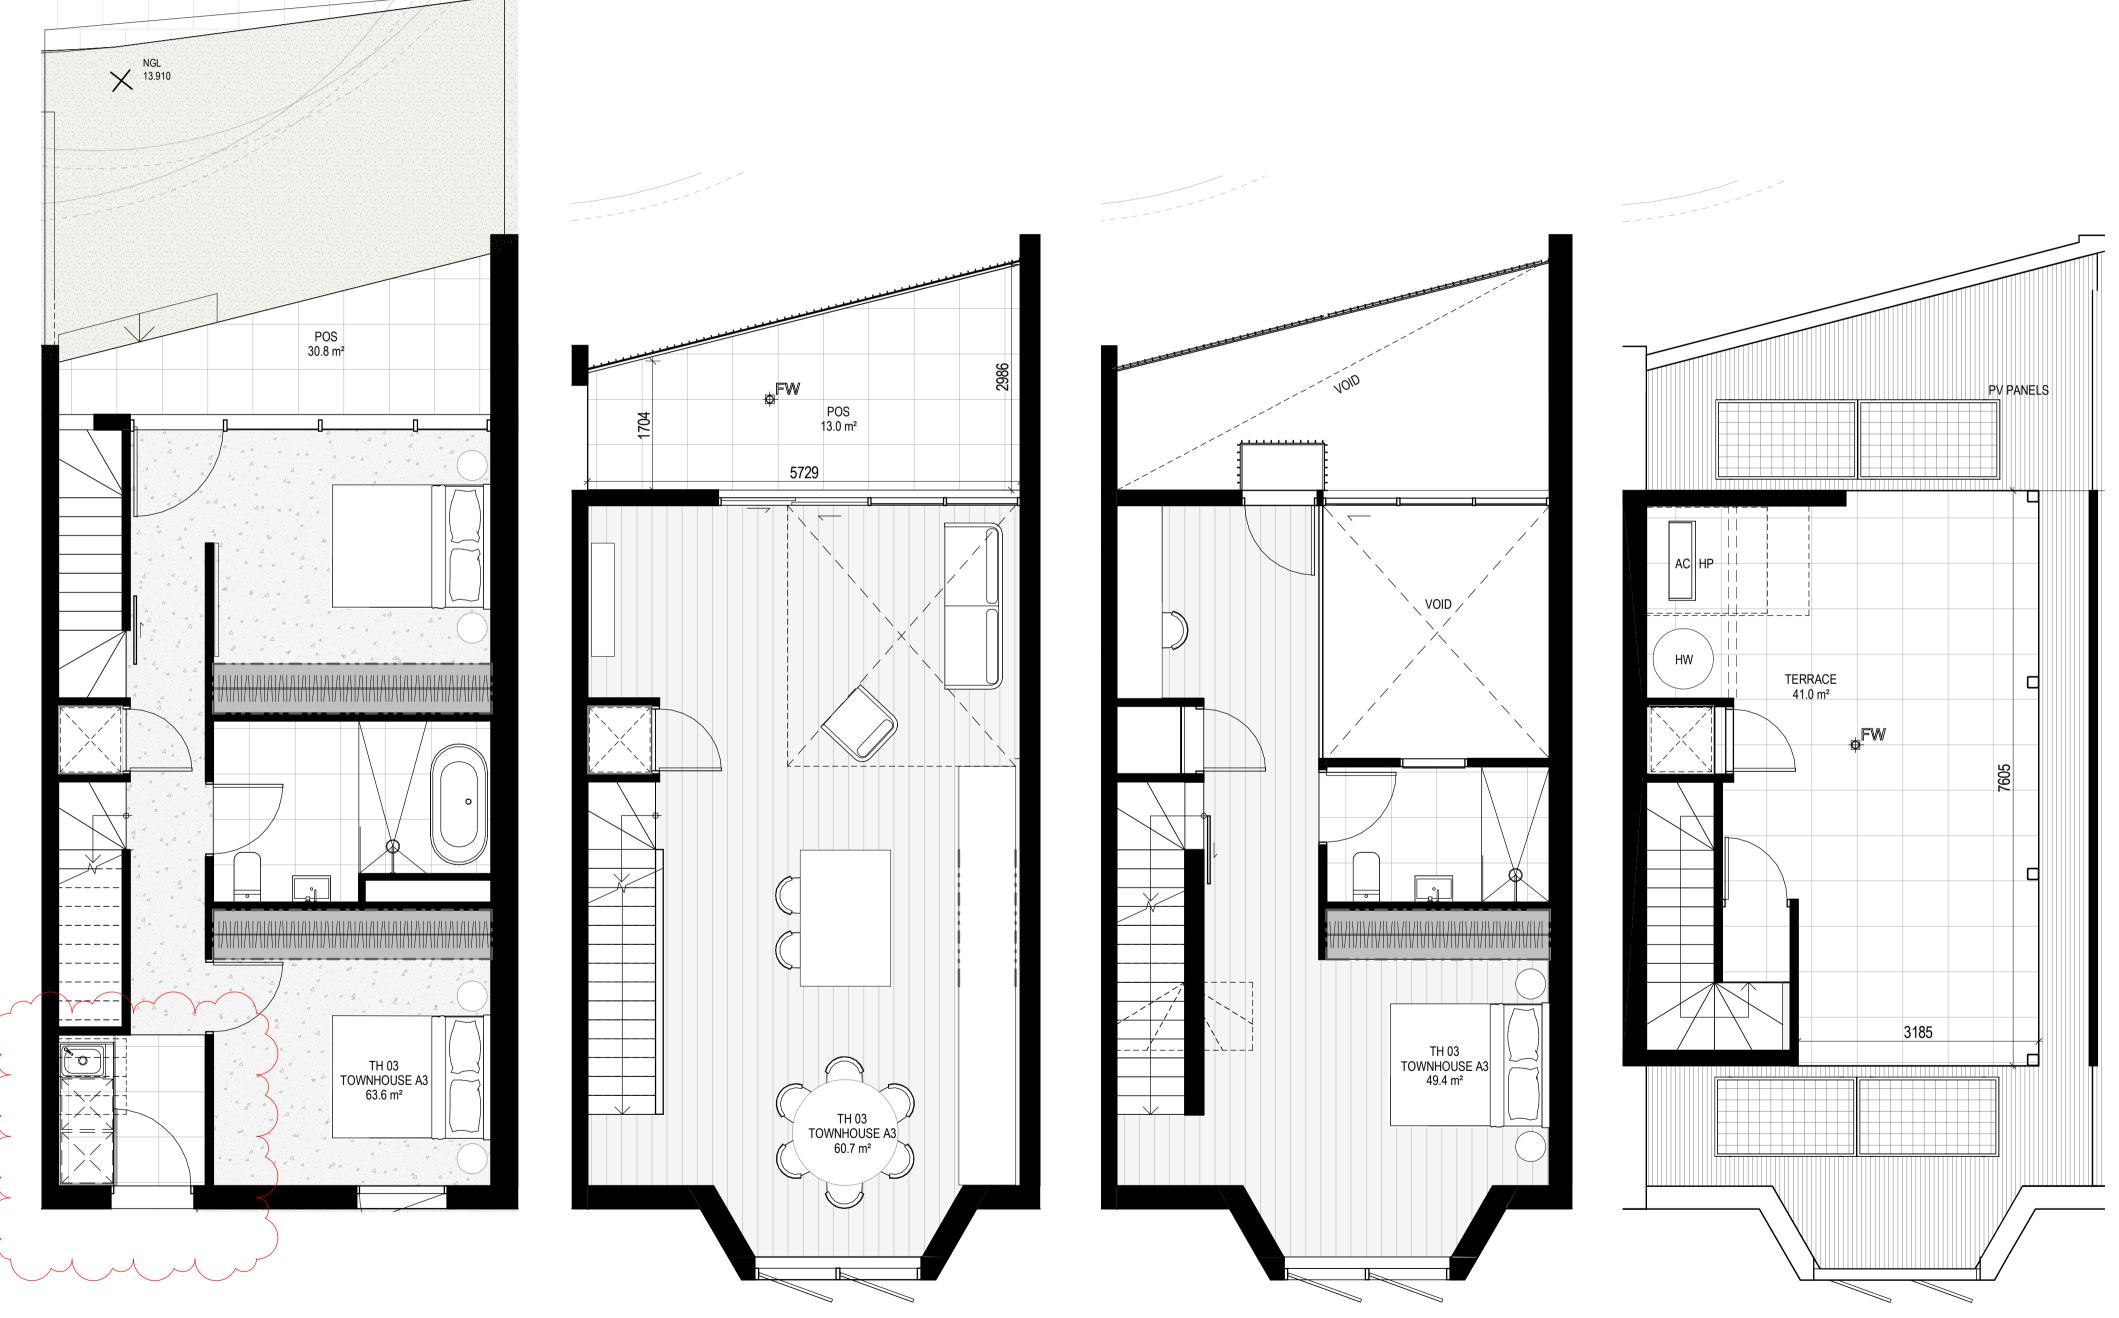


LEVEL ROOF LEVEL 1 LEVEL GROUND LEVEL 2

GENERAL NOTES

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DOCUMENTATION.

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COM COMMS SERVICES
FCL FINISHED CEILING LEVEL
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FIP FIRE INDICATOR PANEL
FW FLOOR WASTE
NGL NATURAL GROUND LEVEL

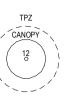HYDR HYDRAULIC SERVICES

RL RELATIVE LEVEL
TP WATER TAP
HW HOT WATER UNIT

HP HEAT PUMP HOT WATER UNIT OW OPERABLE WINDOW

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BR2 BREEZE BLOCK
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DRAWING TITLE TOWNHOUSE PLANS - TYPE A3

97 Alma Road

AT St Kilda East Neometro

27.07.2023 JL/TM/LG As indicated(A1) 2202





City of Port Phillip Advertised Plan Planning Application No. PDPL/00823/2022 No. of Pages: 38 of 50


EXTERNAL STORAGE TH 04


LOCATION TH 04 TH 04 BSMNT STORAGE INTERNAL STORAGE TH-04

TYPE	LOCATION	VOLUM
TH 04	BEDROOM	4.7 m ³
TH 04	BEDROOM	4.7 m ³
TH 04	BEDROOM	4.6 m ³
TH 04	KITCHEN	0.9 m ³
TH 04	KITCHEN	1.2 m ³
TOTAL INTERNAL	16.1 m	

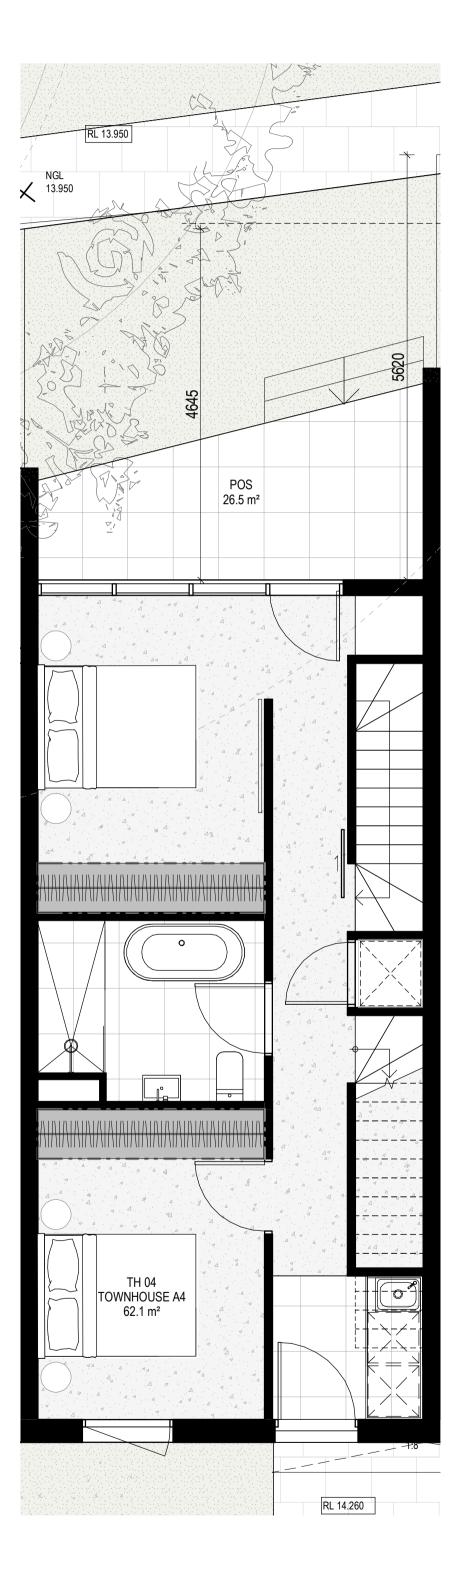

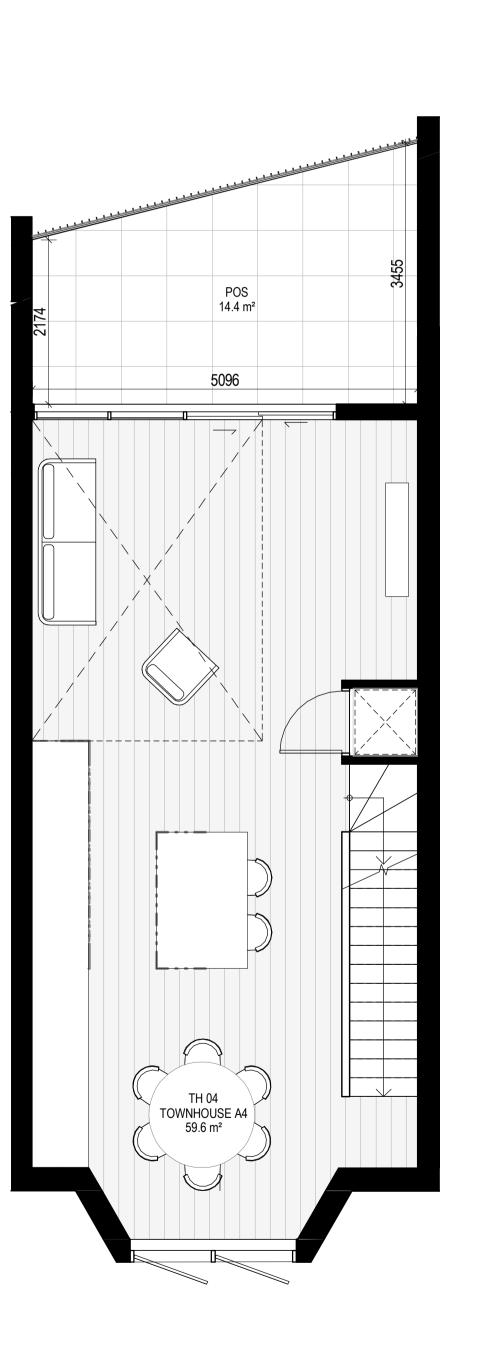

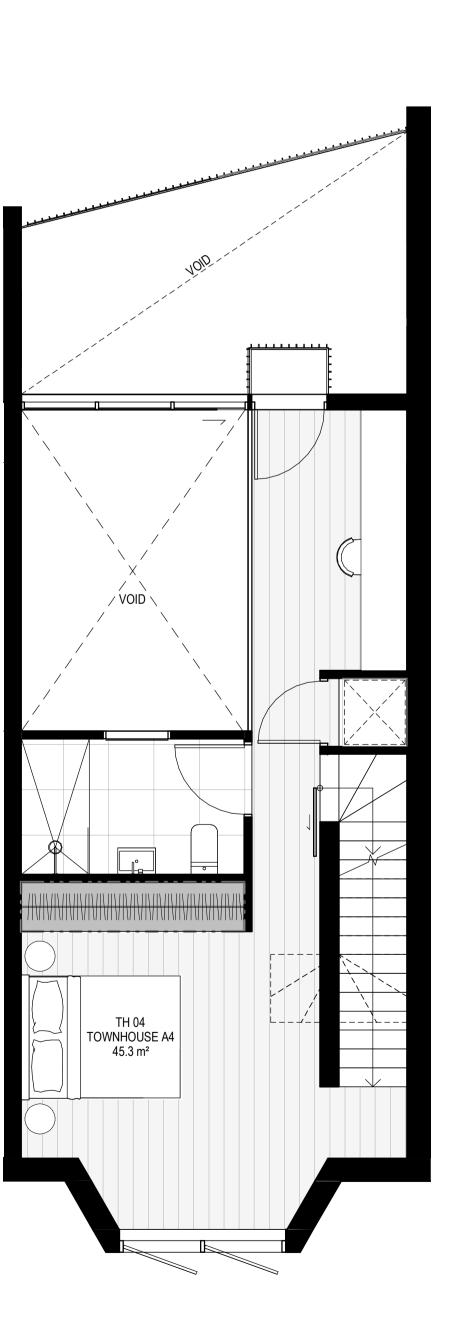


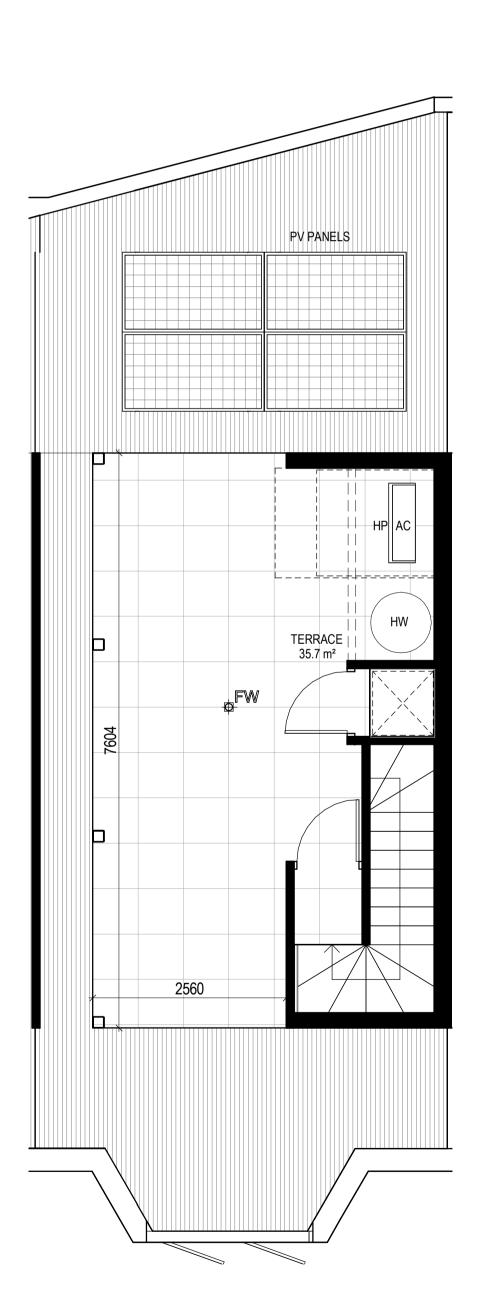

LEVEL 2 LEVEL GROUND LEVEL 1 LEVEL ROOF _GENERAL NOTES

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DOCUMENTATION.

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FW FLOOR WASTE
NGL NATURAL GROUND LEVEL

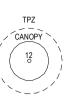RL RELATIVE LEVEL
TP WATER TAP
HW HOT WATER UNIT

__ MATERIALS

OW OPERABLE WINDOW

HEAT PUMP HOT WATER UNIT

BR1 BRICK WORK - BAGGED TEXTURE FINISH
BR2 BREEZE BLOCK
FC1 PAINTED FIBRE CEMENT SHEET TL1 EXTERNAL TILE

SC1 SUN SHADESCREEN
MT1 VERTICAL ALUMINIUM BALUSTRADE
MT2 GLAVANISED STEEL CLADDING

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MT3 METAL PERGOLA
GL1 GLAZING - DOUBLE CLEAR
GL2 OBSCURE GLAZING - REEDED
MS1 CABLE MESH
MS2 MESH FENCING
MS3 MESH SCREEN
AS4 ACQUISTIC WALL BANEL

AS1 ACOUSTIC WALL PANEL SR1 SAFETY GUARD RAIL

ESD:

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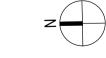
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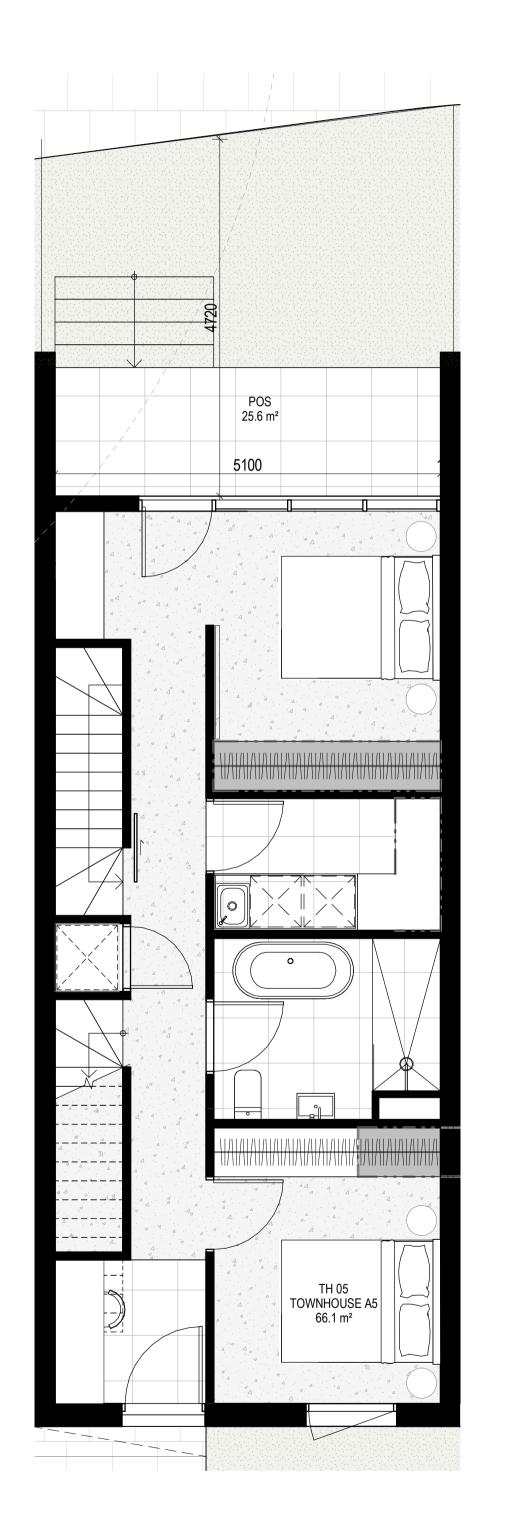
DRAWING TITLE TOWNHOUSE PLANS - TYPE A4


PROJECT 97 Alma Road


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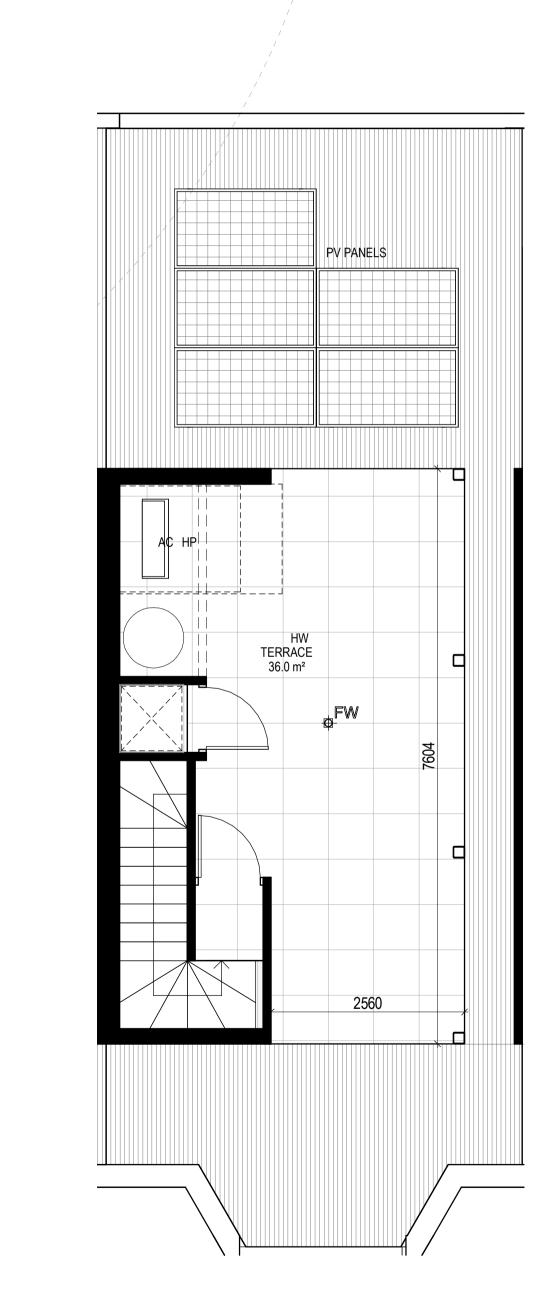
27.07.2023 JL/TM/LG As indicated(A1) 2202

City of Port Phillip Advertised Plan
Planning Application No. PDPL/00823/2022
No. of Pages: 39 of 50





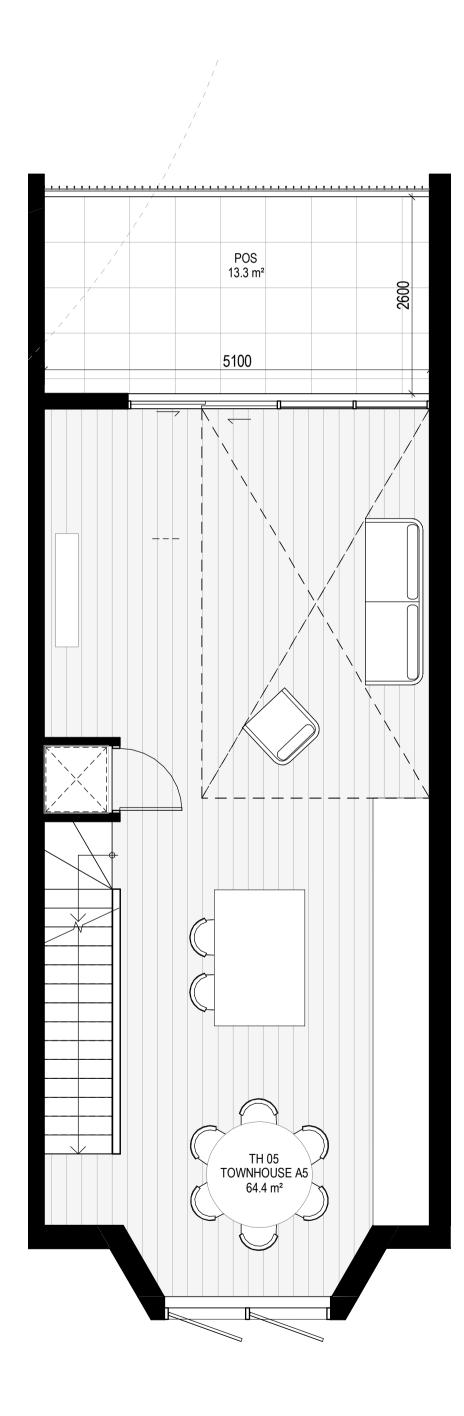

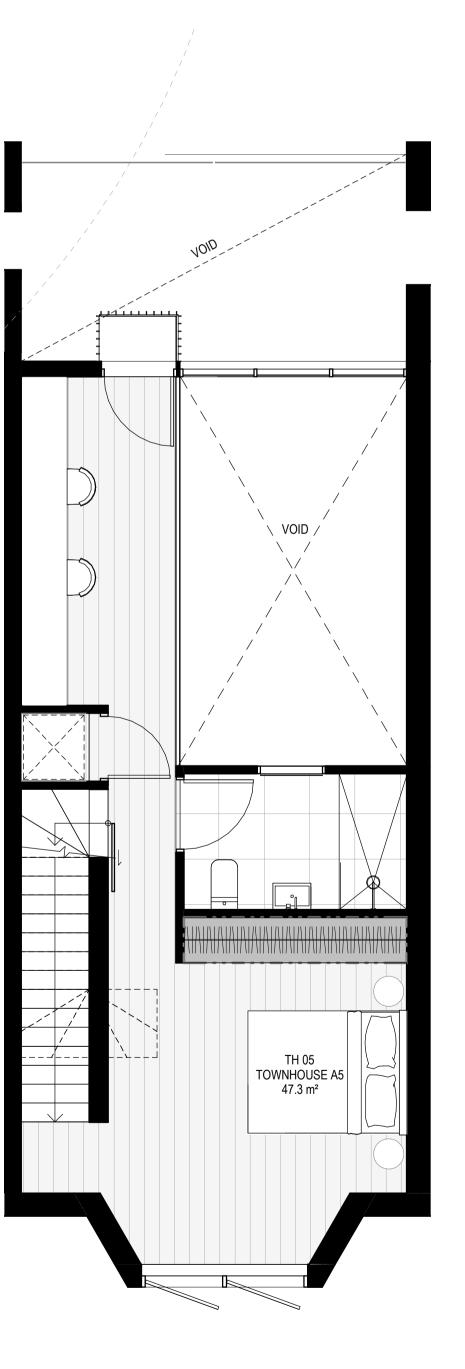

EXTERNAL STORAGE TH 05

LOCATION


TH 05 TH 04 BSMNT STORAGE 9.3 m³

LEVEL GROUND LEVEL 1 LEVEL 2 LEVEL ROOF

_GENERAL NOTES

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DOCUMENTATION.

INTERNAL STORAGE TH-05

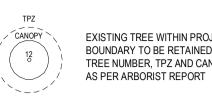LOCATION

BEDROOM

BEDROOM

BEDROOM

KITCHEN KITCHEN

KITCHEN

LAUNDRY

TH 05

TH 05 TH 05

TH 05

TH 05

TOTAL INTERNAL STORAGE

VOLUME

4.7 m³

4.7 m³

4.2 m³

1.5 m³ 1.2 m³

0.8 m³

0.8 m³

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RL RELATIVE LEVEL
TP WATER TAP
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__ MATERIALS

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4. THE NON-RESIDENTIAL AREAS ARE TARGETING A 2% DF TO 40% OF THE NOMINATED AREA.

5. 39% (16 OUT OF 41) OF APARTMENTS ACHIEVE AT LEAST 3 HOURS OF SUNLIGHT.

6. THE DEVELOPMENT IS PROVIDED WITH A COMPREHENSIVE SHADING STRATEGY.

7. THE DEVELOPMENT IS TO ACHIEVE A 7.5 STAR AVERAGE NATHERS ENERGY RATING RESULT FOR THE APARTMENTS AND A 7.0 STAR AVERAGE NATHERS ENERGY ENERGY RATING RESULT FOR THE APARTMENTS AND A 7.0 STAR AVERAGE NATHERS

ENERGY RATING RESULT FOR THE TOWNHOUSES.

8. THE NON-RESIDENTIAL AREAS AIM TO REDUCE HEATING AND COOLING ENERGY CONSUMPTION BELOW THE REFERENCE CASE (BCA SECTION J 2019).

CONSUMPTION BELOW THE REFERENCE CASE (BCA SECTION J 2019).

9. THE DEVELOPMENT IS TO UTILISE ELECTRIC HEAT PUMP HOT WATER SYSTEM.

10. A 9.6KW SOLAR PV SYSTEM IS TO BE LOCATED ON THE ROOF OF THE APARTMENT BUILDING.

11. A 2KW SOLAR PV SYSTEM IS TO BE PROVIDED FOR EACH TOWNHOUSE.

12. INDIVIDUAL COLD WATER AND ELECTRICITY METERS WILL BE PROVIDED TO THE APARTMENTS, TOWNHOUSES AND COMMUNAL AREAS.

13. WATER EFFICIENT FITTINGS AND FIXTURES ARE APPLIED THROUGHOUT.

14. A 32,000-LITRE RAINWATER TANK AND A 30,000-LITRE RAINWATER TANK WILL HARVEST RAINWATER FROM THE APARTMENT ROOF AND TOWNHOUSE ROOFS RESPECTIVELY. THESE TANKS WILL BE CONNECTED TO ALL TOILETS.

15. A MELBOURNE STORM RATING OF 102% IS ACHIEVED.

16. ALL LANDSCAPING IS TO BE NATIVE SPECIES OR LANDSCAPING IRRIGATION IS TO BE CONNECTED TO THE RAINWATER TANK ONLY.

17. IN TOTAL 62 BICYCLE SPACES ARE TO BE PROVIDED FOR RESIDENTS.

18. IN TOTAL 2 BICYCLE SPACES ARE TO BE PROVIDED FOR RESIDENTIAL AND NON-RESIDENTIAL VISITORS.


20. ONE CHARGING POINT FOR ELECTRICAL VEHICLES IS INTEGRATED IN THE PROPOSED DEVELOPMENT.

21. 1414 20 F COMMUNAL FOOD PRODUCTION AREA WILL BE PROVIDED.

REFER TO ESD CONSULANTS DOCUMENTATION FOR FULL DETAILS

No. Date Description 18.11.2022 Issued for Town Planning 15.03.2023 Issued for RFI Response 2 27.07.2023 Amended TP Submission

TOWN PLANNING NOT FOR CONSTRUCTION

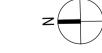

__KTA

Kerstin Thompson Architects Pty Ltd 277 Queensberry St, Melbourne Australia 3000 T +61 3 8662 8800 kta@kerstinthompson.com www.kerstinthompson.com

DRAWING TITLE TOWNHOUSE PLANS - TYPE A5

97 Alma Road

AT St Kilda East Neometro

27.07.2023 JL/TM/LG As indicated(A1) 2202

City of Port Phillip Advertised Plan Planning Application No. PDPL/00823/2022 No. of Pages: 40 of 50

EXTERNAL STORAGE TH 06

LOCATION


TH 06 TH 06 BSMNT STORAGE 7.1 m³


INTERNAL STORAGE TH-06

TOTAL INTERNAL STORAGE

TYPE	LOCATION	VOLUME
TH 06	BEDROOM	4.7 m³
TH 06	BEDROOM	4.7 m³
TH 06	BEDROOM	4.2 m³
TH 06	KITCHEN	1.7 m³
TH 06	KITCHEN	1.1 m³
TH 06	KITCHEN	1.3 m³
TH 06	LAUNDRY	0.8 m ³



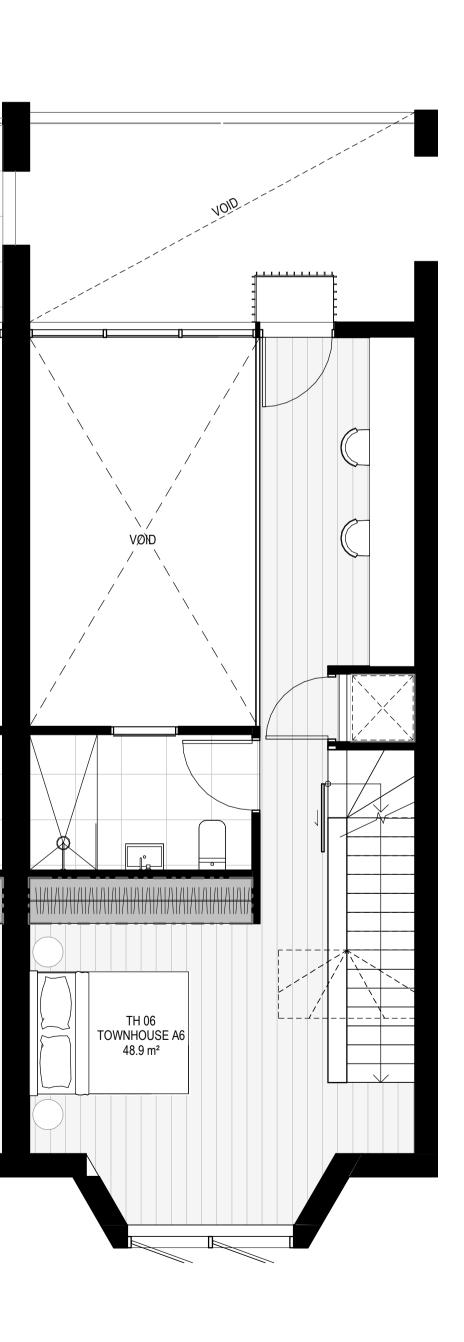

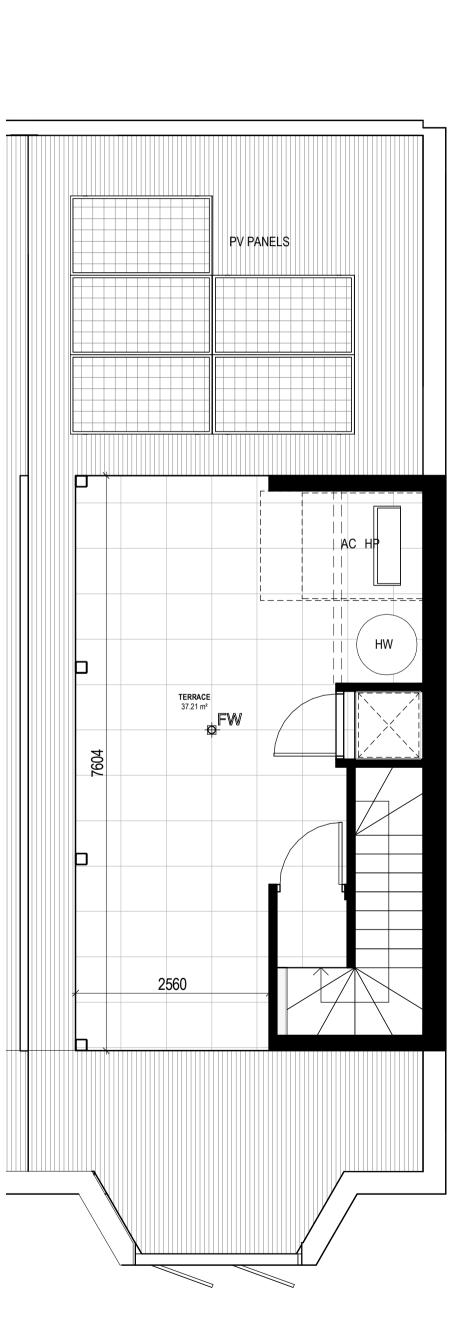

LEVEL 2 LEVEL 1 LEVEL GROUND LEVEL ROOF _GENERAL NOTES

SURVEY: EXISTING SITE INFORMATION IS TAKEN FROM VERIS SURVEY NUMBER 303981-BG DATED 06/07/2023 AND IS PROVIDED HERE FOR ILLUSTRATIVE PURPOSES ONLY. FOR FULL SURVEY DETAILS REFER TO SURVEY DOCUMENTS PROVIDED WITHIN

APPENDICIES. LANDSCAPE DESIGN: LANDSCAPE DESIGN IS SHOWN INDICATIVELY. FOR FULL LANDSCAPE DETAILS REFER TO LANDSCAPE ARCHITECT'S



DOCUMENTATION.

EXISTING TREE WITHIN PROJECT BOUNDARY TO BE RETAINED. TREE NUMBER, TPZ AND CANOPY AS PER ARBORIST REPORT

ABBREVIATIONS: AC CONDENSER UNIT
CL CLOTHES LINE
ELEC ELECTRICAL SERVICES

HYDR HYDRAULIC SERVICES COM COMMS SERVICES FCL FINISHED CEILING LEVEL FFL FINISHED FLOOR LEVEL FHR FIRE HOSE REEL

FHY FIRE HYDRANT
FIP FIRE INDICATOR PANEL FW FLOOR WASTE NGL NATURAL GROUND LEVEL

RL RELATIVE LEVEL
TP WATER TAP
HW HOT WATER UNIT HEAT PUMP HOT WATER UNIT OW OPERABLE WINDOW

__ MATERIALS

BR1 BRICK WORK - BAGGED TEXTURE FINISH
BR2 BREEZE BLOCK
FC1 PAINTED FIBRE CEMENT SHEET

TL1 EXTERNAL TILE

SC1 SUN SHADESCREEN
MT1 VERTICAL ALUMINIUM BALUSTRADE MT2 GLAVANISED STEEL CLADDING MT3 METAL PERGOLA

GL1 GLAZING - DOUBLE CLEAR
GL2 OBSCURE GLAZING - REEDED

MS1 CABLE MESH MS2 MESH FENCING MS3 MESH SCREEN AS1 ACOUSTIC WALL PANEL

SR1 SAFETY GUARD RAIL

ESD:

1. THE PROJECT ACHIEVES A TOTAL BESS SCORE OF 73% WITH NO MANDATORY CATEGORY (IEQ, ENERGY, WATER, STORMWATER) BELOW 50%.

2. 100% (41 OUT OF 41) OF THE DEVELOPMENT'S APARTMENTS AND 100% (21 OUT OF 21) OF THE DEVELOPMENT'S TOWNHOUSES ARE NATURALLY CROSS-VENTILATED.

3. DAYLIGHT MODELLING HAS BEEN CONDUCTED FOR A REPRESENTATIVE SAMPLE OF APARTMENTS. THE SUMMARY RESULT IS AS FOLLOWS:

• 88% OF LIVING FLOOR AREA ACHIEVES >90% ABOVE DF 1

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20. ONE CHARGING POINT FOR ELECTRICAL VEHICLES IS INTEGRATED IN THE PROPOSED DEVELOPMENT.

21. 141M 20 F COMMUNAL SPACE WILL BE PROVIDED AT THE ROOFTOP DECK.


22. 24M2 OF COMMUNAL FOOD PRODUCTION AREA WILL BE PROVIDED.

REFER TO ESD CONSULANTS DOCUMENTATION FOR FULL DETAILS

No. Date Description 19.09.2022 Issued for Information 15.03.2023 Issued for RFI Response

2 27.07.2023 Amended TP Submission

TOWN PLANNING NOT FOR CONSTRUCTION

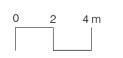



_KTA

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DRAWING TITLE TOWNHOUSE PLANS - TYPE A6

97 Alma Road

AT St Kilda East Neometro 27.07.2023 JL/TM/LG SCALE PROJECT

As indicated(A1) 2202




City of Port Phillip Advertised Plan Planning Application No. PDPL/00823/2022 No. of Pages: 41 of 50

TH TYPE B1 TOWNHOUSE B1 TOWNHOUSE B1 TOWNHOUSE B1


EXTERNAL STORAGE TH 09 LOCATION TH 09 TH 09 BSMNT STORAGE 5.0 m³ INTERNAL STORAGE TH-09 LOCATION

TH 09	BEDROOM	2.6 m ³
TH 09	BEDROOM	4.5 m³
TH 09	BEDROOM	4.1 m³
TH 09	BEDROOM	4.7 m³
TH 09	BEDROOM	2.6 m³
TH 09	KITCHEN	1.1 m³
TH 09	KITCHEN	0.5 m ³
TH 09	KITCHEN	1.4 m³
TH 09	KITCHEN	0.7 m³
TH 09	KITCHEN	1.8 m³
TH 09	KITCHEN	0.3 m ³
TH 09	KITCHEN	0.9 m³
TH 09	LAUNDRY	0.8 m³
TOTAL INTERNAL	26.0 m³	


LEVEL GROUND

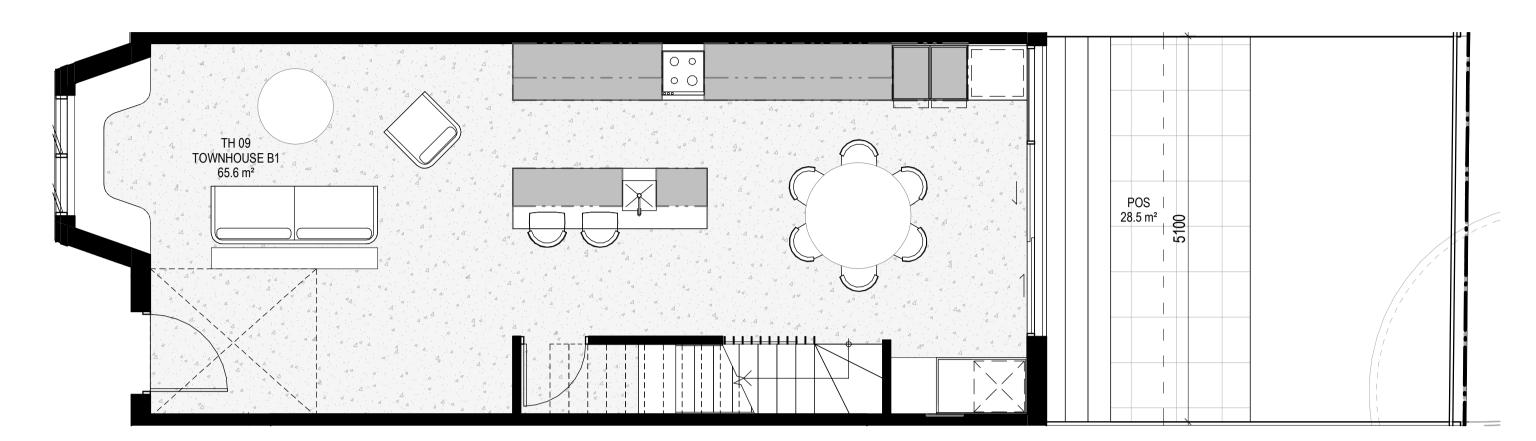

LEVEL 1

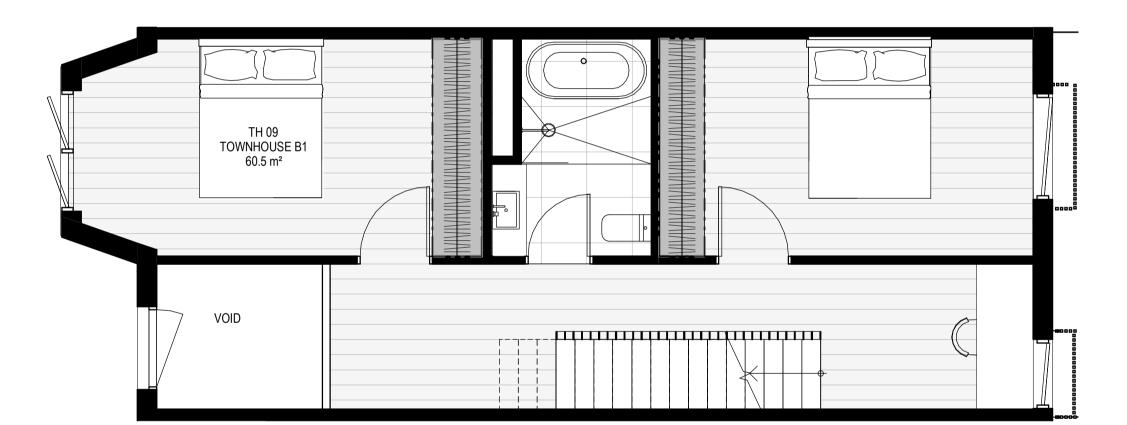

LEVEL 2

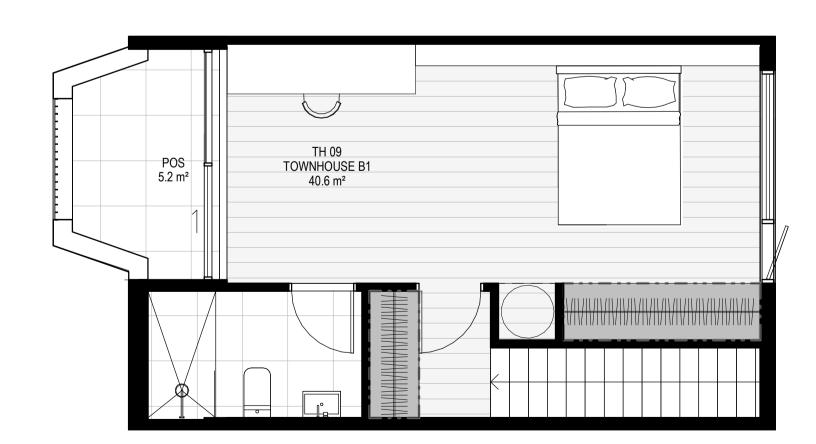

_GENERAL NOTES

SURVEY: EXISTING SITE INFORMATION IS TAKEN FROM VERIS SURVEY NUMBER 303981-BG DATED 06/07/2023 AND IS PROVIDED HERE FOR ILLUSTRATIVE PURPOSES ONLY. FOR FULL SURVEY DETAILS REFER TO SURVEY DOCUMENTS PROVIDED WITHIN APPENDICIES.

LANDSCAPE DESIGN: LANDSCAPE DESIGN IS SHOWN INDICATIVELY. FOR FULL LANDSCAPE DETAILS REFER TO LANDSCAPE ARCHITECT'S



DOCUMENTATION.

EXISTING TREE WITHIN PROJECT BOUNDARY TO BE RETAINED. TREE NUMBER, TPZ AND CANOPY AS PER ARBORIST REPORT

AC CONDENSER UNIT CL CLOTHES LINE

COM COMMS SERVICES FCL FINISHED CEILING LEVEL FFL FINISHED FLOOR LEVEL FHR FIRE HOSE REEL FHY FIRE HYDRANT FIP FIRE INDICATOR PANEL FW FLOOR WASTE NGL NATURAL GROUND LEVEL RELATIVE LEVEL

ELEC ELECTRICAL SERVICES HYDR HYDRAULIC SERVICES

WATER TAP HW HOT WATER UNIT HP HEAT PUMP HOT WATER UNIT OW OPERABLE WINDOW

__ MATERIALS

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FC1 PAINTED FIBRE CEMENT SHEET TL1 EXTERNAL TILE SC1 SUN SHADESCREEN

MT1 VERTICAL ALUMINIUM BALUSTRADE MT2 GLAVANISED STEEL CLADDING MT3 METAL PERGOLA GL1 GLAZING - DOUBLE CLEAR
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MS1 CABLE MESH MS2 MESH FENCING MS3 MESH SCREEN

AS1 ACOUSTIC WALL PANEL SR1 SAFETY GUARD RAIL

ESD:

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20. ONE CHARGING POINT FOR ELECTRICAL VEHICLES IS INTEGRATED IN THE PROPOSED DEVELOPMENT.


21. 141M2 OF COMMUNAL SPACE WILL BE PROVIDED AT THE ROOFTOP DECK.

22. 24M2 OF COMMUNAL FOOD PRODUCTION AREA WILL BE PROVIDED.

REFER TO ESD CONSULANTS DOCUMENTATION FOR FULL DETAILS

No. Date Description 18.11.2022 Issued for Town Planning 15.03.2023 Issued for RFI Response 2 27.07.2023 Amended TP Submission

> **TOWN PLANNING** NOT FOR CONSTRUCTION

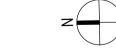

__KTA

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DRAWING TITLE TOWNHOUSE PLANS - TYPE B1


PROJECT 97 Alma Road

AT St Kilda East Neometro

DATE DRAWN BY 27.07.2023 JL/TM/LG SCALE PROJECT TP66 As indicated(A1) 2202



City of Port Phillip Advertised Plan Planning Application No. PDPL/00823/2022 No. of Pages: 42 of 50

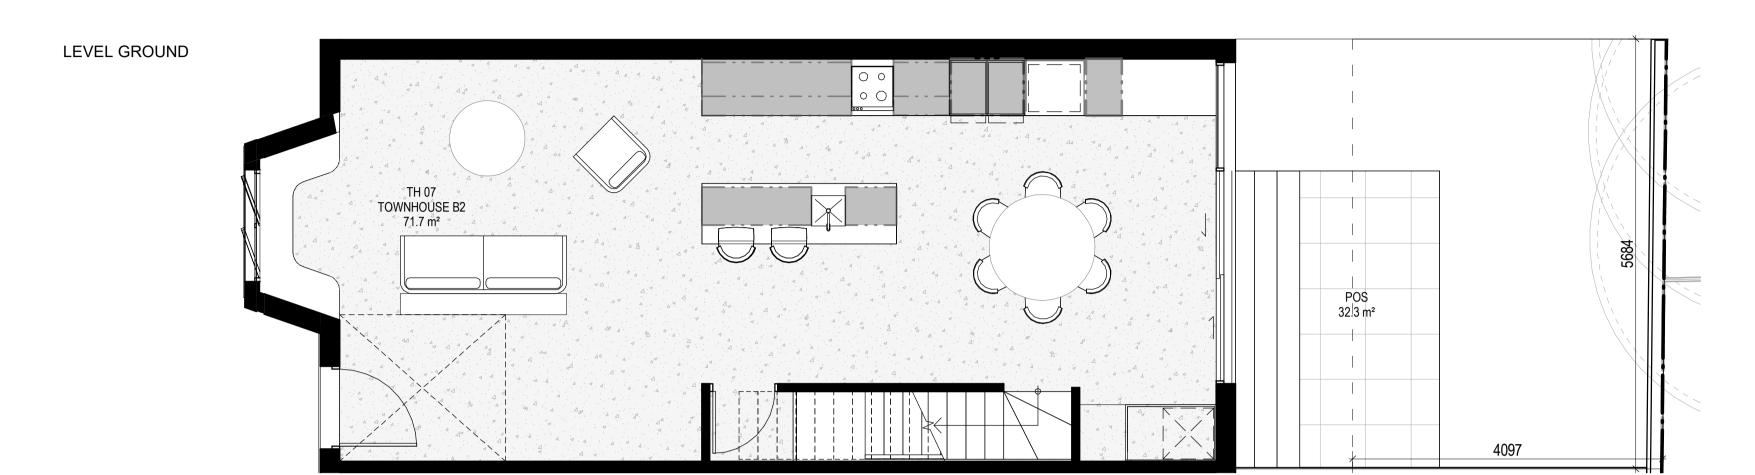


EXTERNAL STORAGE TH 07 LOCATION VOLUME

INTERNAL STORAGE TH-07 LOCATION VOLUME 5.1 m³ BEDROOM BEDROOM 2.6 m³ BEDROOM KITCHEN 1.1 m³ 0.5 m³ KITCHEN 0.7 m³ KITCHEN KITCHEN TH 07 KITCHEN 0.4 m³ 1.7 m³ KITCHEN TH 07 0.3 m³ 0.8 m³ KITCHEN LAUNDRY TOTAL INTERNAL STORAGE 20.4 m³

TOWNHOUSE B2 67.2 m² VOID

LEVEL 1


LEVEL 2

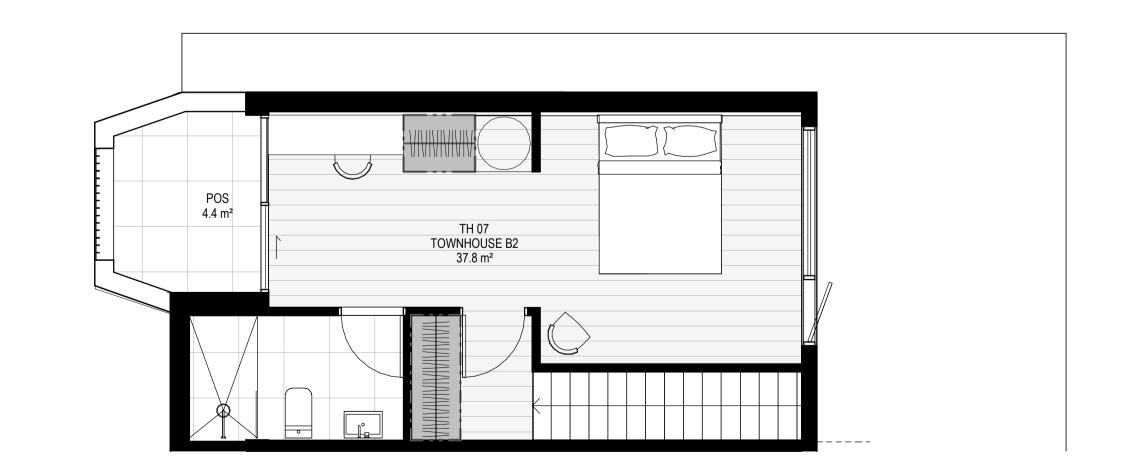

GENERAL NOTES

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LANDSCAPE DESIGN: LANDSCAPE DESIGN IS SHOWN INDICATIVELY. FOR FULL LANDSCAPE DETAILS REFER TO LANDSCAPE ARCHITECT'S

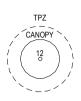

DOCUMENTATION.

EXISTING TREE WITHIN PROJECT BOUNDARY TO BE RETAINED. TREE NUMBER, TPZ AND CANOPY AS PER ARBORIST REPORT

ABBREVIATIONS: AC CONDENSER UNIT CL CLOTHES LINE

FCL FINISHED CEILING LEVEL FFL FINISHED FLOOR LEVEL FHR FIRE HOSE REEL FHY FIRE HYDRANT FIP FIRE INDICATOR PANEL FW FLOOR WASTE NGL NATURAL GROUND LEVEL RELATIVE LEVEL

ELEC ELECTRICAL SERVICES HYDR HYDRAULIC SERVICES

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WATER TAP HW HOT WATER UNIT HEAT PUMP HOT WATER UNIT OW OPERABLE WINDOW

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BR1 BRICK WORK - BAGGED TEXTURE FINISH BR2 BREEZE BLOCK FC1 PAINTED FIBRE CEMENT SHEET TL1 EXTERNAL TILE

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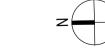
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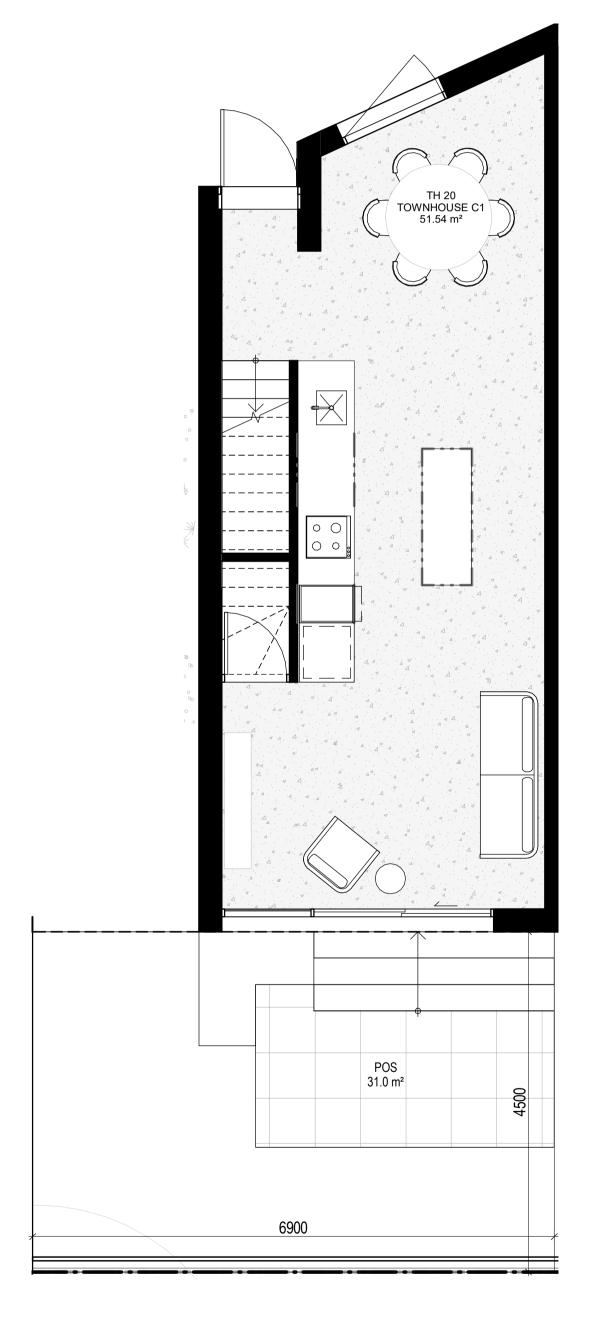
DRAWING TITLE TOWNHOUSE PLANS - TYPE B2


PROJECT 97 Alma Road


AT St Kilda East Neometro

DATE DRAWN BY 27.07.2023 JL/TM/LG SCALE PROJECT TP66 TP661 2 As indicated(A1) 2202

City of Port Phillip Advertised Plan Planning Application No. PDPL/00823/2022 No. of Pages: 43 of 50



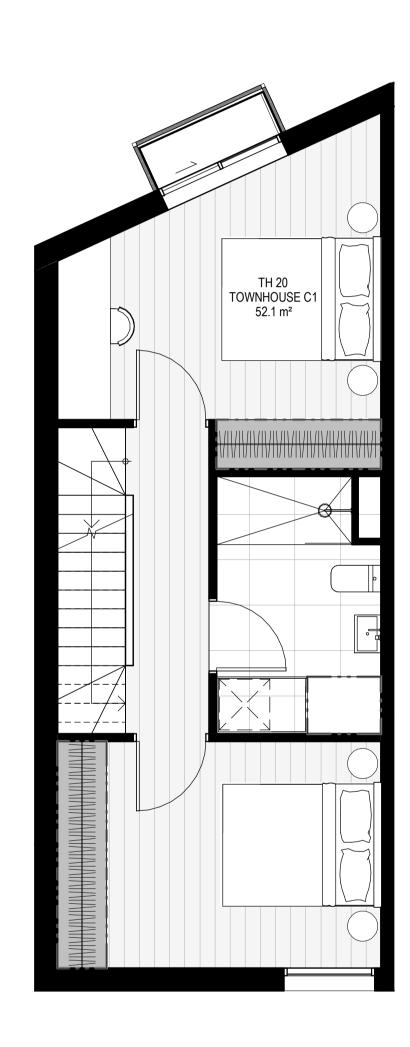

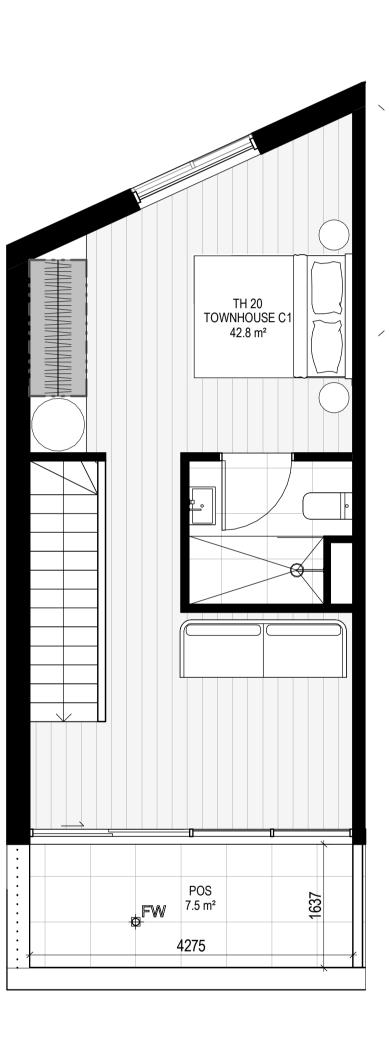

LEVEL 1 LEVEL 2 LEVEL GROUND


INTERNAL STORAGE TH-20

LOCATION	VOLUME	
BEDROOM	3.4 m³	
BEDROOM	4.7 m³	
BEDROOM	3.2 m³	
KITCHEN	0.9 m³	
KITCHEN	0.5 m³	
LAUNDRY	1.7 m³	
TOTAL INTERNAL STORAGE		
	BEDROOM BEDROOM BEDROOM KITCHEN KITCHEN LAUNDRY	

GENERAL NOTES

SURVEY: EXISTING SITE INFORMATION IS TAKEN FROM VERIS SURVEY NUMBER 303981-BG DATED 06/07/2023 AND IS PROVIDED HERE FOR ILLUSTRATIVE PURPOSES ONLY. FOR FULL SURVEY DETAILS REFER TO SURVEY DOCUMENTS PROVIDED WITHIN

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GL1 GLAZING - DOUBLE CLEAR
GL2 OBSCURE GLAZING - REEDED
MS1 CABLE MESH
MS2 MESH FENCING
MS3 MESH SCREEN
AS1 ACOUSTIC WALL PANEL
SR1 SAFETY GUARD RAIL

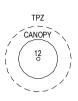ESD:

1. THE PROJECT ACHIEVES A TOTAL BESS SCORE OF 73% WITH NO MANDATORY CATEGORY (IEQ, ENERGY, WATER, STORMWATER) BELOW 50%.

2. 100% (41 OUT OF 41) OF THE DEVELOPMENT'S APARTMENTS AND 100% (21 OUT OF 21) OF THE DEVELOPMENT'S TOWNHOUSES ARE NATURALLY CROSS-VENTILATED.

3. DAYLIGHT MODELLING HAS BEEN CONDUCTED FOR A REPRESENTATIVE SAMPLE OF APARTMENTS. THE SUMMARY RESULT IS AS FOLLOWS:

• 88% OF LIVING FLOOR AREA ACHIEVES >90% ABOVE DF 1

• 92% OF BEDROOM FLOOR AREA ACHIEVES >90% ABOVE DF0.5

4. THE NON-RESIDENTIAL AREAS ARE TARGETING A 2% DF TO 40% OF THE NOMINATED AREA.

5. 39% (16 OUT OF 41) OF APARTMENTS ACHIEVE AT LEAST 3 HOURS OF SUNLIGHT.

6. THE DEVELOPMENT IS PROVIDED WITH A COMPREHENSIVE SHADING STRATEGY.

7. THE DEVELOPMENT IS TO ACHIEVE A 7.5 STAR AVERAGE NATHERS ENERGY RATING RESULT FOR THE TOWNHOUSES.

ENERGY RATING RESULT FOR THE TOWNHOUSES.

8. THE NON-RESIDENTIAL AREAS AIM TO REDUCE HEATING AND COOLING ENERGY CONSUMPTION BELOW THE REFERENCE CASE (BCA SECTION J 2019).

CONSUMPTION BELOW THE REFERENCE CASE (BCA SECTION J 2019).

9. THE DEVELOPMENT IS TO UTILISE ELECTRIC HEAT PUMP HOT WATER SYSTEM.

10. A 9.6KW SOLAR PV SYSTEM IS TO BE LOCATED ON THE ROOF OF THE APARTMENT BUILDING.

11. A 2KW SOLAR PV SYSTEM IS TO BE PROVIDED FOR EACH TOWNHOUSE.

12. INDIVIDUAL COLD WATER AND ELECTRICITY METERS WILL BE PROVIDED TO THE APARTMENTS, TOWNHOUSES

AND COMMUNAL AREAS.

13. WATER EFFICIENT FITTINGS AND FIXTURES ARE APPLIED THROUGHOUT.

14. A 32.000-LITRE RAINWATER TANK AND A 30,000-LITRE RAINWATER TANK WILL HARVEST RAINWATER FROM THE
APARTMENT ROOF AND TOWNHOUSE ROOFS RESPECTIVELY. THESE TANKS WILL BE CONNECTED TO ALL TOILETS.

15. A MELBOURNE STORM RATING OF 102% IS ACHIEVED.

16. ALL LANDSCAPING IS TO BE NATIVE SPECIES OR LANDSCAPING IRRIGATION IS TO BE CONNECTED TO THE RAINWATER TANK ONLY.

17. IN TOTAL 62 BICYCLE SPACES ARE TO BE PROVIDED FOR RESIDENTS.

18. IN TOTAL 12 BICYCLE SPACES ARE TO BE PROVIDED FOR RESIDENTIAL AND NON-RESIDENTIAL VISITORS.

20. ONE CHARGING POINT FOR ELECTRICAL VEHICLES IS INTEGRATED IN THE PROPOSED DEVELOPMENT.


21. 141M 20 F COMMUNAL FOAD PRODUCTION AREA WILL BE PROVIDED.

REFER TO ESD CONSULANTS DOCUMENTATION FOR FULL DETAILS

No. Date Description 18.11.2022 Issued for Town Planning 15.03.2023 Issued for RFI Response

2 27.07.2023 Amended TP Submission

TOWN PLANNING NOT FOR CONSTRUCTION

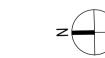



Kerstin Thompson Architects Pty Ltd 277 Queensberry St, Melbourne Australia 3000 T +61 3 8662 8800 kta@kerstinthompson.com www.kerstinthompson.com

DRAWING TITLE TOWNHOUSE PLANS - TYPE C1


97 Alma Road


AT St Kilda East Neometro


DATE 27.07.2023 JL/TM/LG SCALE PROJECT TP6.7 As indicated(A1) 2202



City of Port Phillip Advertised Plan Planning Application No. PDPL/00823/2022 No. of Pages: 44 of 50

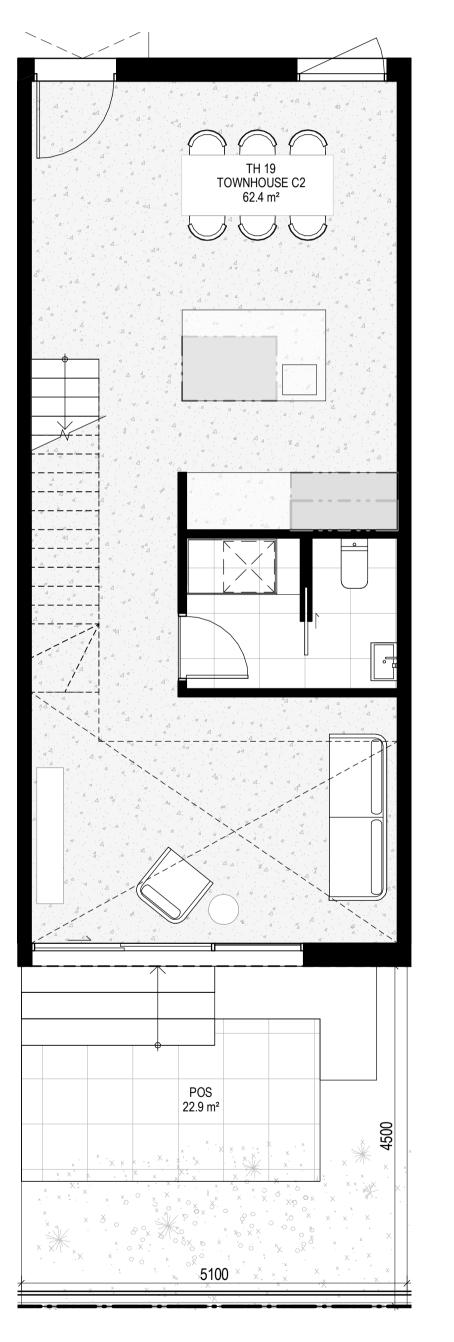

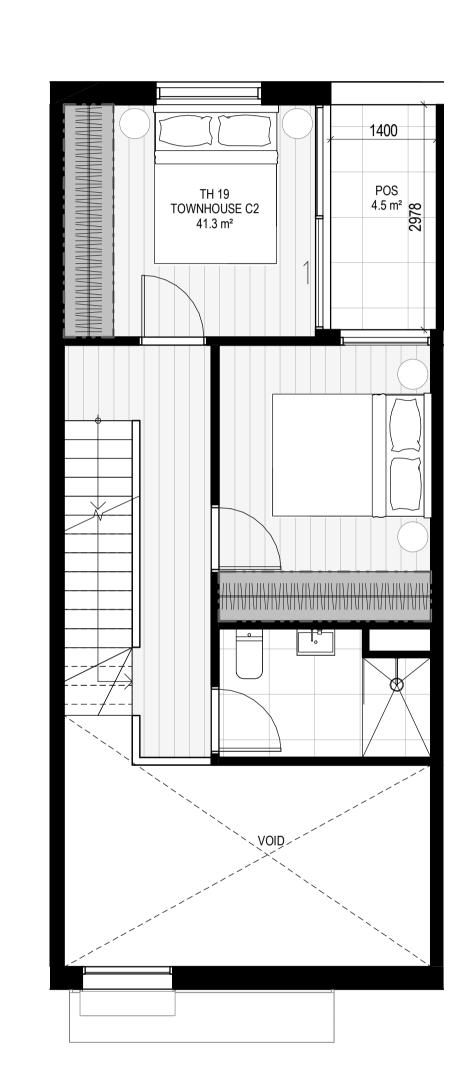

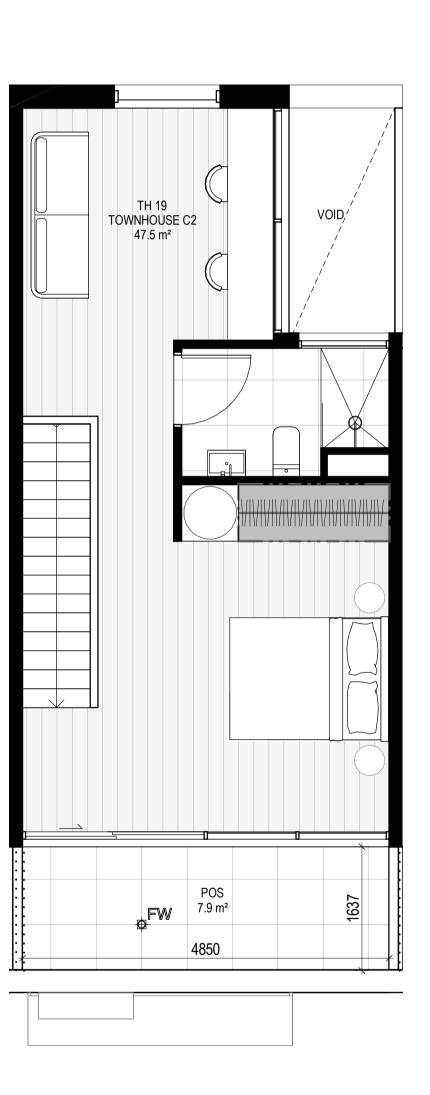

LEVEL 1 LEVEL 2 LEVEL GROUND

TH TYPE C2 TYPE TOWNHOUS TOWNHOUS TOWNHOUS TOWNHOUS TOWNHOUS

INTERNAL STORAGE TH-19

KITCHEN

TOTAL INTERNAL STORAGE

4.8 m³ 4.4 m³

3.6 m³

0.8 m³

0.8 m³

 0.4 m^3

TOWNHOUSE C2	12	TYPE	LOCATION
TOWNHOUSE C2	13		
TOWNHOUSE C2	14	TH 19	BEDROOM
TOWNHOUSE C2	15	TH 19	BEDROOM
TOWNHOUSE C2	16	TH 19	BEDROOM
TOWNHOUSE C2	17	TH 19	KITCHEN
TOWNHOUSE C2	18	TH 19	KITCHEN
TOWNHOUSE C2	19	TH 19	KITCHEN

_GENERAL NOTES

SURVEY: EXISTING SITE INFORMATION IS TAKEN FROM VERIS SURVEY NUMBER 303981-BG DATED 06/07/2023 AND IS PROVIDED HERE FOR ILLUSTRATIVE PURPOSES ONLY. FOR FULL SURVEY DETAILS REFER TO SURVEY DOCUMENTS PROVIDED WITHIN APPENDICIES.

LANDSCAPE DESIGN: LANDSCAPE DESIGN IS SHOWN INDICATIVELY. FOR FULL LANDSCAPE DETAILS REFER TO LANDSCAPE ARCHITECT'S



DOCUMENTATION.

EXISTING TREE WITHIN PROJECT BOUNDARY TO BE RETAINED. TREE NUMBER, TPZ AND CANOPY AS PER ARBORIST REPORT

ABBREVIATIONS: AC CONDENSER UNIT
CL CLOTHES LINE
ELEC ELECTRICAL SERVICES HYDR HYDRAULIC SERVICES

COM COMMS SERVICES FCL FINISHED CEILING LEVEL
FFL FINISHED FLOOR LEVEL
FHR FIRE HOSE REEL FHY FIRE HYDRANT
FIP FIRE INDICATOR PANEL

FW FLOOR WASTE NGL NATURAL GROUND LEVEL RELATIVE LEVEL WATER TAP HW HOT WATER UNIT

OW OPERABLE WINDOW

__ MATERIALS

HEAT PUMP HOT WATER UNIT

BR1 BRICK WORK - BAGGED TEXTURE FINISH
BR2 BREEZE BLOCK
FC1 PAINTED FIBRE CEMENT SHEET

TL1 EXTERNAL TILE SC1 SUN SHADESCREEN

MT1 VERTICAL ALUMINIUM BALUSTRADE MT2 GLAVANISED STEEL CLADDING MT3 METAL PERGOLA

GL1 GLAZING - DOUBLE CLEAR
GL2 OBSCURE GLAZING - REEDED

MS1 CABLE MESH MS2 MESH FENCING

MS3 MESH SCREEN

AS1 ACOUSTIC WALL PANEL SR1 SAFETY GUARD RAIL

ESD:

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5. 39% (16 OUT OF 41) OF APARTMENTS ACHIEVE AT LEAST 3 HOURS OF SUNLIGHT.

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ENERGY RATING RESULT FOR THE TOWNHOUSES.

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14. A 32,000-LITRE RAINWATER TANK AND A 30,000-LITRE RAINWATER TANK WILL HARVEST RAINWATER FROM THE APARTMENT ROOF AND TOWNHOUSE ROOFS RESPECTIVELY. THESE TANKS WILL BE CONNECTED TO ALL TOILETS.

15. A MELBOURNE STORM RATING OF 102% IS ACHIEVED.

16. ALL LANDSCAPING IS TO BE NATIVE SPECIES OR LANDSCAPING IRRIGATION IS TO BE CONNECTED TO THE RAINWATER TANK ONLY.

17. IN TOTAL 62 BICYCLE SPACES ARE TO BE PROVIDED FOR RESIDENTS.

18. IN TOTAL 2 BICYCLE SPACES ARE TO BE PROVIDED FOR RESIDENTIAL AND NON-RESIDENTIAL VISITORS.

20. ONE CHARGING POINT FOR ELECTRICAL VEHICLES IS INTEGRATED IN THE PROPOSED DEVELOPMENT.


21. 1414 20 F COMMUNAL FOOD PRODUCTION AREA WILL BE PROVIDED.

REFER TO ESD CONSULANTS DOCUMENTATION FOR FULL DETAILS

No. Date Description

18.11.2022 Issued for Town Planning 15.03.2023 Issued for RFI Response 2 27.07.2023 Amended TP Submission

TOWN PLANNING NOT FOR CONSTRUCTION

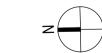

_KTA

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DRAWING TITLE TOWNHOUSE PLANS - TYPE C2


PROJECT 97 Alma Road


AT St Kilda East Neometro

DATE | DRAWN BY | DRAWING NO | 27.07.2023 | JL/TM/LG | SCALE | PROJECT | TP6

As indicated(A1) 2202

City of Port Phillip Advertised Plan Planning Application No. PDPL/00823/2022 No. of Pages: 45 of 50

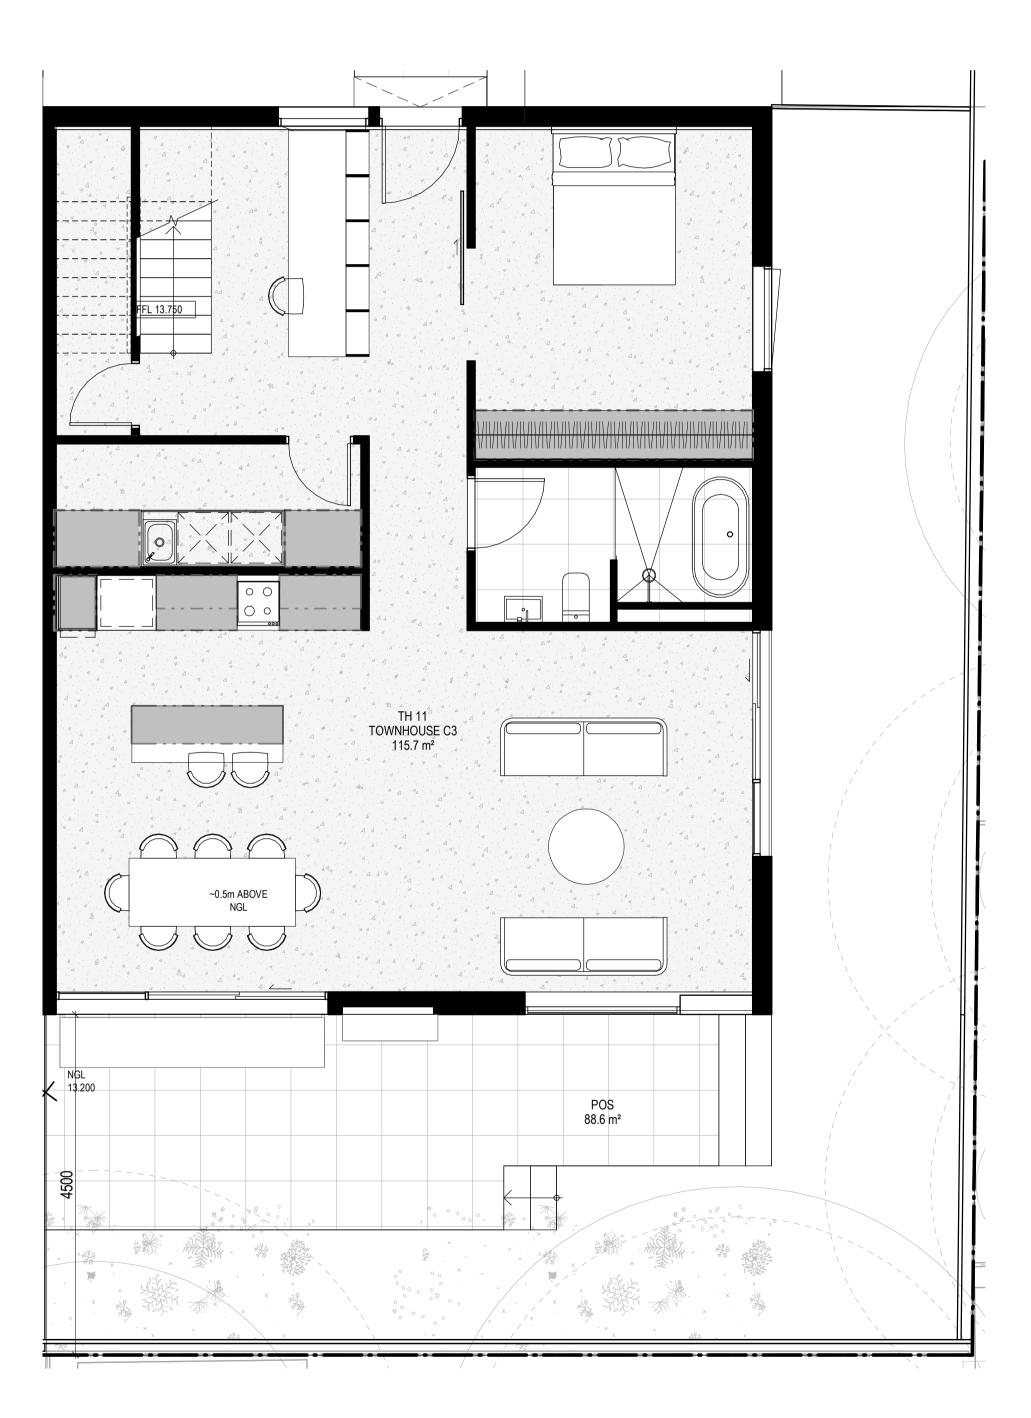

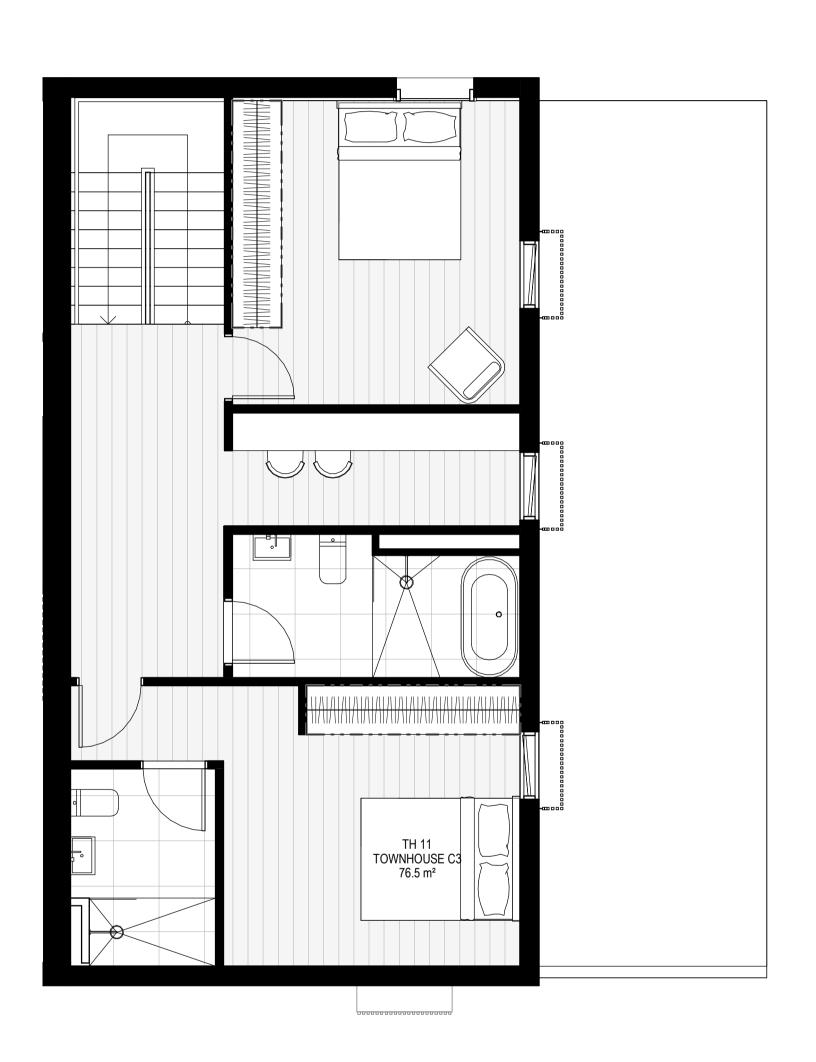


INTERNAL STORAGE TH-11

TYPE	LOCATION	VOLUME
TH 11	BEDROOM	5.7 m³
TH 11	BEDROOM	4.7 m³
TH 11	BEDROOM	4.4 m³
TH 11	KITCHEN	0.4 m³
TH 11	KITCHEN	0.4 m³
TH 11	KITCHEN	0.8 m³
TH 11	KITCHEN	0.6 m³
TH 11	KITCHEN	0.6 m³
TH 11	KITCHEN	1.0 m³
TH 11	LAUNDRY	1.8 m³
TH 11	LAUNDRY	2.0 m³
TOTAL INTERNAL	STORAGE	22.3 m³

GENERAL NOTES

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DOCUMENTATION.

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ABBREVIATIONS: AC CONDENSER UNIT CL CLOTHES LINE

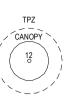COM COMMS SERVICES FCL FINISHED CEILING LEVEL FFL FINISHED FLOOR LEVEL FHR FIRE HOSE REEL FHY FIRE HYDRANT
FIP FIRE INDICATOR PANEL FW FLOOR WASTE

ELEC ELECTRICAL SERVICES HYDR HYDRAULIC SERVICES

NATURAL GROUND LEVEL RELATIVE LEVEL WATER TAP HOT WATER UNIT HEAT PUMP HOT WATER UNIT

OW OPERABLE WINDOW

__ MATERIALS

BR1 BRICK WORK - BAGGED TEXTURE FINISH BR2 BREEZE BLOCK

PAINTED FIBRE CEMENT SHEET TL1 EXTERNAL TILE SC1 SUN SHADESCREEN

MT1 VERTICAL ALUMINIUM BALUSTRADE MT2 GLAVANISED STEEL CLADDING MT3 METAL PERGOLA

GL1 GLAZING - DOUBLE CLEAR
GL2 OBSCURE GLAZING - REEDED CABLE MESH MS2 MESH FENCING

MS3 MESH SCREEN AS1 ACOUSTIC WALL PANEL SR1 SAFETY GUARD RAIL

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15. A MELBOURNE STORM RATING OF 102% IS ACHIEVED.

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17. IN TOTAL 62 BICYCLE SPACES ARE TO BE PROVIDED FOR RESIDENTS.

18. IN TOTAL 2 BICYCLE SPACES ARE TO BE PROVIDED FOR RESIDENTIAL AND NON-RESIDENTIAL VISITORS.

20. ONE CHARGING POINT FOR ELECTRICAL VEHICLES IS INTEGRATED IN THE PROPOSED DEVELOPMENT.

21. 141M2 OF COMMUNAL SPACE WILL BE PROVIDED AT THE ROOFTOP DECK.


22. 24M2 OF COMMUNAL FOOD PRODUCTION AREA WILL BE PROVIDED.

REFER TO ESD CONSULANTS DOCUMENTATION FOR FULL DETAILS

No. Date Description 18.11.2022 Issued for Town Planning 15.03.2023 Issued for RFI Response

2 27.07.2023 Amended TP Submission

TOWN PLANNING NOT FOR CONSTRUCTION

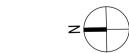

__KTA

Kerstin Thompson Architects Pty Ltd 277 Queensberry St, Melbourne Australia 3000 T +61 3 8662 8800 kta@kerstinthompson.com www.kerstinthompson.com

DRAWING TITLE TOWNHOUSE PLANS - TYPE C3

97 Alma Road

AT St Kilda East Neometro

DATE DRAWN BY 27.07.2023 JL/TM/LG DRAWING NO. TP672 2 As indicated(A1) 2202

LEVEL 1 LEVEL GROUND



CODE: BR1
MATERIAL: BRICK WORK
FINISH: BAGGED TEXTURE FINISH
LOCATION: EXTERNAL WALLS AS INDICATED



CODE: GL1 MATERIAL: DOUBLE GLAZING FINISH: CLEAR LOCATION: AS INDICATED



CODE: MS1 MATERIAL: CABLE MESH FINISH: STAINLESS STEEL LOCATION: BALCONIES



CODE: FC1
MATERIAL: THROUGH COLOURED FC SHEET
FINISH: PAINTED
COLOUR: LIGHT GREY
LOCATION: EXTERNAL WALLS AS INDICATED



CODE: GL2
MATERIAL: OBSCURE GLAZING
PROFILE: REEDED
LOCATION: AS INDICATED




CODE: MT3


MATERIAL: METAL PERGOLA

FINISH: POWDERCOAT FINISH

LOCATION: ROOF TERRACES

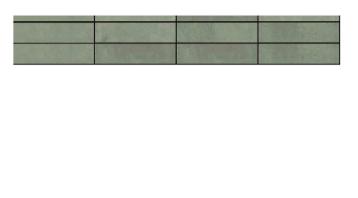

CODE: TL1 MATERIAL: CERAMIC TILE FINISH: PALE GREEN LOCATION: AS INDICATED

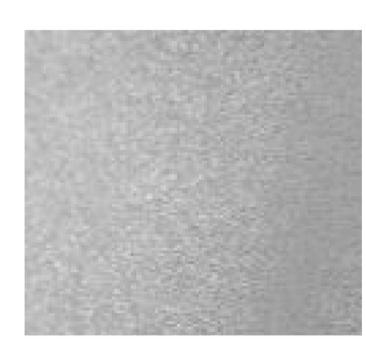

CODE: MT2
MATERIAL: GALVANISED STEEL CLADDING
LOCATION: AS INDICATED




CODE: AS1
MATERIAL: ACOUSTIC WALL PANELS
LOCATION: ROOF PLANTS



CODE: SC1 MATERIAL: SUN SHADE SCREEN FINISH: GREEN LOCATION: AS INDICATED



CODE: BR2 MATERIAL: BREEZE BLOCK FINISH: WHITE LOCATION: FENCING

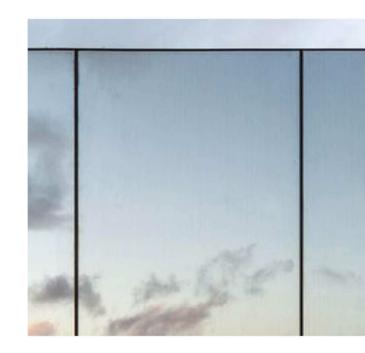


CODE:MR1 MATERIAL: LAMINATED MIRROR LOCATION: AS INDICATED



CODE: MT1
MATERIAL: VERTICAL ALUMINIUM BALUSTRADE
FINISH: SILVER GREY POWDERCOAT FINISH
LOCATION: BALCONY, VOID & STAIRS



CODE: MS2 MATERIAL: MESH FENCING LOCATION: AS INDICATED

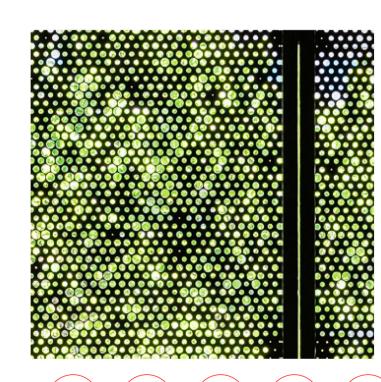

CODE: MS3 MATERIAL: MESH SCREENING LOCATION: AS INDICATED




0 18.11.2022 Issued for Town Planning 1 15.03.2023 Issued for RFI Response 2 27.07.2023 Amended TP Submission



Kerstin Thompson Architects Pty Ltd Wurundjeri Woi Wurrung Country 6 Lothian Steet North Melbourne VIC Australia 3051 ABN 31 067 225 487 T+61 3 8662 8800 kta@kerstinthompson.com www.kerstinthompson.com

97 ALMA ROAD MATERIALS

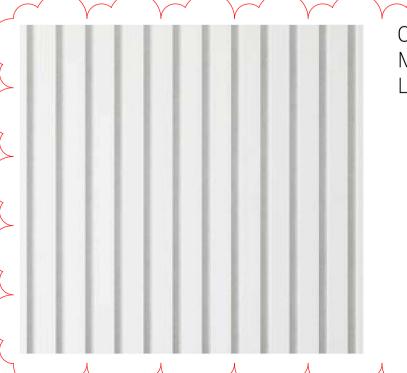

CODE: TM1

MATERIAL: WHITE PAINTED TIMBER

LOCATION: AS INDICATED


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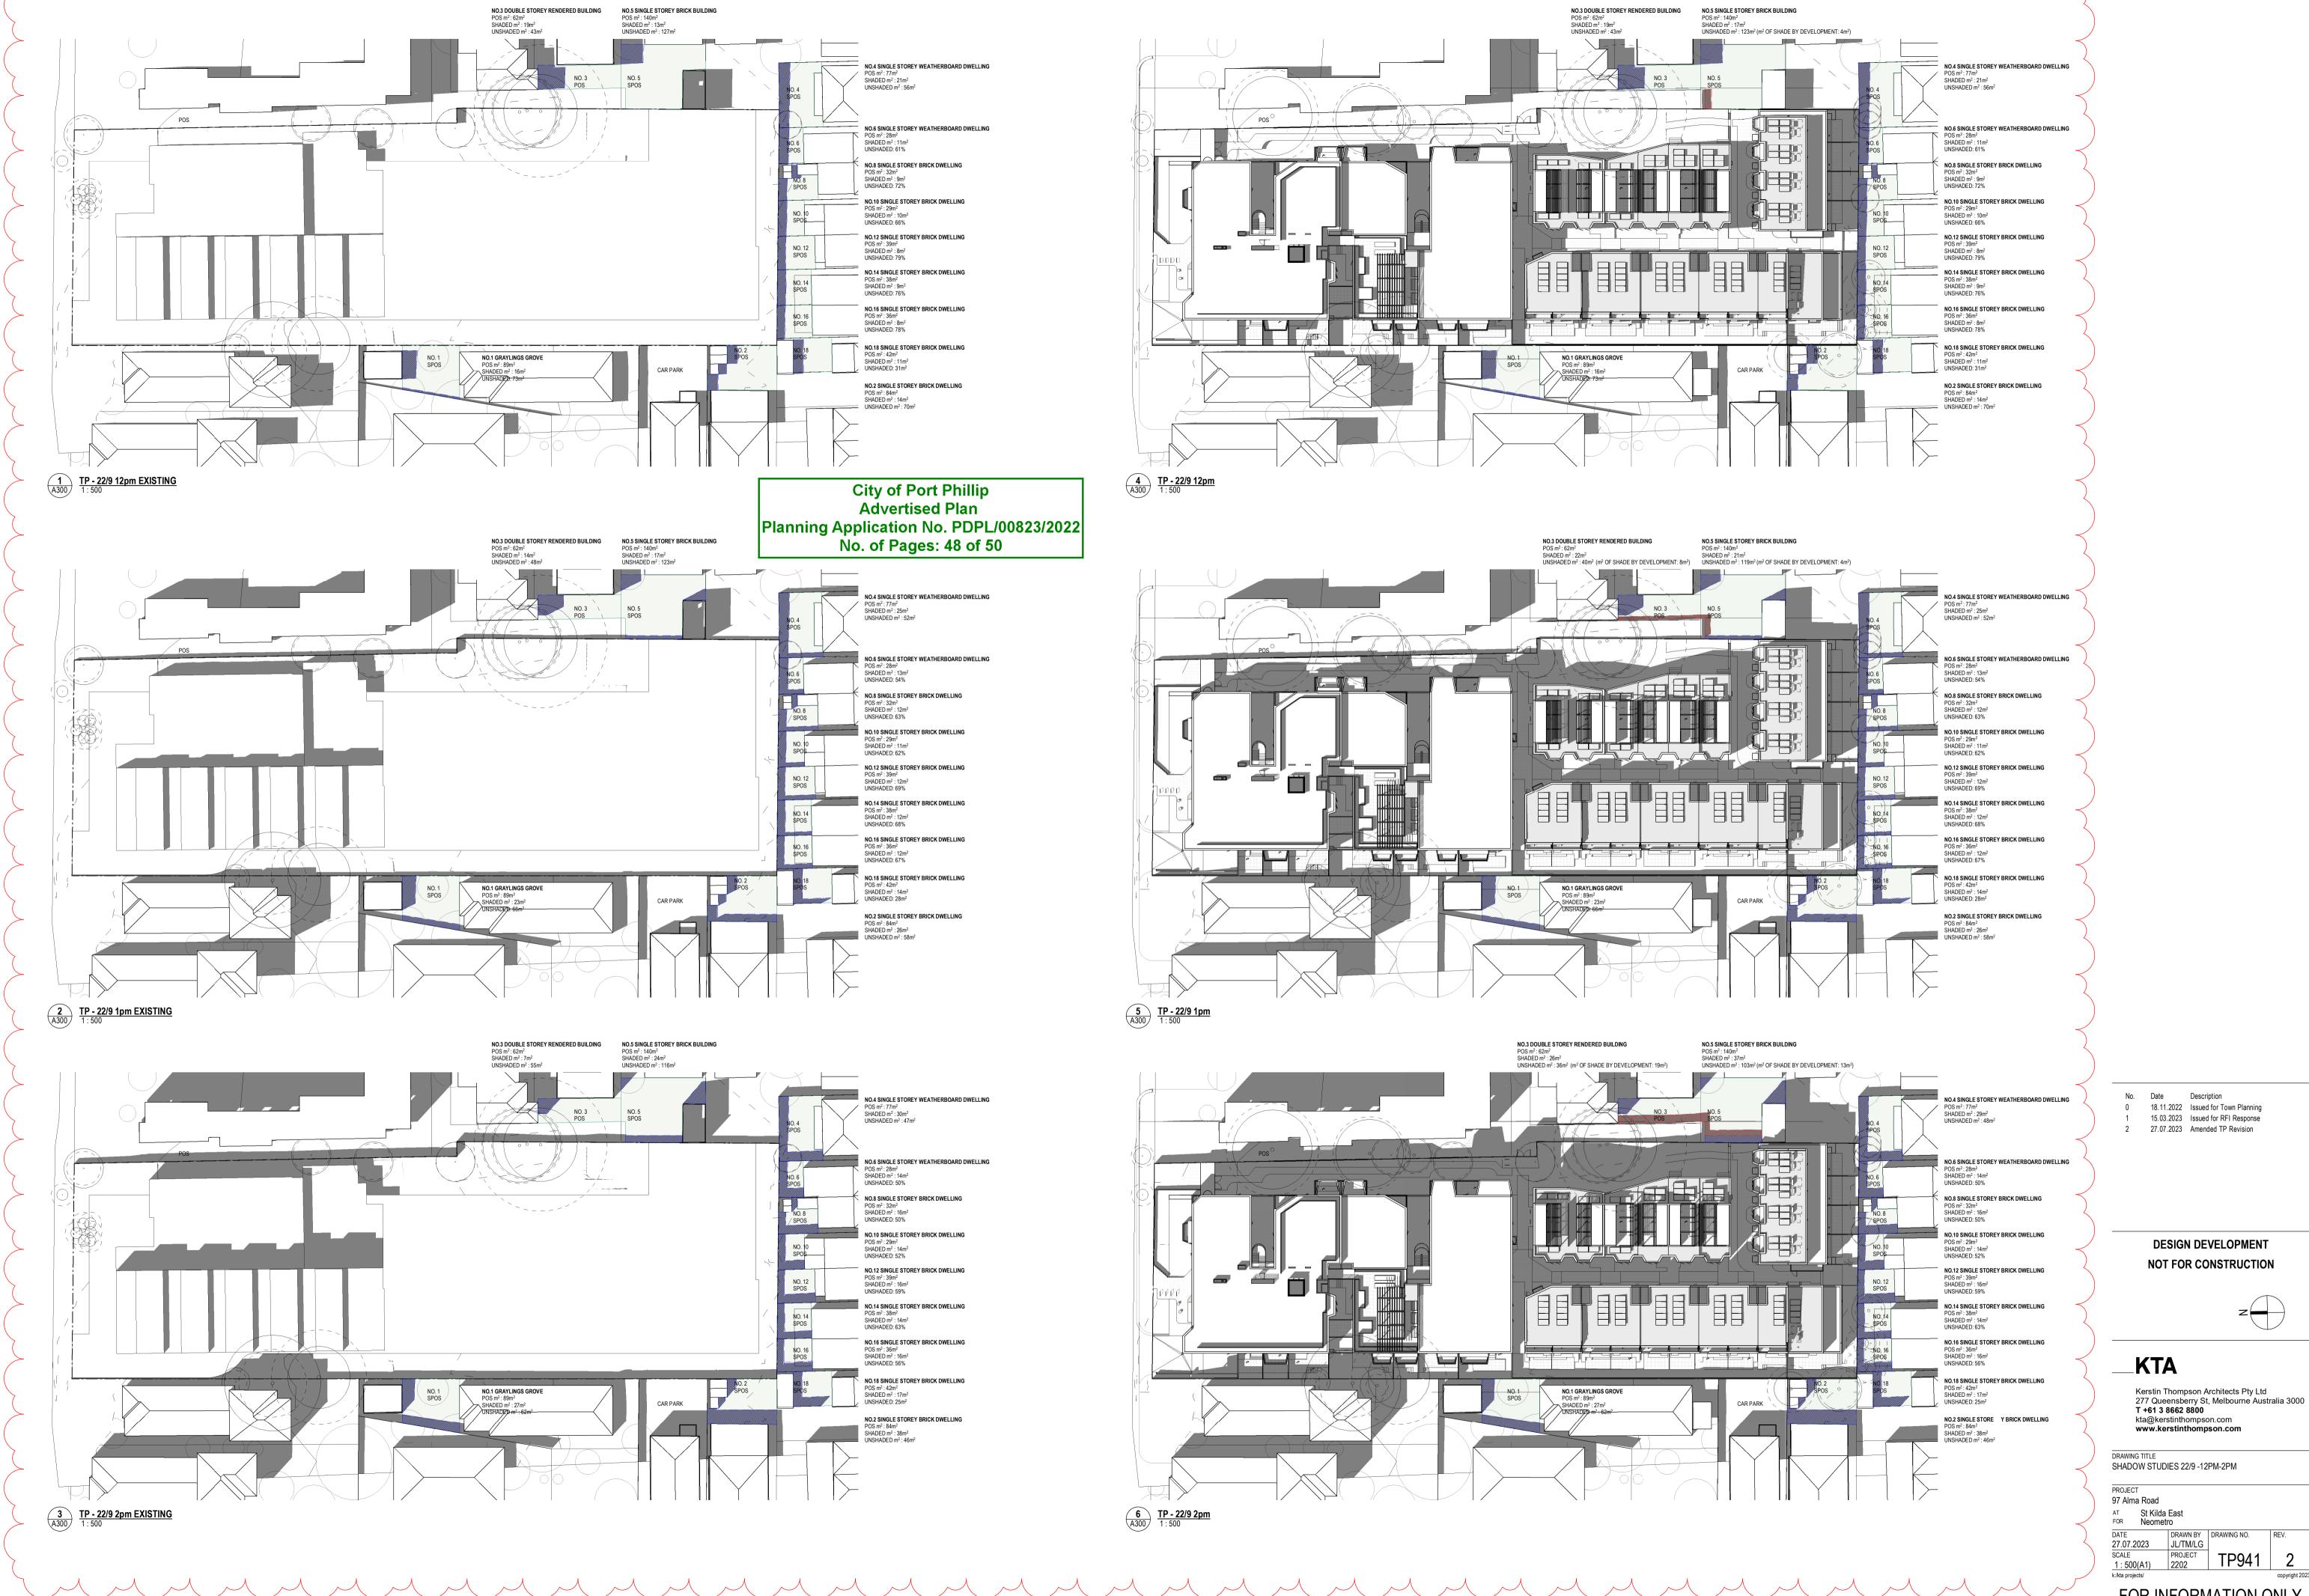
Kerstin Thompson Architects Pty Ltd 277 Queensberry St, Melbourne Australia 3000 **T +61 3 8662 8800** kta@kerstinthompson.com www.kerstinthompson.com


DRAWING TITLE
MATERIALS PALETTE

PROJECT
97 Alma Road

AT St Kilda East
FOR Neometro



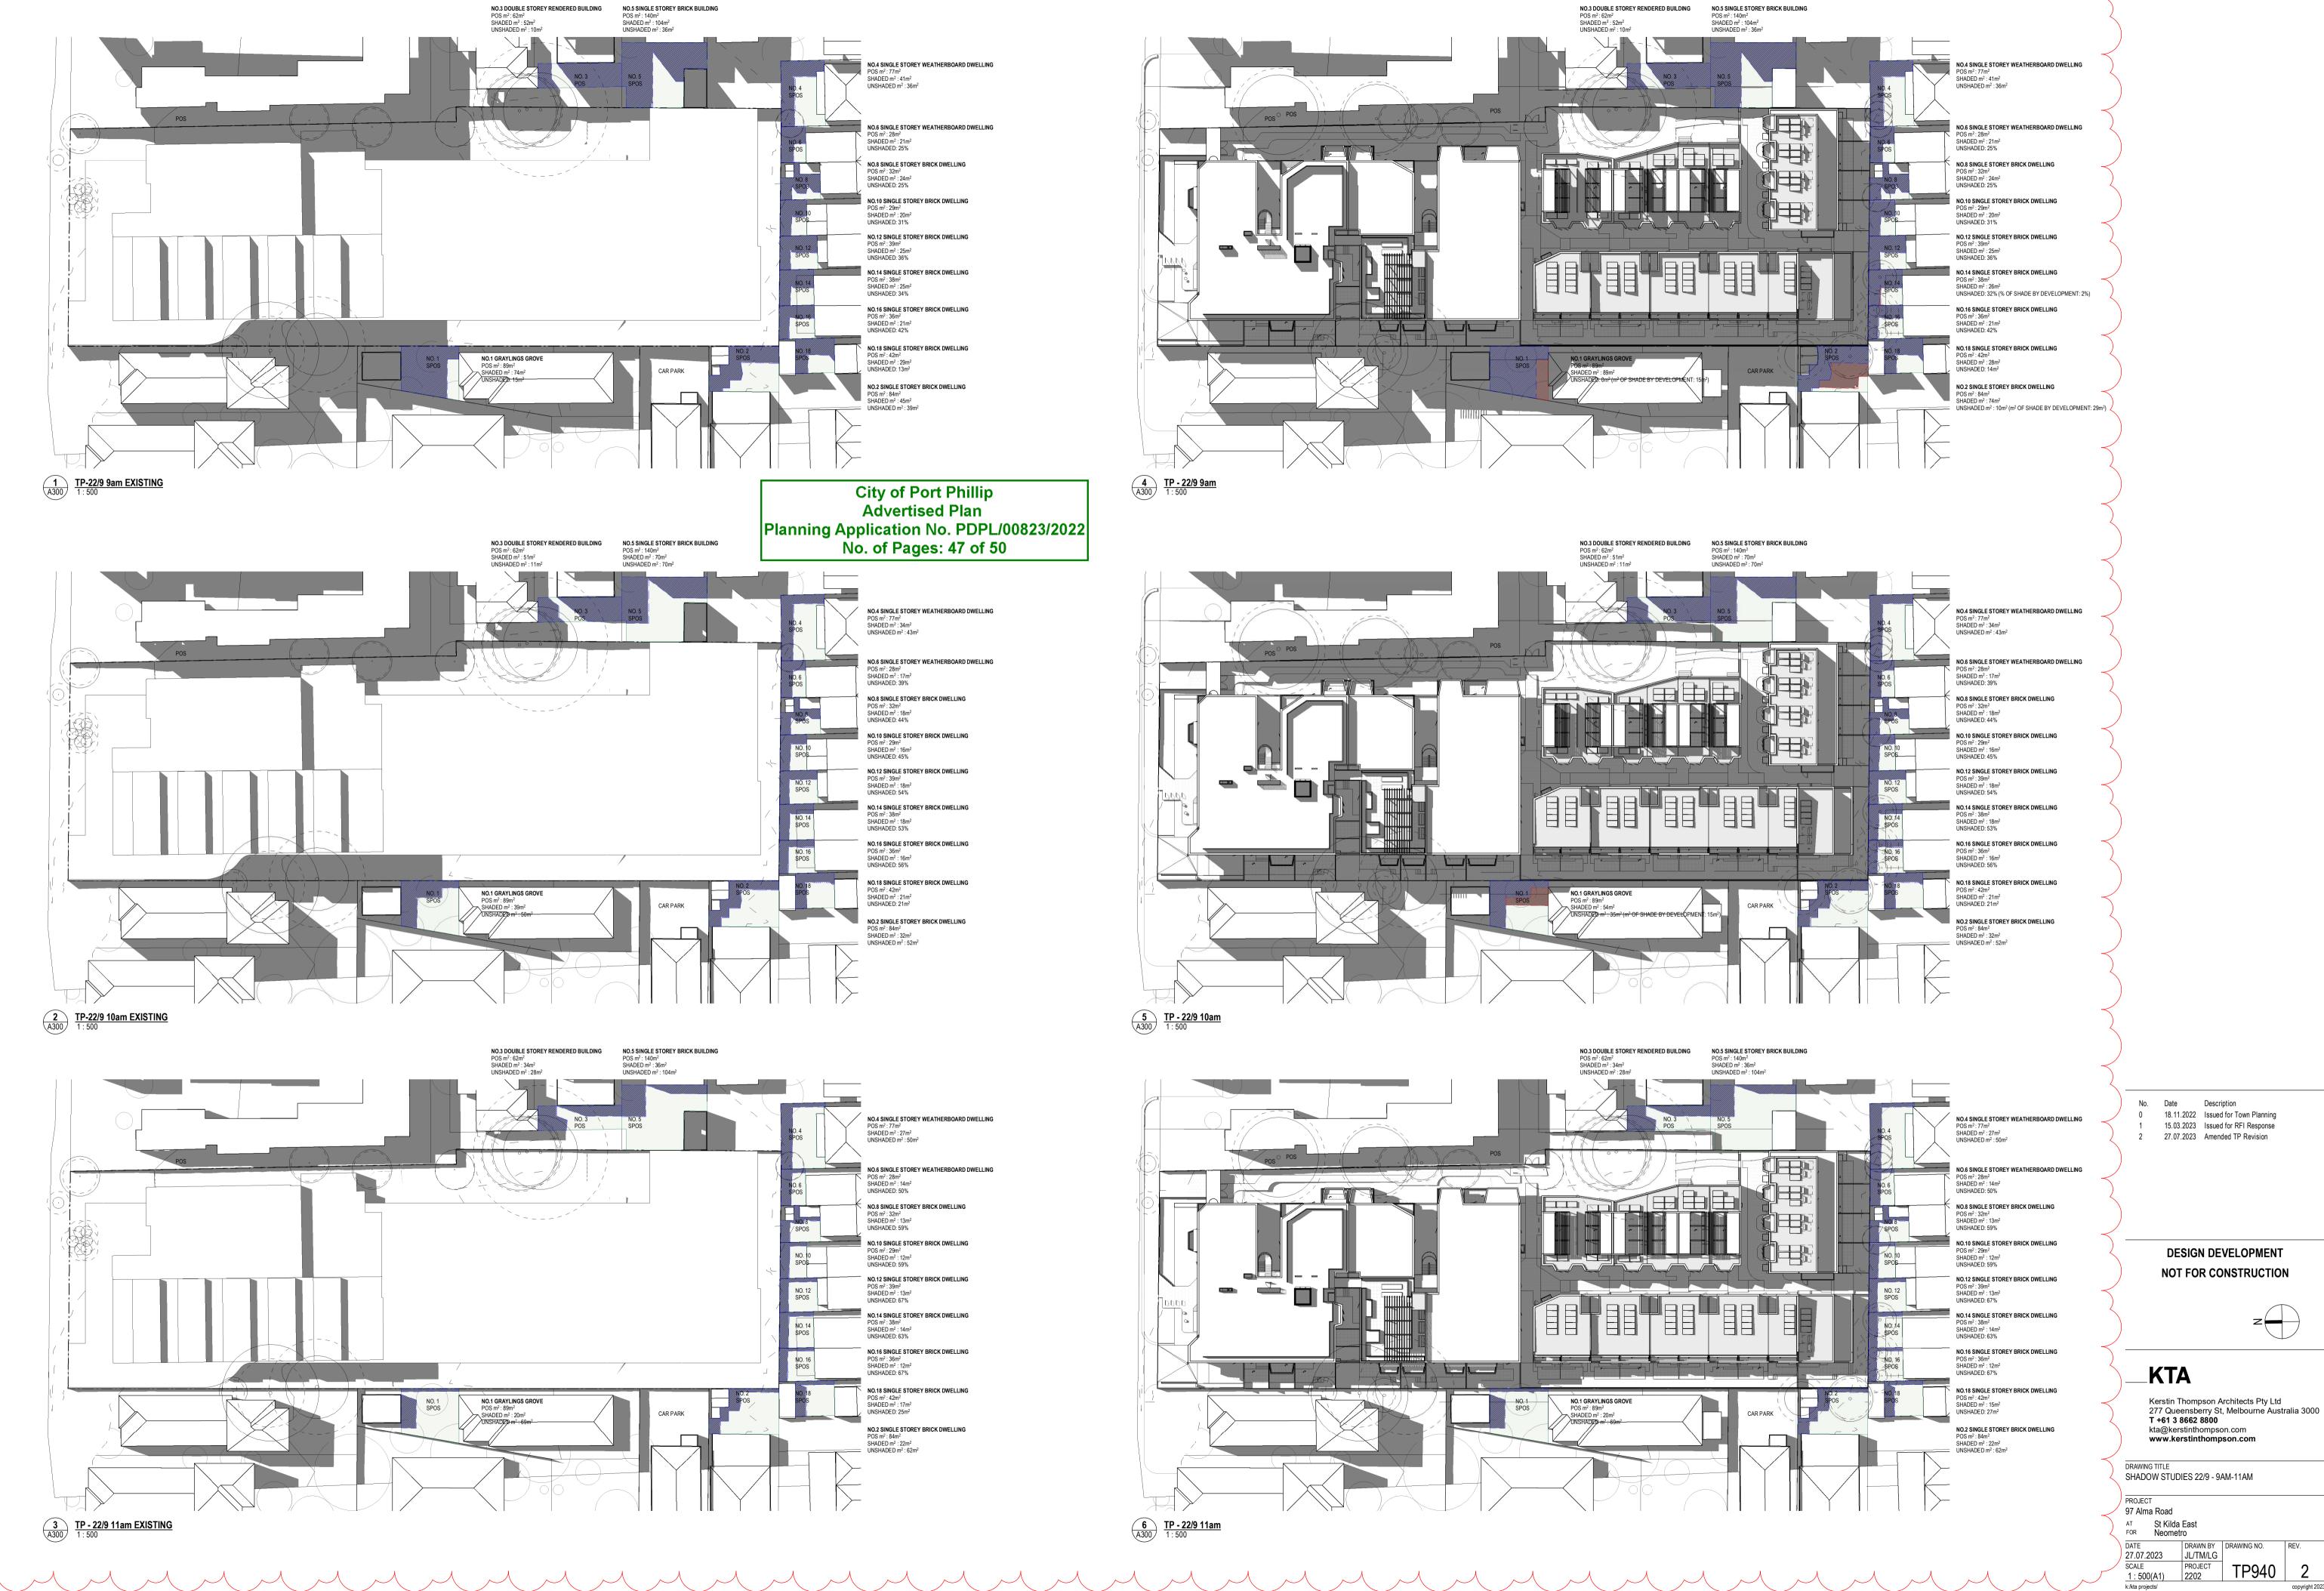


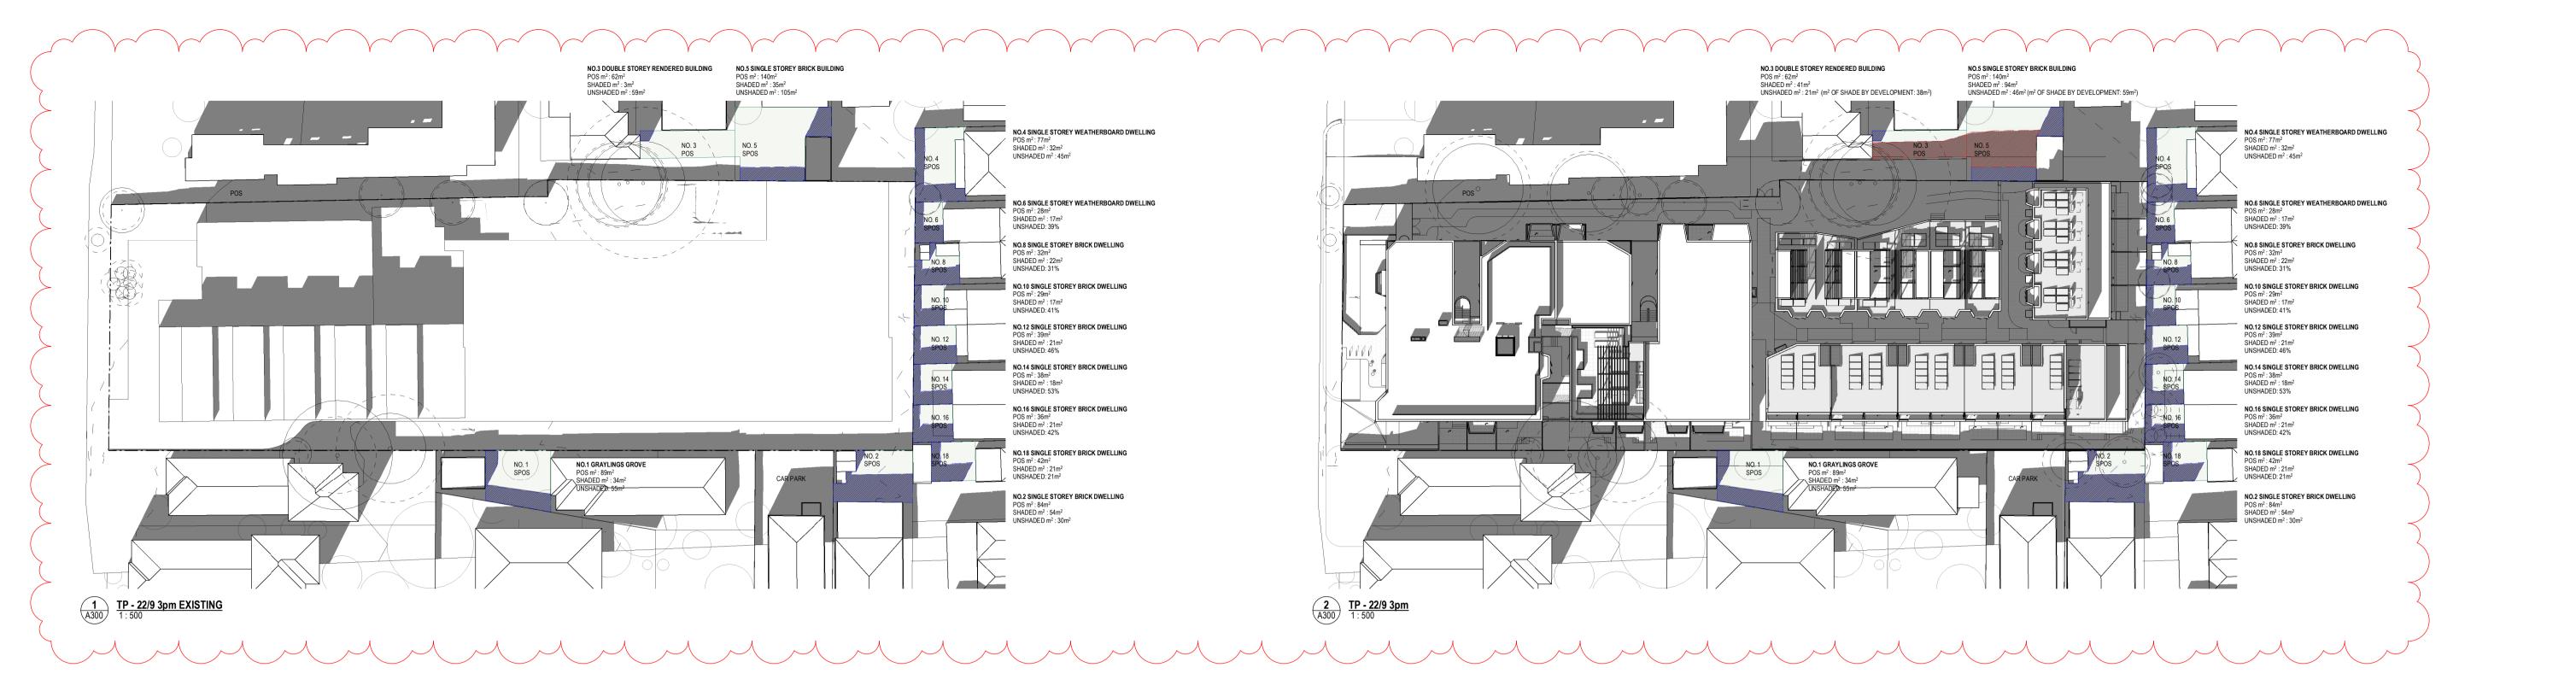

City of Port Phillip Advertised Plan Planning Application No. PDPL/00823/2022 No. of Pages: 49 of 50



DESIGN DEVELOPMENT
NOT FOR CONSTRUCTION

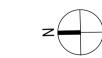

__KTA

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 DRAWING TITLE

 SHADOW STUDIES 22/9 - 3PM

 PROJECT

 97 Alma Road

 AT St Kilda East

 FOR Neometro


 DATE Neometro

 DRAWN BY 27.07.2023
 JL/TM/LG

 SCALE PROJECT 1: 500(A1)
 PROJECT 2202


 k:/kta projects/
 TP942

 Copyright 2

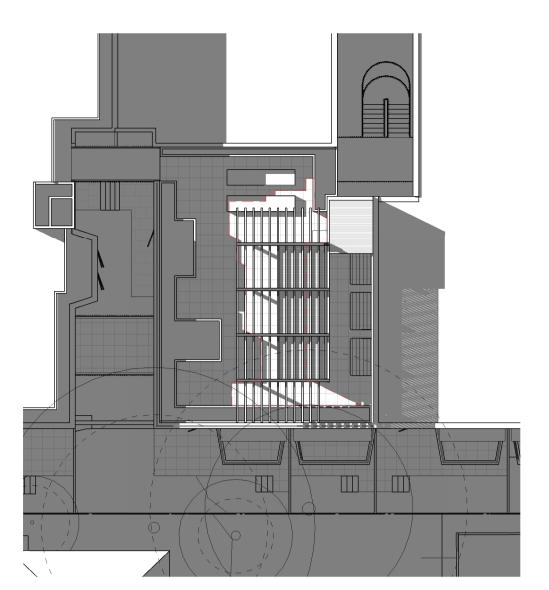

1 TP - 21/6 10am
1:200

ROOFTOP DECK: 140m²
UNSHADED AREA: ~42m² (29

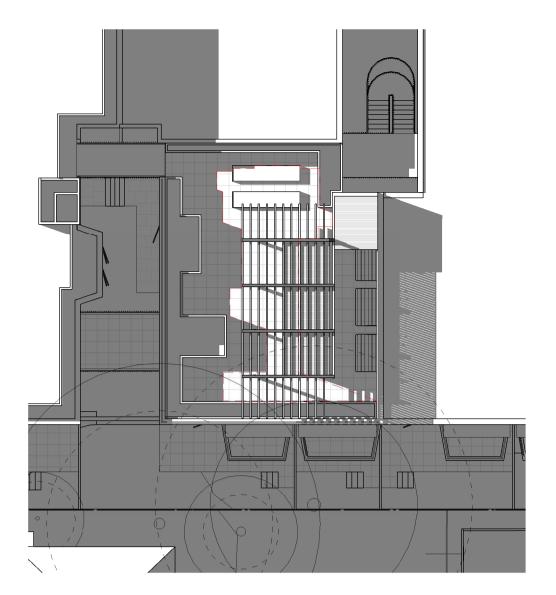


City of Port Phillip Advertised Plan


Planning Application No. PDPL/00823/2022 No. of Pages: 50 of 50

A300 TP - 21/6 10.30am
1: 200

ROOFTOP DECK: 140m²

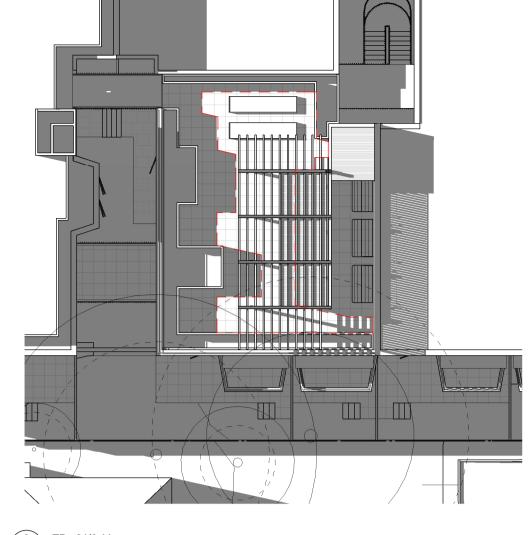


3 A300 TP - 21/6 11am 1 : 200 ROOFTOP DECK: 140m² UNSHADED AREA: -53m² (37%)

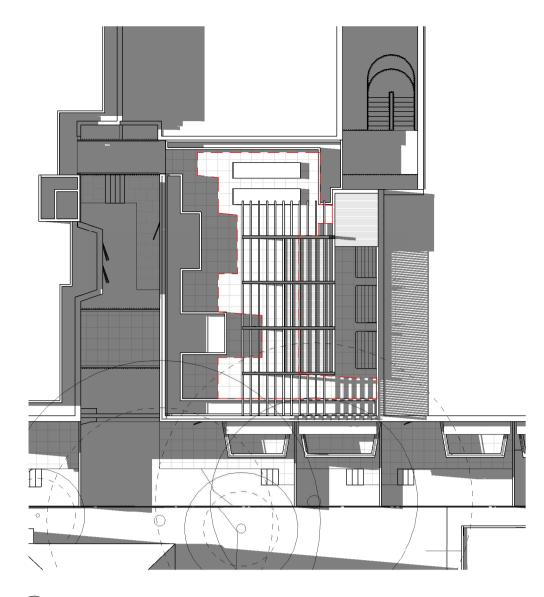


A300 TP - 21/6 11.30am
1:200

ROOFTOP DECK: 140m²

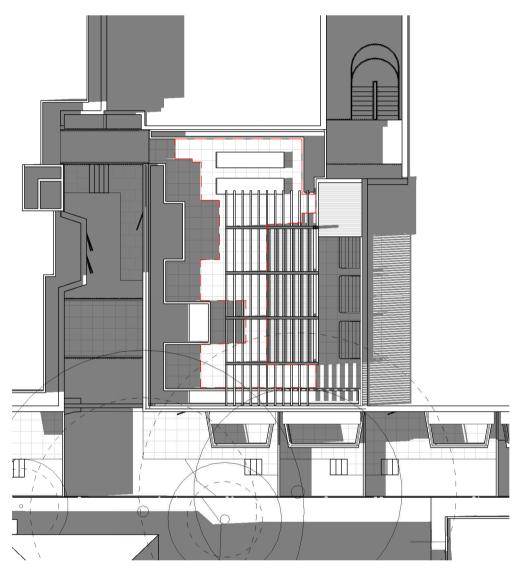


5 A300 TP - 21/6 12pm 1: 200 ROOFTOP DECK: 140m² UNSHADED AREA: ~50m² (35%)

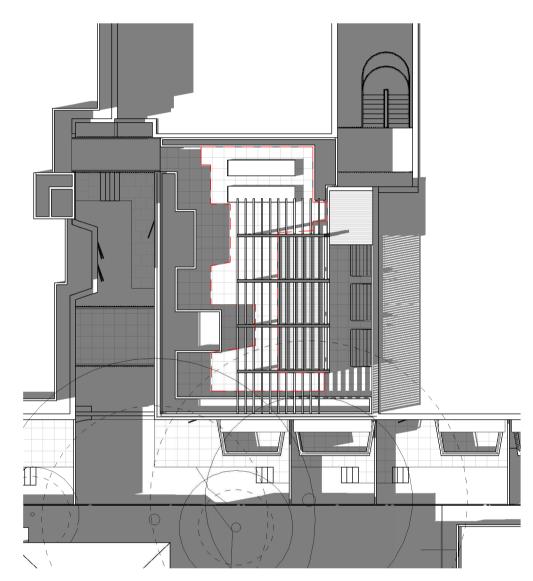


A300 TP - 21/6 12.30pm
1: 200


ROOFTOP DECK: 140m²
UNSHADED AREA: ~48m² (34%)

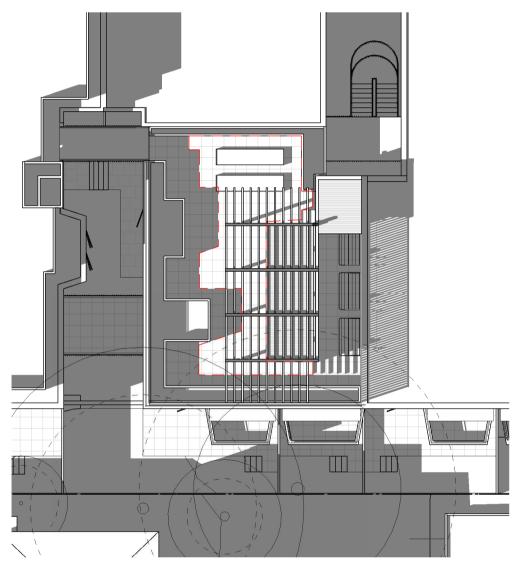


7 A300 TP - 21/6 1pm 1:200 ROOFTOP DECK: 140m² UNSHADED AREA: ~46m² (32%)

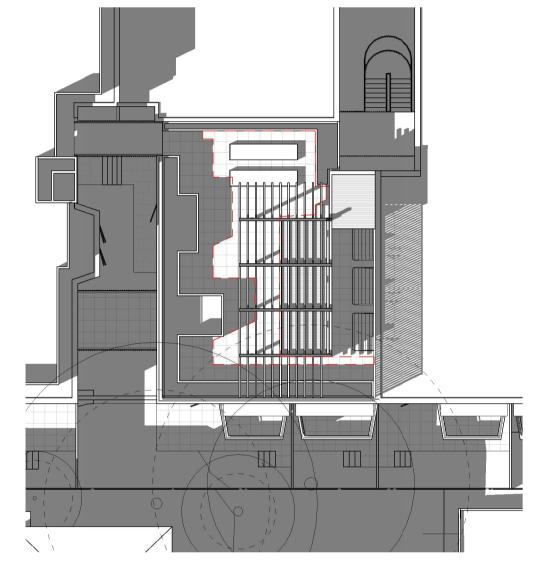

8 A300 TP - 21/6 1.30pm 1:200 ROOFTOP DECK: 140m² UNSHADED AREA: ~44m² (31%)

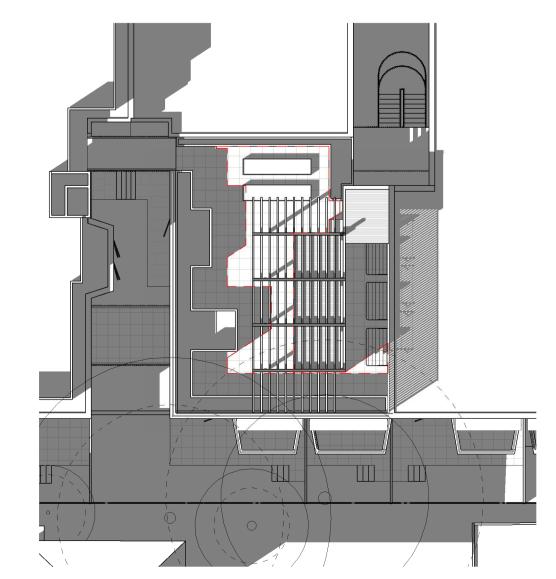

9 A300 TP - 21/6 2pm 1:200 ROOFTOP DECK: 140m² UNSHADED AREA: ~42m² (29%)

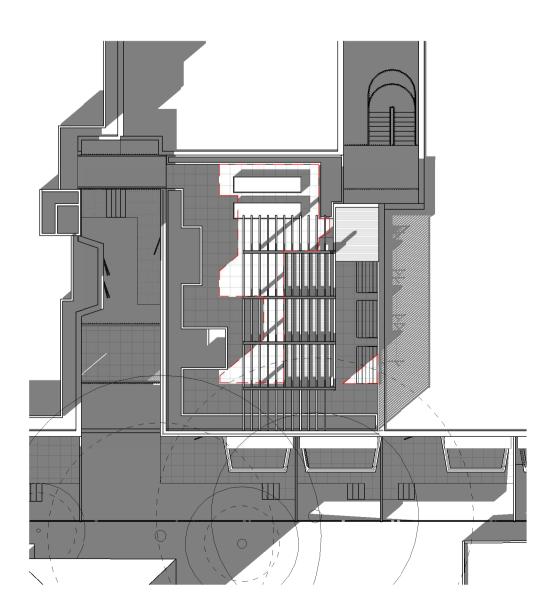


10 TP - 21/6 2.30pm
1:200

ROOFTOP DECK: 140m²
UNSHADED AREA: ~48m² (34%)



No. Date Description

0 18.11.2022 Issued for Town Planning
1 15.03.2023 Issued for RFI Response
2 27.07.2023 Amended TP Revision

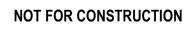



__KTA

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DRAWING TITLE
SHADOW STUDIES OF PROPOSED COS ROOF
TERRACE 21/6 - 10AM-2.30PM
PROJECT

97 Alma Road

AT St Kilda East

FOR Neometro

DATE 27.07.2023 JL/TM/LG SCALE PROJECT 1: 200(A1) 2202 TP950