

development summary 12.08.2022 223 rouse street, port melbourne

site area 203m2

proposed apartments 7

proposed car spaces 8

indoor

area schedule car spaces recreation (m2) apt area (m2) terrace area (m2) common area (m2) 2 bed apt. 3 bed apt.

basement 0 0 0 0 0 128 0 0

ground 8 52 0 0 0 102 0 0

first 0 0 0 154 20 25 2 0

second 0 0 154 20 25 2 0

third 0 0 0 130 19 18 0 1

fourth 0 0 0 130 19 18 0 1

fifth 0 0 0 130 19 18 0 1

fifth 0 0 0 78 0 0 0

City of Port Phillip
Advertised Plan
Planning Application No. PDPL/01407/2021
No. of Pages: 1 of 25

# 223 Rouse Street, Port Melbourne VIC Apartment Development

Town Planning August 2022 JAM>rchitects

### Town Planning

Dwg No. TP

Project No. 2123

Revision

e 18/8/2022

**Project** Apartment Development

Address 223 Rouse Street, Port

Melbourne VIC

Client JGK Investments Pty Ltd

Note

This drawing is based on preliminary information and requires further advice from professional consultants and is subject to approval from the relevant statutory authorities
Floor Areas shown are generally measured using the guidelines "Method of Measurement for Residential Property" - published by the Property Council of Australia
All Areas and Measurements are shown to the nearest whole number
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### Drawings

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TP 25 Copy of Survey (by others)

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226-242 Rouse Street - 6 storey apartment building with 3 podium levels opposite subject site



222-224 Rouse Street - 6 storey apartment building with 3 podium levels opposite subject site



DONALDSON

STREET



view of Rouse Street street parking to both sides of road

and mature trees in median nature strip

215 Rouse Street - 2 storey building

warm northerly winds

traffic noise



200 Rouse Street - 6 storey apartment building with 3 podium levels



233 Rouse Street - 3 storey building



laneway behind subject site





Advertised Plan

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Notes

Donaldson street beside subject site

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cold southerly winds

BRICK HOUSE

Client	t JGK Investments Pty Ltd				
Date	18/8/2022	Drawn			

TP**02** Dwg No. Project No. Revision

217 Rouse Street - 2 storey building directly beside



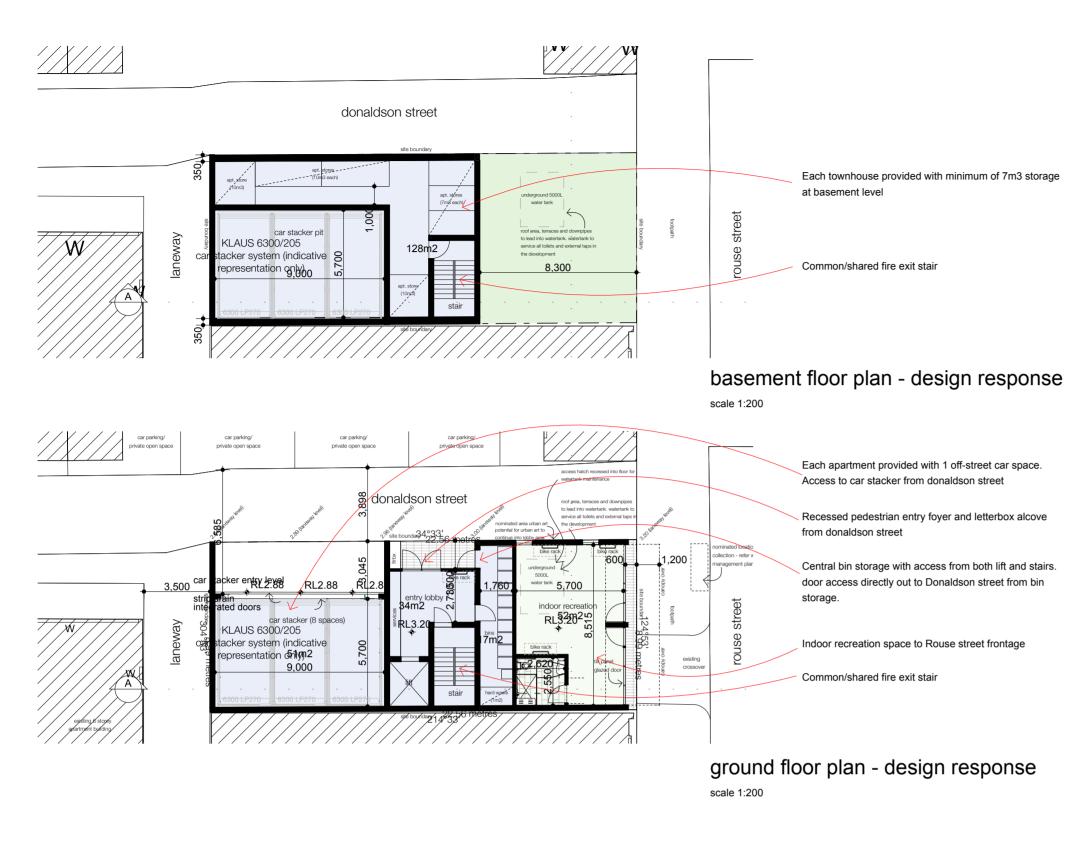
199-203 Rouse Street - 6 storey apartment building with 3 podium

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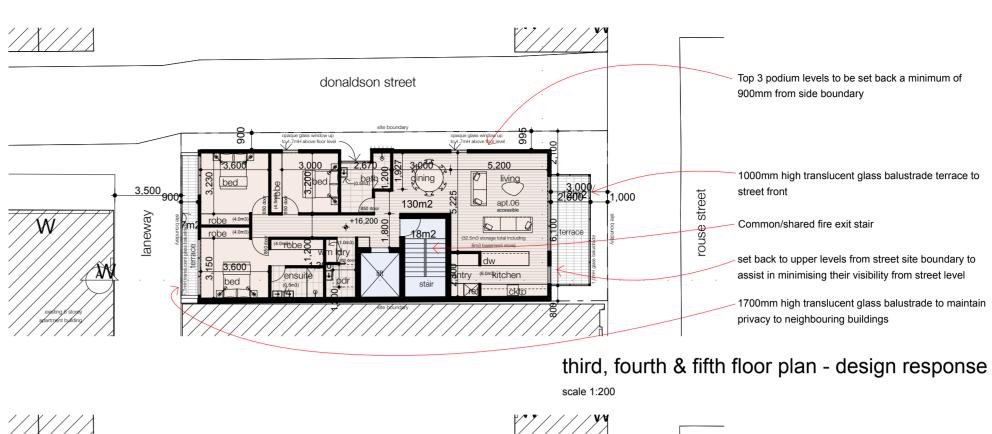
Document Set ID: 6494032 Version: 2, Version Date: 02/09/2022






Address





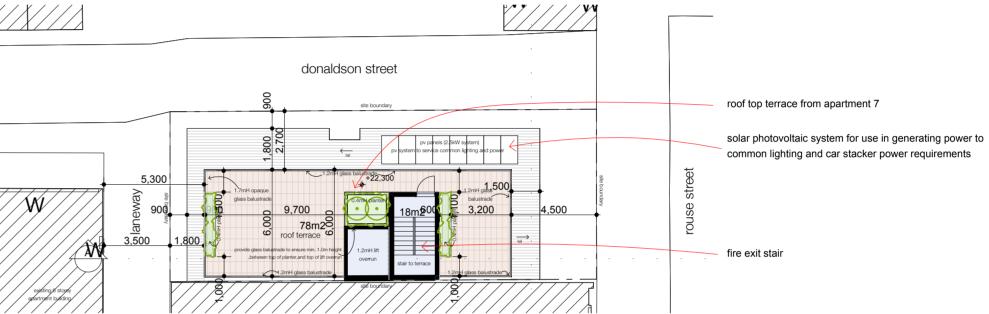

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advice from professional consultants and is subject to approval from the

max illumination power density (W/m2) of the development meets the requirements in NCC 2019

Indoor Energy Quality: Glazing in apartments to have minimum VLT of 60%
Transport: 4 secured bike racks provided for residents and visitors on ground floor
Waste: Three bin system including rubbish, recycling and organic/garden waste

average 6.5 star energy rating across development

Lighting sensors to all external lighting CO sensors for car park ventilation

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donaldson street site boundary (10m3) underground 5000L apt. stóres (7m/3 each) water tank rouse street roof area, terraces and downpipes car stacker pit laneway KLAUS 6300/205 car stacker system (indicative to lead into watertank. watertank to representation only) the development

Notes

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Address Apartment Development

223 Rouse Street, Port Melbourne VIC

basement floor plan

Client JGK Investments Pty Ltd

Date 18/8/2022 Drawn

Dwg No. TPO4

Project No. 2123 Revision

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<u>General Notes</u> WELS rating for fittings and fixtures to be minimum 5 star

Energy Efficiency:


average 6.5 star energy rating across development

max illumination power density (W/m2) of the development meets the requirements in NCC 2019

Lighting sensors to all external lighting CO sensors for car park ventilation

Indoor Energy Quality: Glazing in apartments to have minimum VLT of 60%

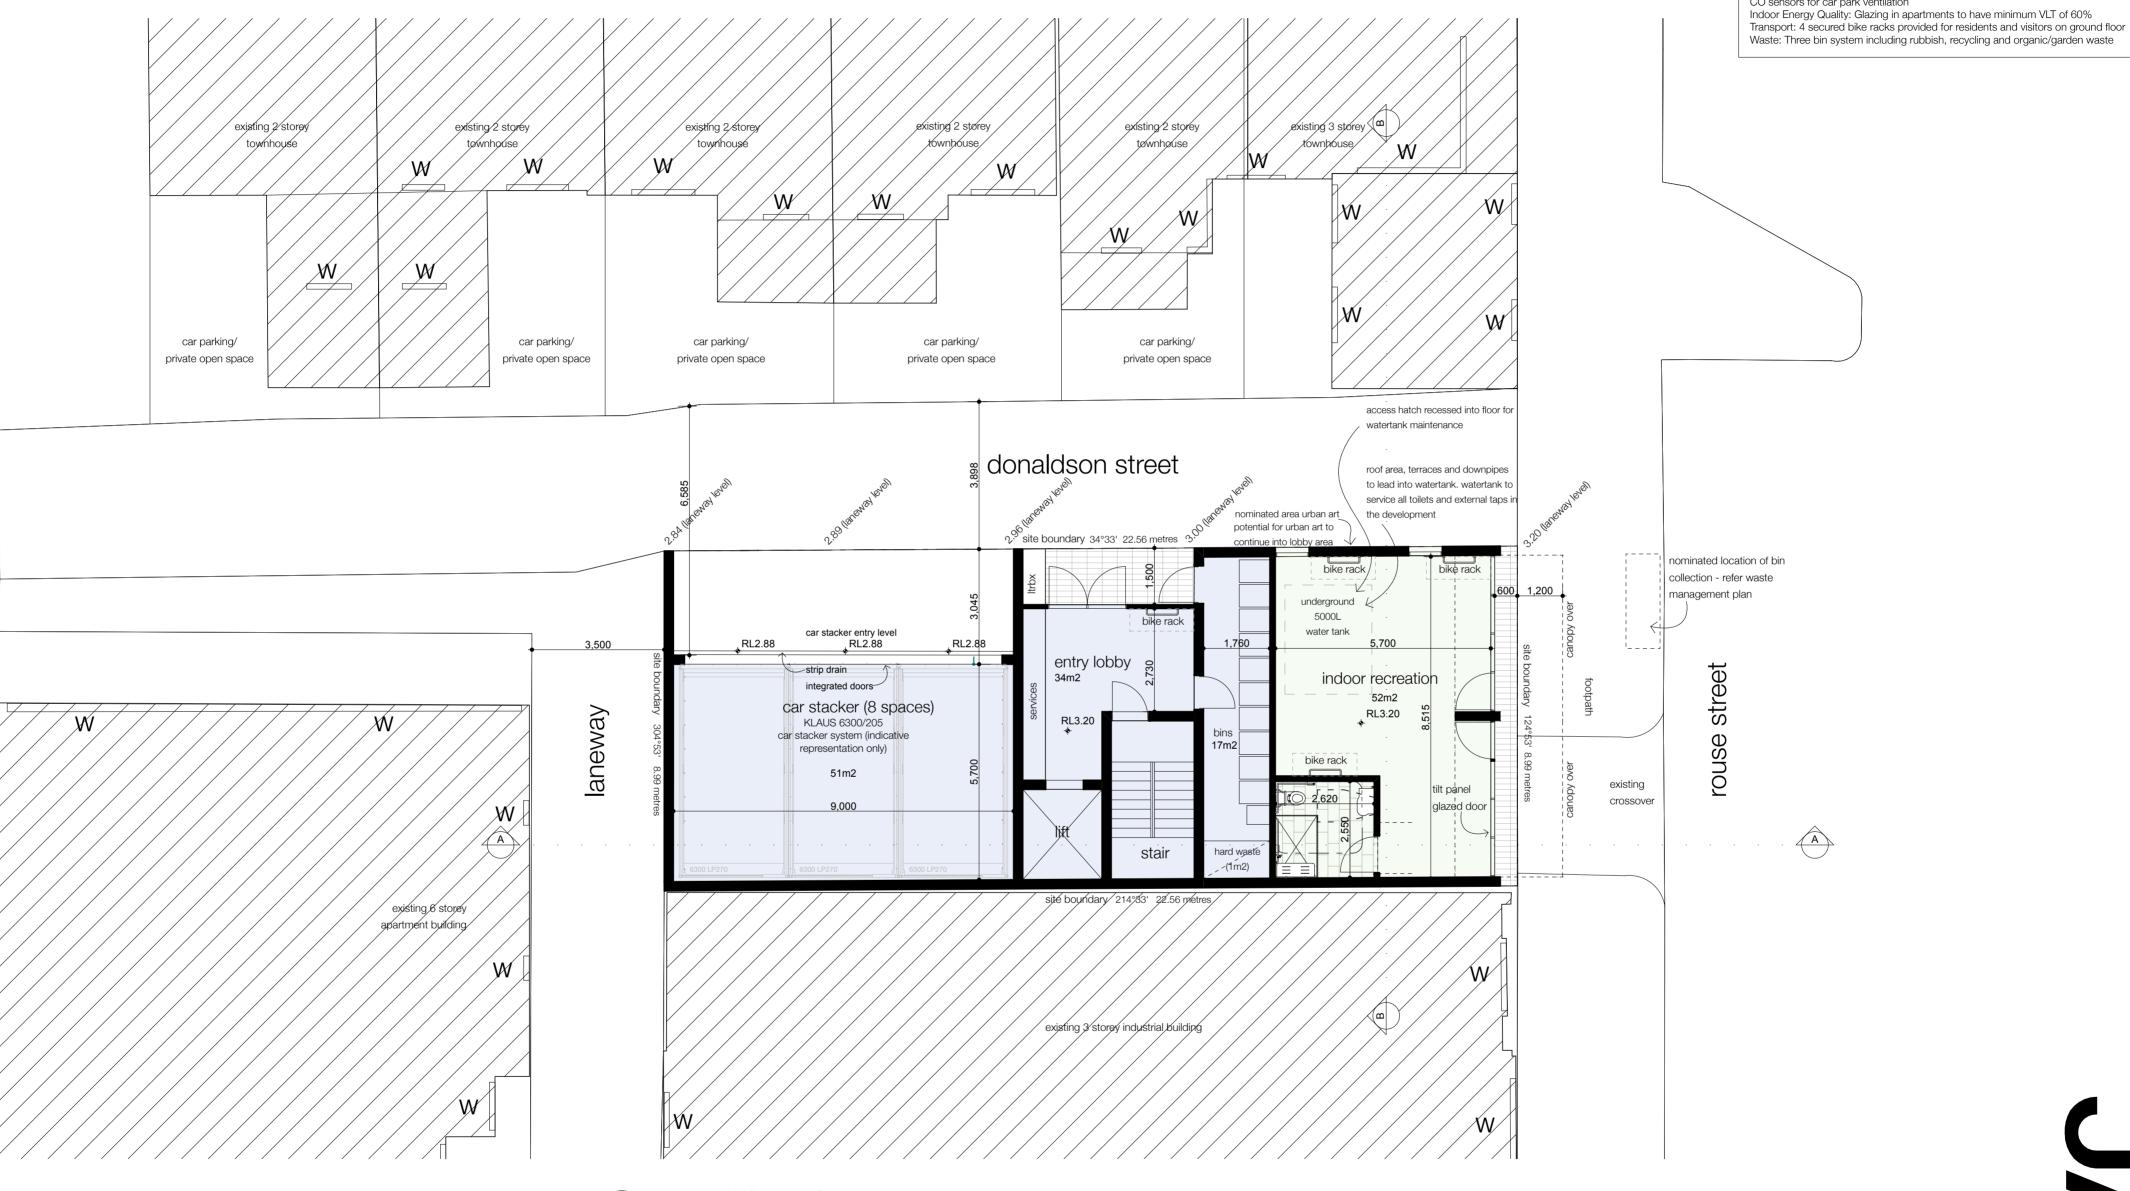Waste: Three bin system including rubbish, recycling and organic/garden waste



ground floor plan

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Project Apartment Development 223 Rouse Street, Port Melbourne VIC Address

JGK Investments Pty Ltd Client Date 18/8/2022 Drawn

**TP05** Dwg No. 2123 Project No. Revision

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Waste: Three bin system including rubbish, recycling and organic/garden waste

General Notes
WELS rating for fittings and fixtures to be minimum 5 star

Energy Efficiency:

City of Port Phillip
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Planning Application No. PDPL/01407/2021
No. of Pages: 6 of 25

No. of Pages: 6 of 25

average 6.5 star energy rating across development max illumination power density (W/m2) of the development meets the requirements in NCC 2019

Lighting sensors to all external lighting

CO sensors for car park ventilation

Indoor Energy Quality: Glazing in apartments to have minimum VLT of 60%

Transport: 4 secured bike racks provided for residents and visitors on ground floor


1.7mH translucent

terrace

glass balustrade

opaque glass window up

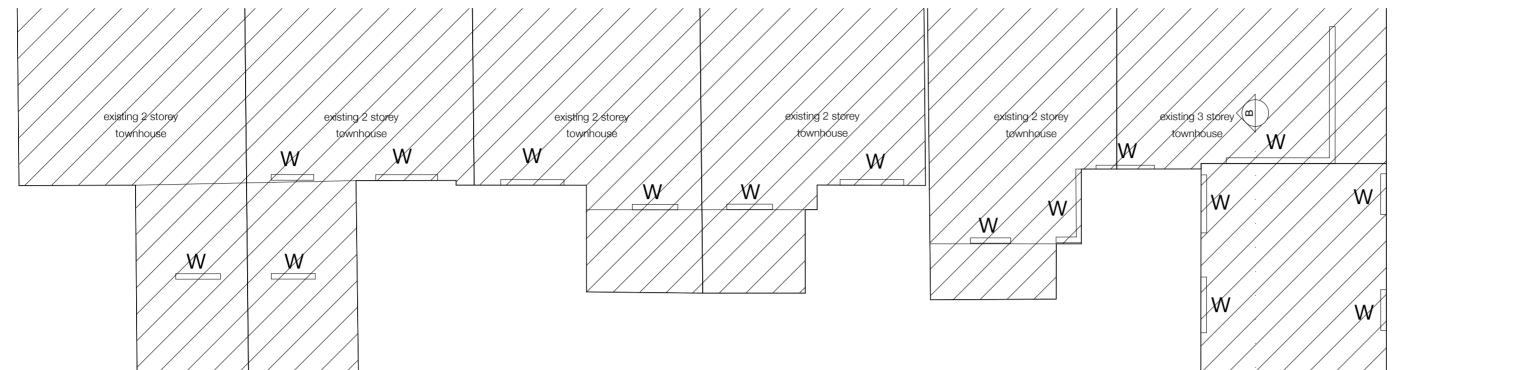to 1.7mH above floor level




opaque glass window up

to 1.7mH above floor level

donaldson street

opaque glass balustrade up to 1.7mH above floor level

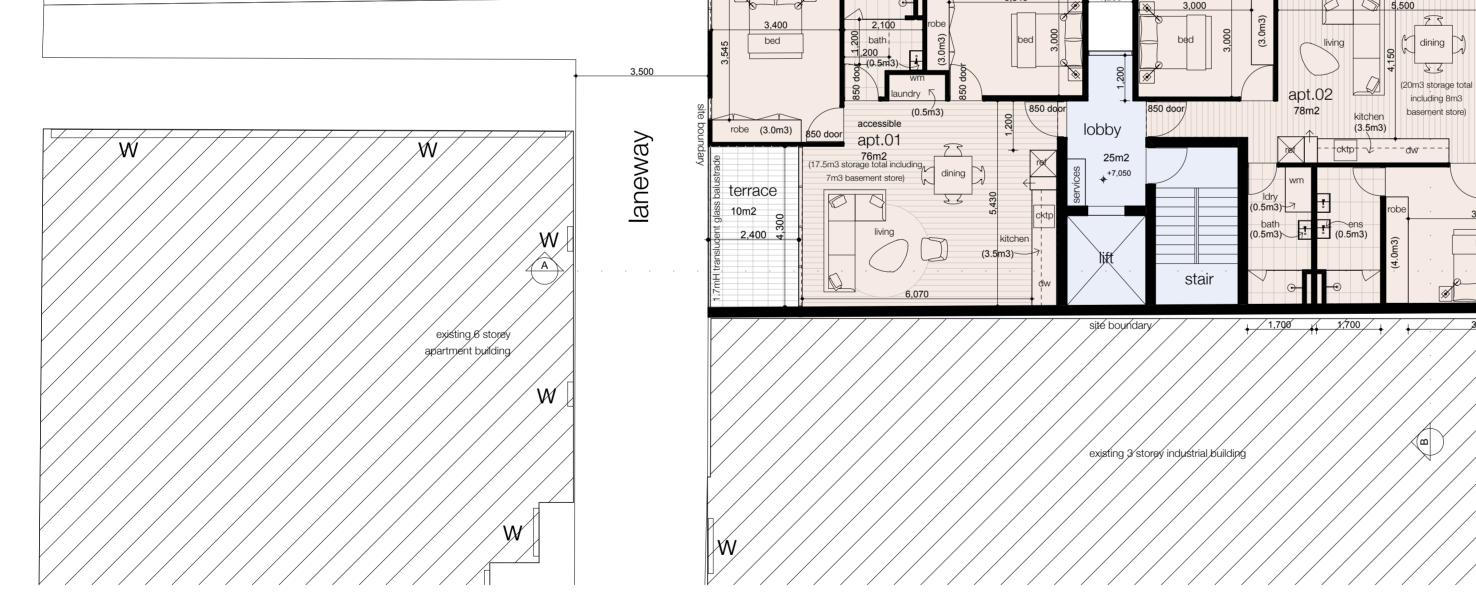site boundary/



first floor plan

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Address Apartment Development

223 Rouse Street, Port Melbourne VIC

Client JGK Investments Pty Ltd

Date 18/8/2022 Drawn

Dwg No. TP06

Project No. 2123 Revision

street

rouse

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max illumination power density (W/m2) of the development meets the requirements in NCC 2019

Indoor Energy Quality: Glazing in apartments to have minimum VLT of 60%

Transport: 4 secured bike racks provided for residents and visitors on ground floor Waste: Three bin system including rubbish, recycling and organic/garden waste

average 6.5 star energy rating across development

Lighting sensors to all external lighting CO sensors for car park ventilation

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Address	223 Rouse Street, Port Melbourne VIC		

Client	JGK Investments Pty Ltd			
	18/8/2022	Drawn		

rouse street

max illumination power density (W/m2) of the development meets the requirements in NCC 2019

Indoor Energy Quality: Glazing in apartments to have minimum VLT of 60%

Transport: 4 secured bike racks provided for residents and visitors on ground floor Waste: Three bin system including rubbish, recycling and organic/garden waste

average 6.5 star energy rating across development

Lighting sensors to all external lighting CO sensors for car park ventilation

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third floor plan

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Project	Apartment Development	
Address	223 Rouse Street, Port Melbourne VIC	

Client	JGK Investments Pty Ltd		
Date	18/8/2022	Drawn	

Dwg No.

rouse street

max illumination power density (W/m2) of the development meets the requirements in NCC 2019

Indoor Energy Quality: Glazing in apartments to have minimum VLT of 60%
Transport: 4 secured bike racks provided for residents and visitors on ground floor
Waste: Three bin system including rubbish, recycling and organic/garden waste

average 6.5 star energy rating across development

Lighting sensors to all external lighting CO sensors for car park ventilation

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donaldson street

opaque glass window up to/1.7mH above floor level

site boundary

opaque glass window up

to/1.7mH above floor level

existing 6 storey apartment building

bed 3,000 3,500 130m2 2,000 apt.06 laneway robe (4.0m3 12m2 robe (4.0m3 terrace (32.5m3 storage total including (4.0m3) robe 8m3 basement store) 3,600 pantry (6.0m3) kitchen ensuite (0.5m3) 

of f

fourth floor plan

scale 1:100

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Address Apartment Development

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Client JGK Investments Pty Ltd

Date 18/8/2022 Drawn

Dwg No. TPO9

Project No. 2123 Revision

street

rouse

1,000

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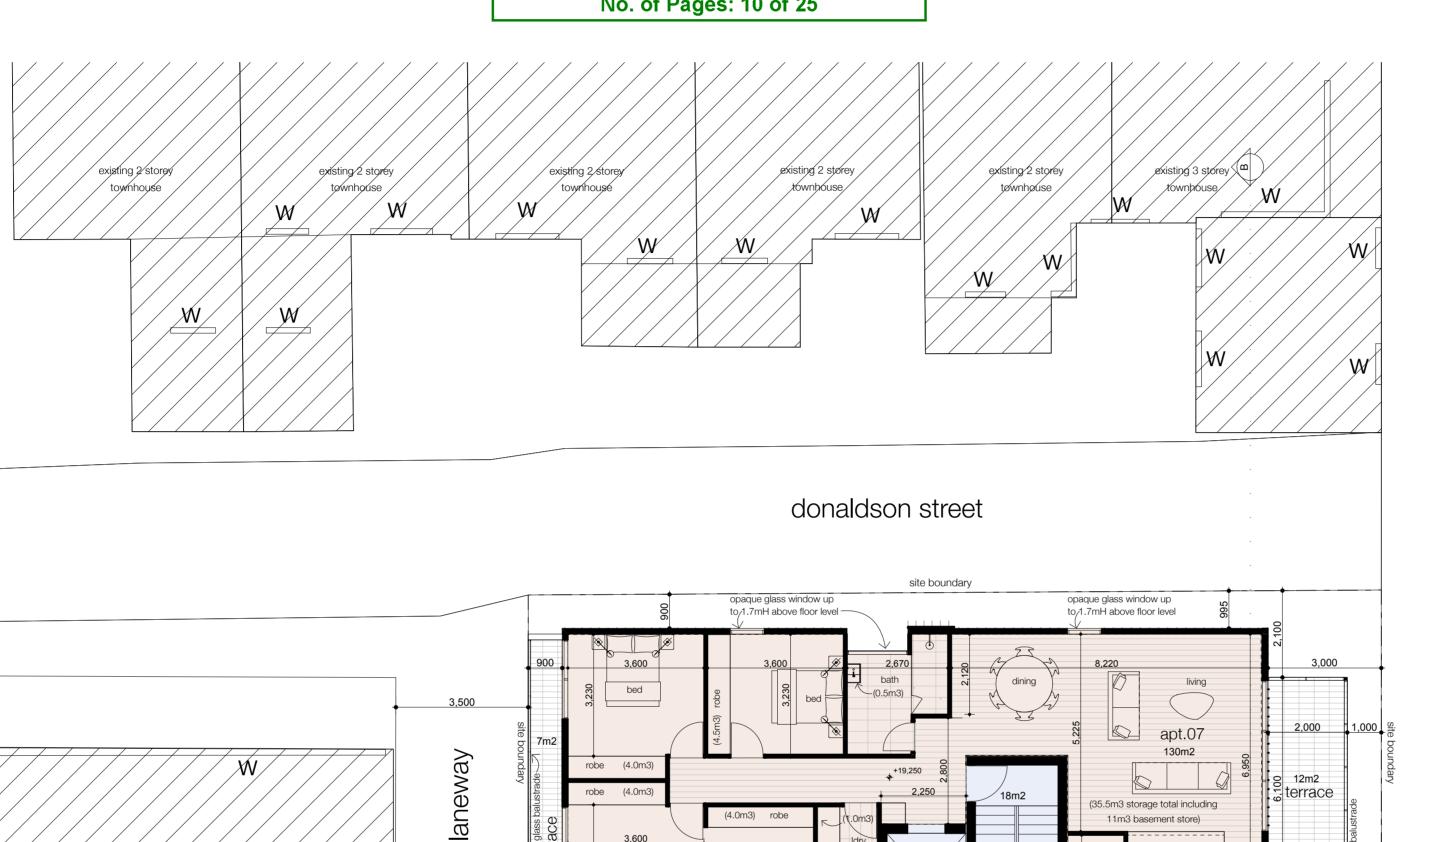
max illumination power density (W/m2) of the development meets the requirements in NCC 2019

Indoor Energy Quality: Glazing in apartments to have minimum VLT of 60%
Transport: 4 secured bike racks provided for residents and visitors on ground floor
Waste: Three bin system including rubbish, recycling and organic/garden waste

average 6.5 star energy rating across development

Lighting sensors to all external lighting CO sensors for car park ventilation

City of Port Phillip
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fifth floor plan

Notes

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Address Apartment Development

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Client JGK Investments Pty Ltd

Date 18/8/2022 Drawn

(6.0m3)

kitchen

- <del>-</del>cktp <del>-</del> - - - - -

Dwg No. TP10

Project No. 2123 Revision

rouse street

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max illumination power density (W/m2) of the development meets the requirements in NCC 2019

Indoor Energy Quality: Glazing in apartments to have minimum VLT of 60%

Transport: 4 secured bike racks provided for residents and visitors on ground floor Waste: Three bin system including rubbish, recycling and organic/garden waste

average 6.5 star energy rating across development

Lighting sensors to all external lighting CO sensors for car park ventilation

**City of Port Phillip** Advertised Plan Planning Application No. PDPL/01407/2021

No. of Pages: 11 of 25 existing 3 storey m existing 2/storev townhouse townbouse/ tøwnhøuse j

donaldson street

site boundary

pv panels (2.5kW system) 1.2mH glass balustrade +22,300 1,500 laneway balustrade 900 900 4,500 78m2 roof terrace provide glass balustrade to ensure min. 1.0m height 1.2mH lift between top of planter and top of lift overrui stair to terrace

roof plan

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**Apartment Development** Project Address 223 Rouse Street, Port Melbourne VIC

JGK Investments Pty Ltd Date 18/8/2022 Drawn

TP**11** Dwg No. 2123 Project No. Revision

rouse street

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Newtown Victoria 3220

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+24,800\_

+22,300

+19,250 fifth floor

+16,200 fourth floor

+13,150

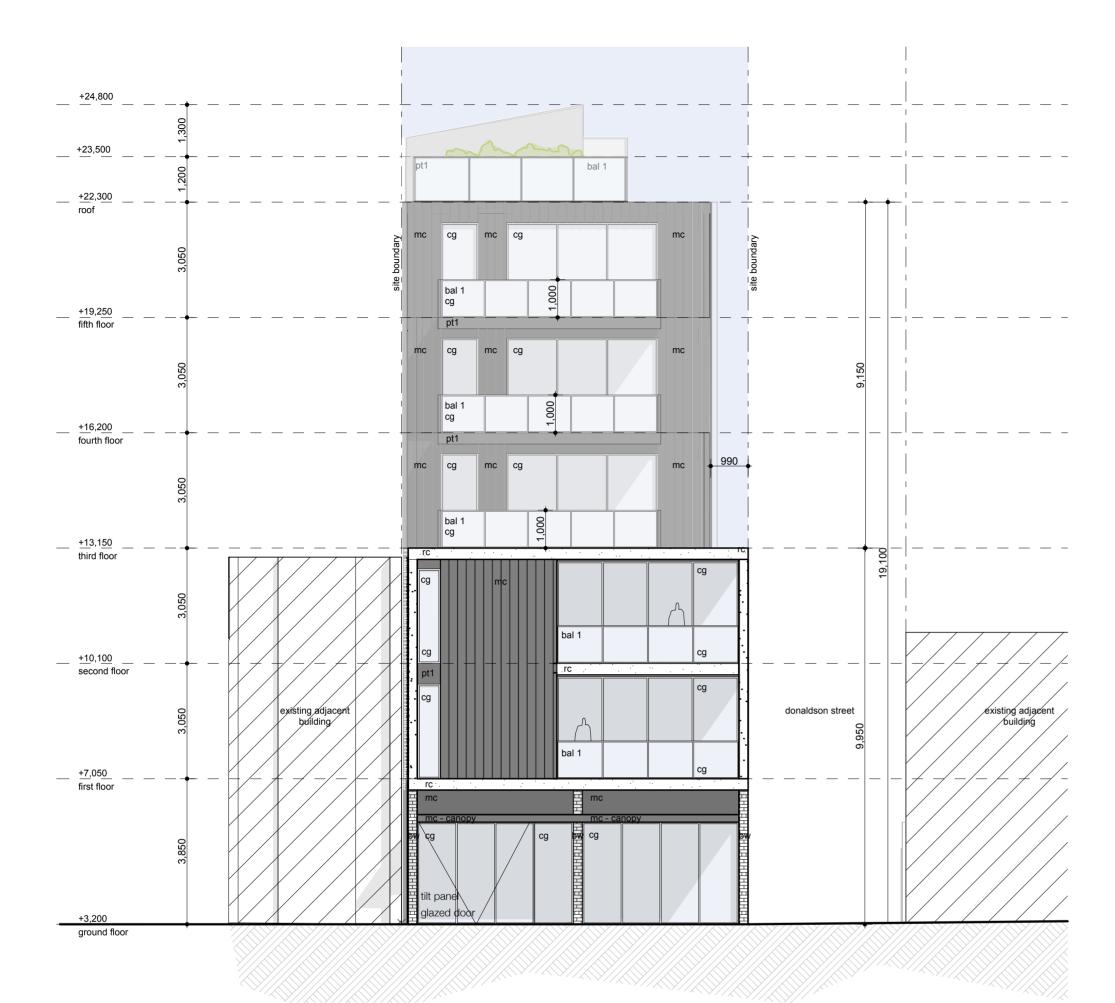
+10,100

+7,050

first floor

+3,200

second floor



# north east elevation

scale 1:100 all elevation levels to AHD

metal cladding

rendered cladding





face brickwork (grey)

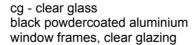


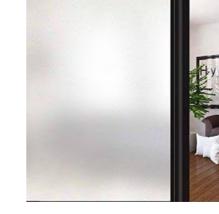
paint (dark grey) to concrete



cg - clear glass black powdercoated aluminium







south west elevation

scale 1:100 all elevation levels to AHD

tg - translucent glass

(max 25% transparency)

black powdercoated aluminium

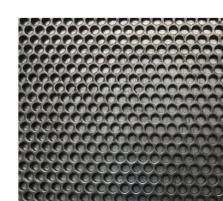
window frame, translucent glazing

existing adjacent building



Dwg No.

framed clear glass balustrade



car stacker shown dashed

scr - 150x150mm equal angle vertical screen powdercoated black

fc - fibre cement sheet painted black

bal 2



perforated screen to car stacker (grey)

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existing adjacent building

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**City of Port Phillip** 

**Advertised Plan** 

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Client JGK Investments Pty Ltd Date 18/8/2022 Drawn

TP**12** 2123 Project No. Revision



### north west elevation

face brickwork (grey)

scale 1:100 all elevation levels to AHD



metal cladding



rendered cladding

relevant statutory authorities. Floor Areas shown are generally

of JAM Architects Pty Ltd®







paint (dark grey) to concrete



cg - clear glass black powdercoated aluminium

window frames, clear glazing



tg - translucent glass

(max 25% transparency)

black powdercoated aluminium

window frame, translucent glazing





framed clear glass balustrade

perforated screen to car stacker (grey)



scr - 150x150mm equal angle vertical screen powdercoated black

fc - fibre cement sheet painted black

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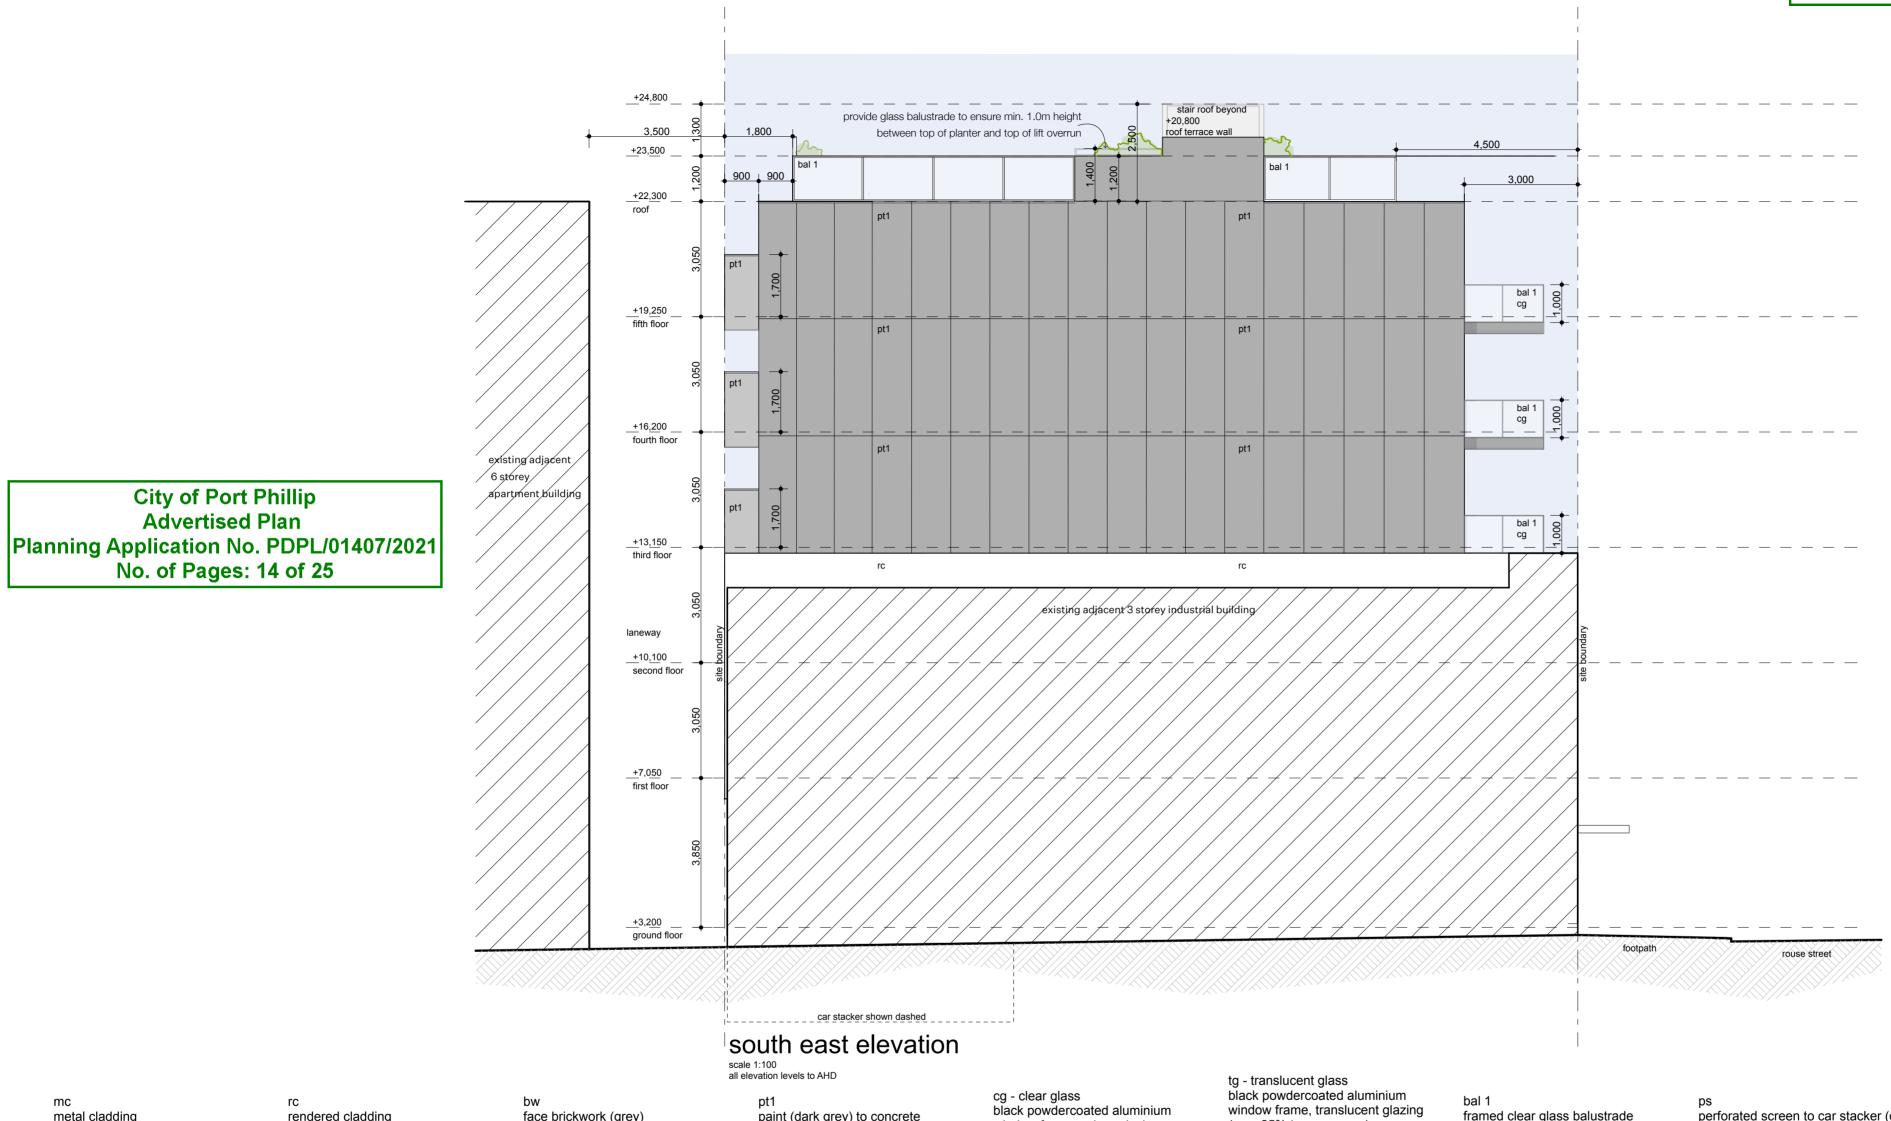
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Address 223 Rouse Street, Port Melbourne VIC

Apartment Development

Client JGK Investments Pty Ltd Date 18/8/2022 Drawn

TP**13** Dwg No. 2123 Project No. Revision



metal cladding




**City of Port Phillip** 

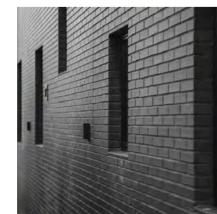**Advertised Plan** 

rendered cladding





face brickwork (grey)

paint (dark grey) to concrete

window frames, clear glazing

tg - translucent glass black powdercoated aluminium window frame, translucent glazing (max 25% transparency)



framed clear glass balustrade



perforated screen to car stacker (grey)

scr - 150x150mm equal angle vertical screen powdercoated black

fc - fibre cement sheet painted black

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Apartment Development Project 223 Rouse Street, Port Melbourne VIC Address

Client JGK Investments Pty Ltd Date 18/8/2022 Drawn

TP**14** Dwg No.


Revision

2123

Project No.

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Address Apartment Development

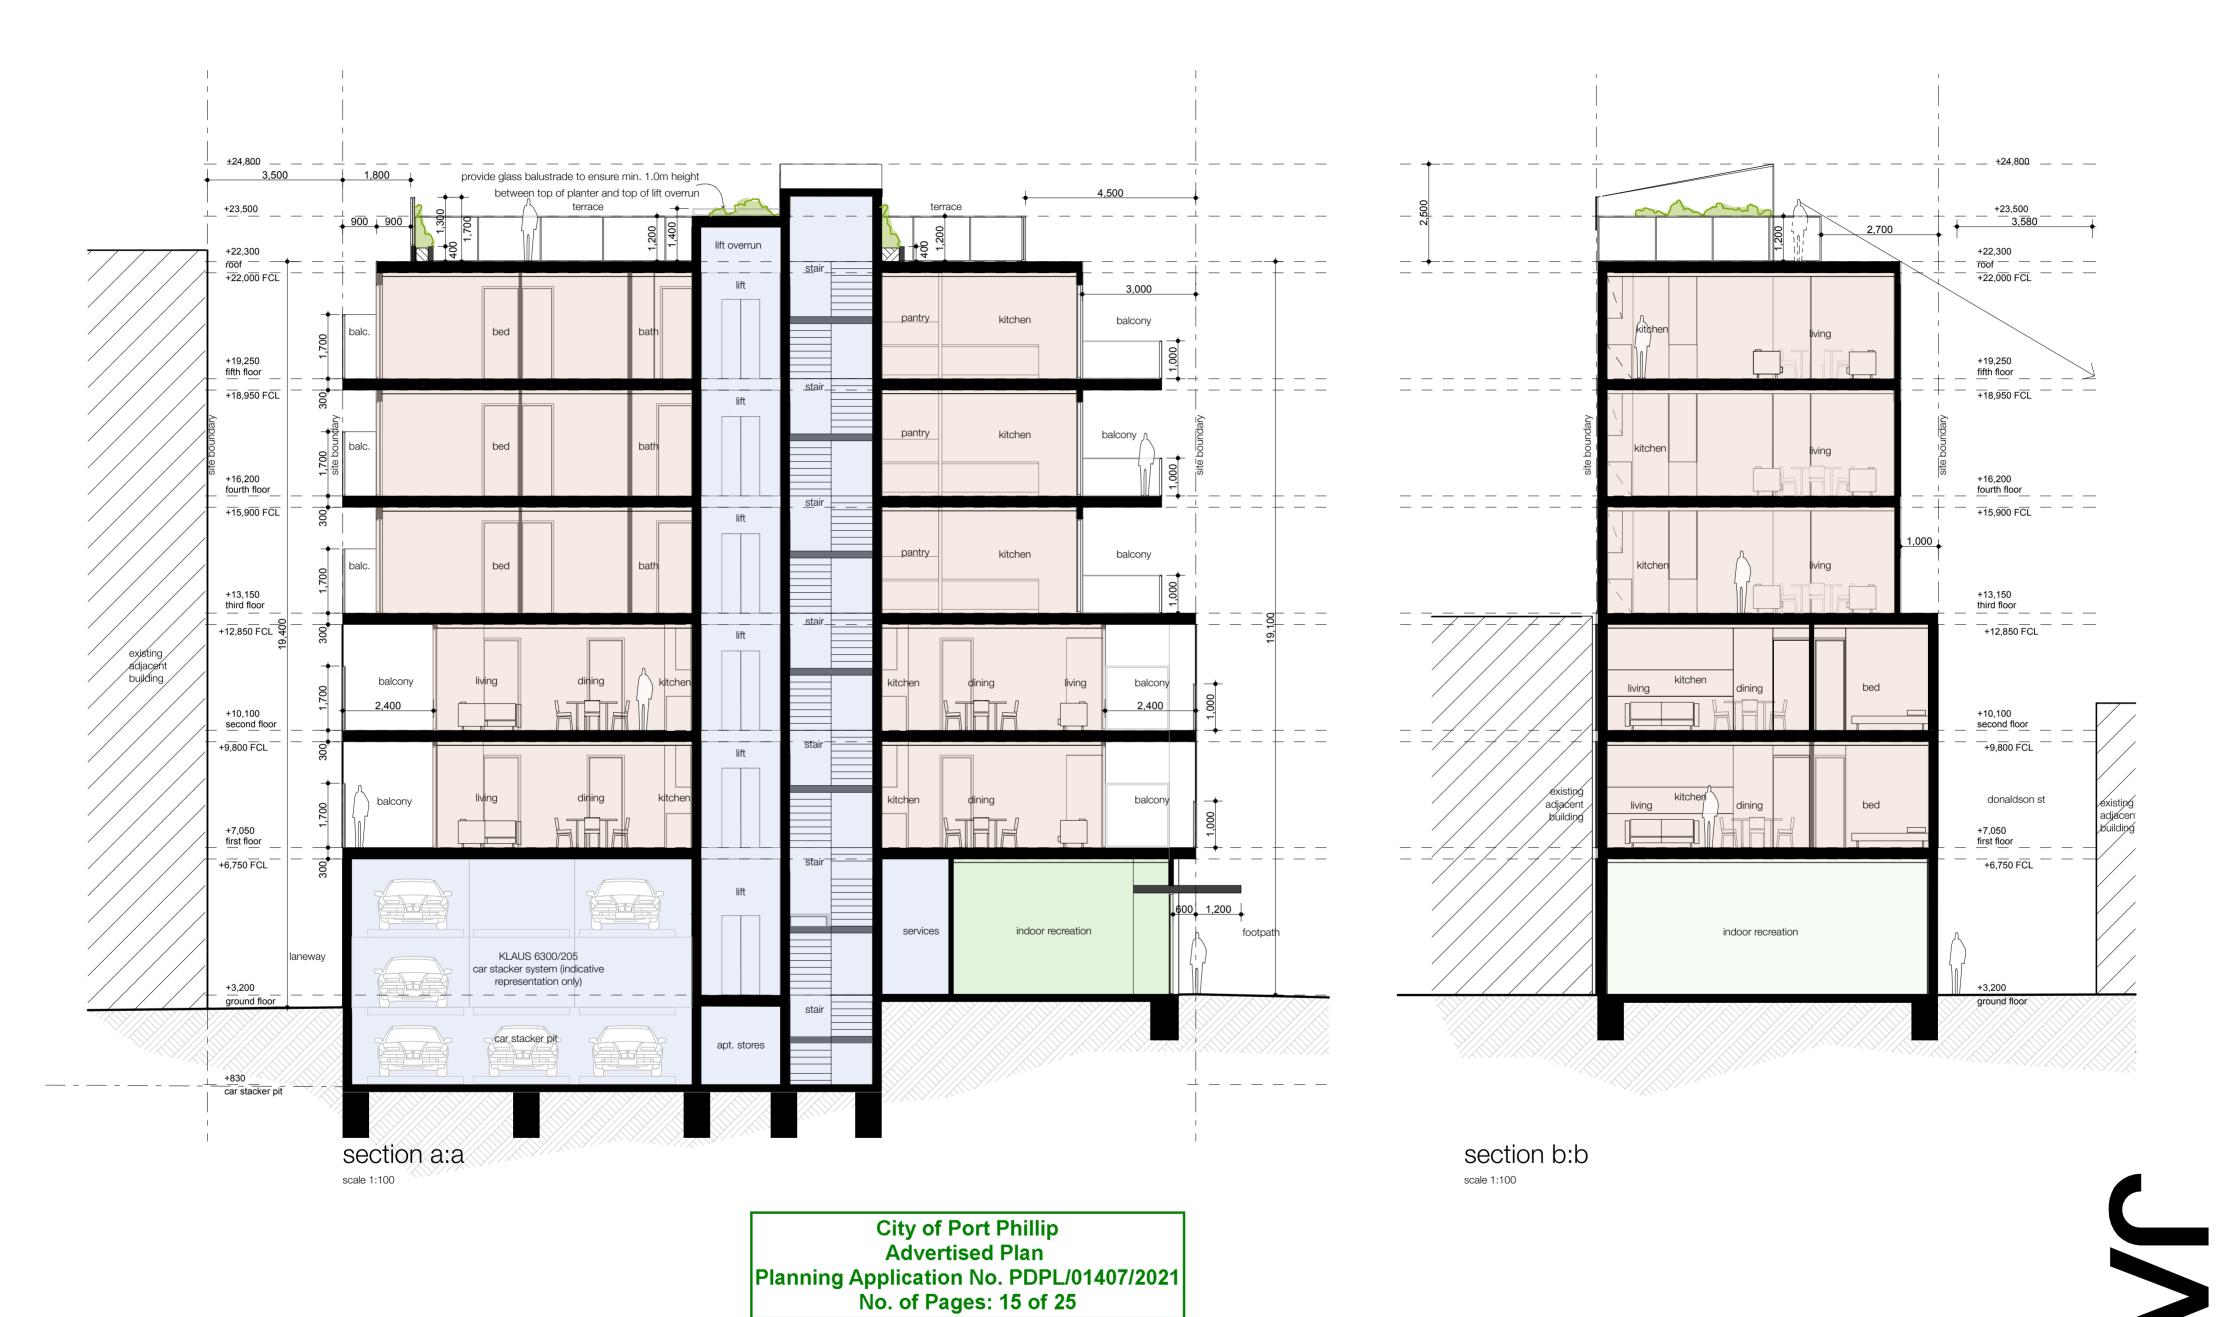223 Rouse Street, Port Melbourne VIC

Client JGK Investments Pty Ltd

Date 18/8/2022 Drawn

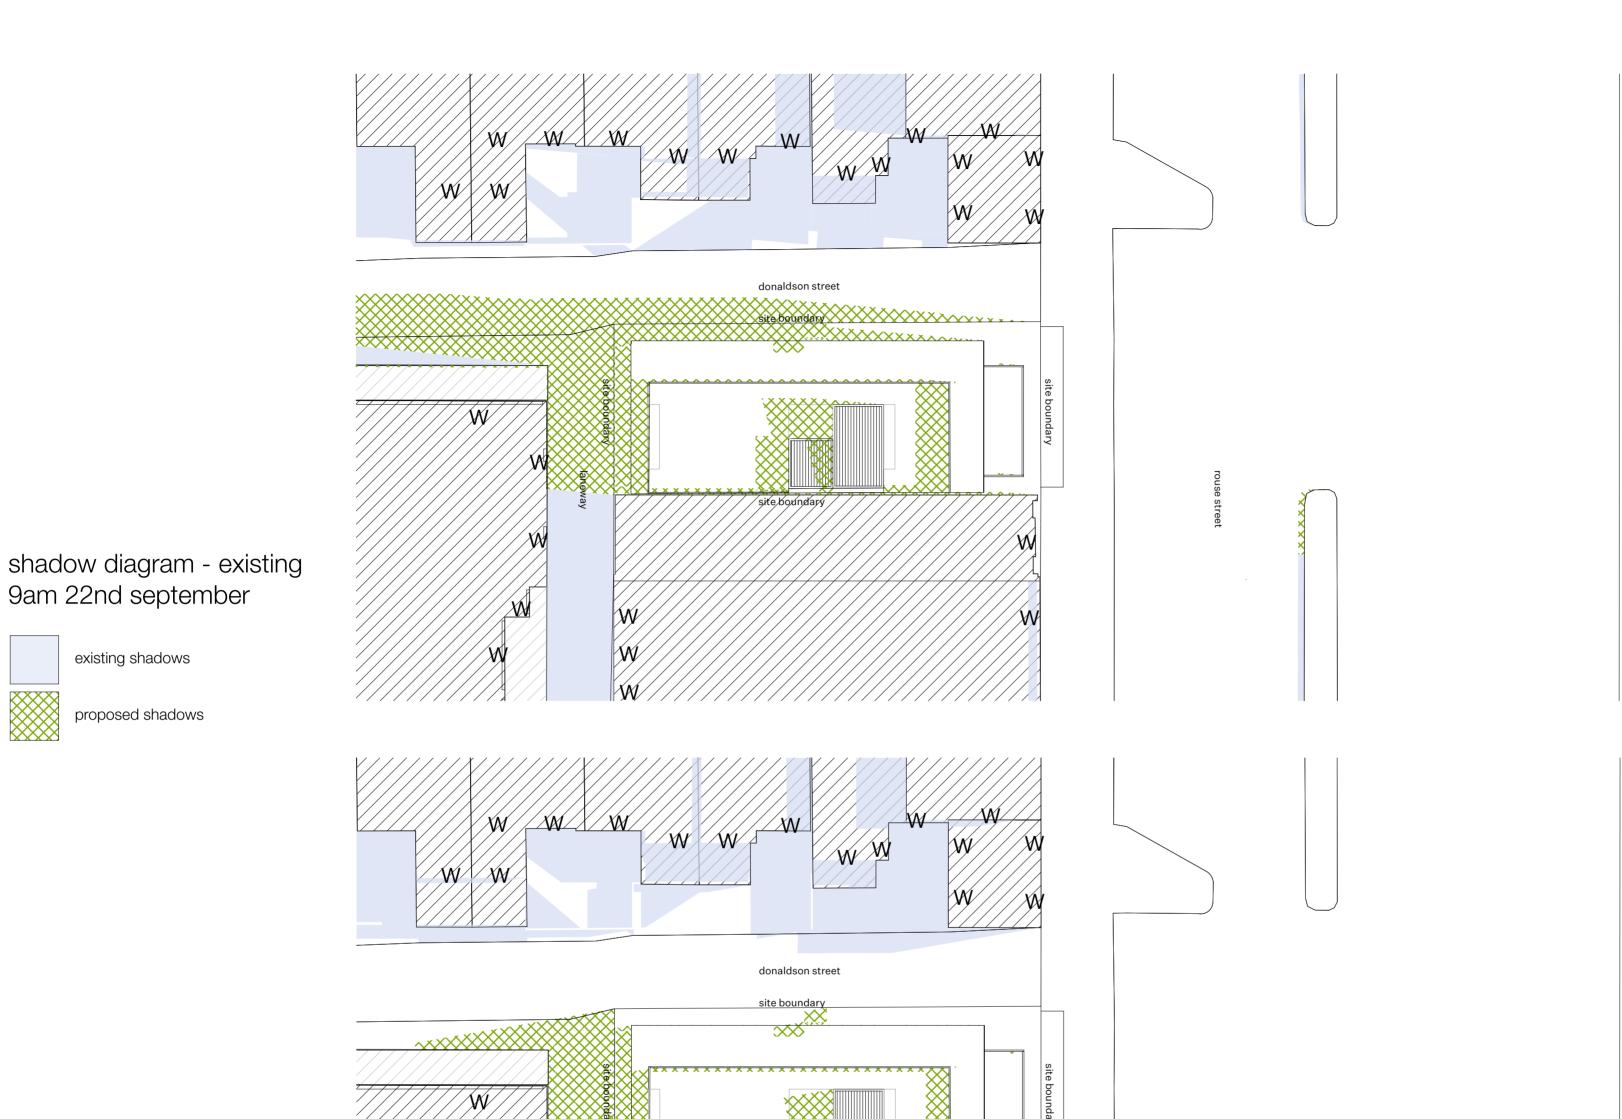
Dwg No. TP15

Project No. 2123 Revision

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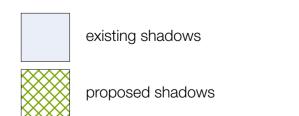
**City of Port Phillip Advertised Plan** Planning Application No. PDPL/01407/2021 No. of Pages: 16 of 25

## shadow diagram - existing 10am 22nd september

9am 22nd september

existing shadows

proposed shadows



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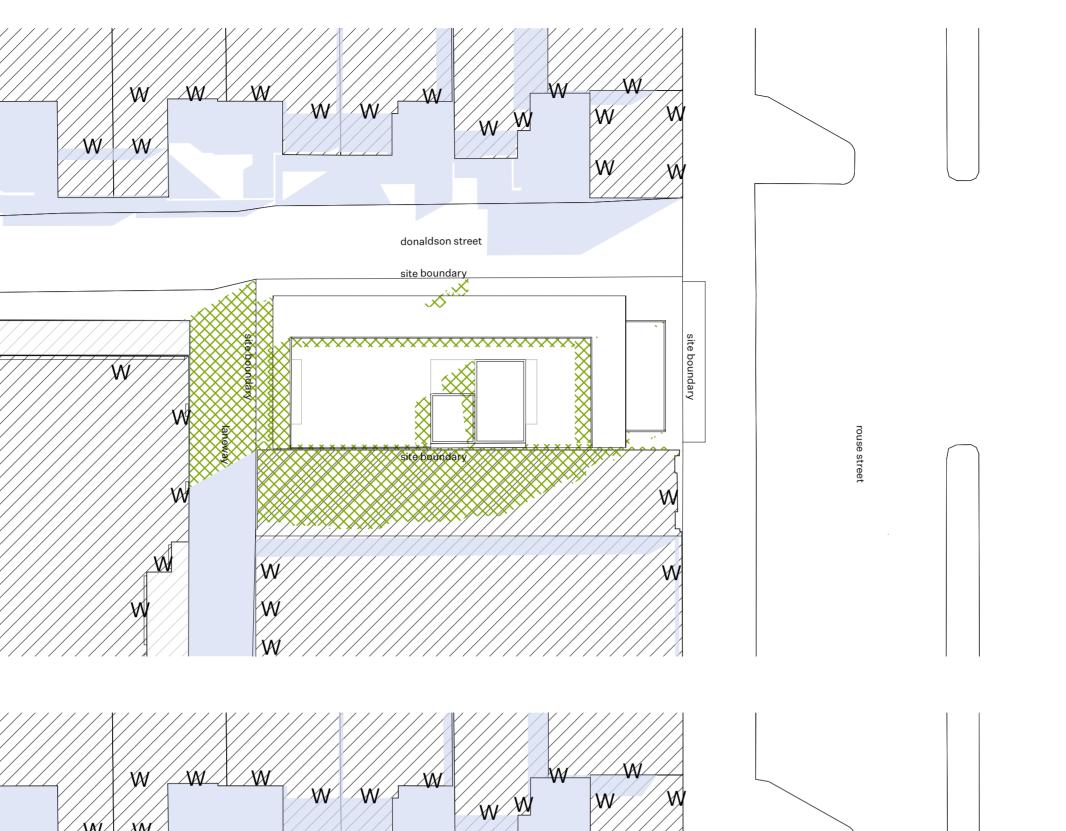
JGK Investments Pty Ltd 18/8/2022 Date Drawn

TP**16** Dwg No. Project No. 2123 Revision

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# W/W donaldson street


## shadow diagram - existing 12pm 22nd september

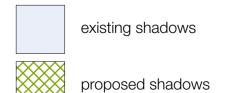shadow diagram - existing

11am 22nd september

existing shadows

proposed shadows



Notes

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**Apartment Development** Project

Address

223 Rouse Street, Port Melbourne VIC

Client JGK Investments Pty Ltd 18/8/2022 Date Drawn

TP**17** Dwg No. Project No. 2123 Revision

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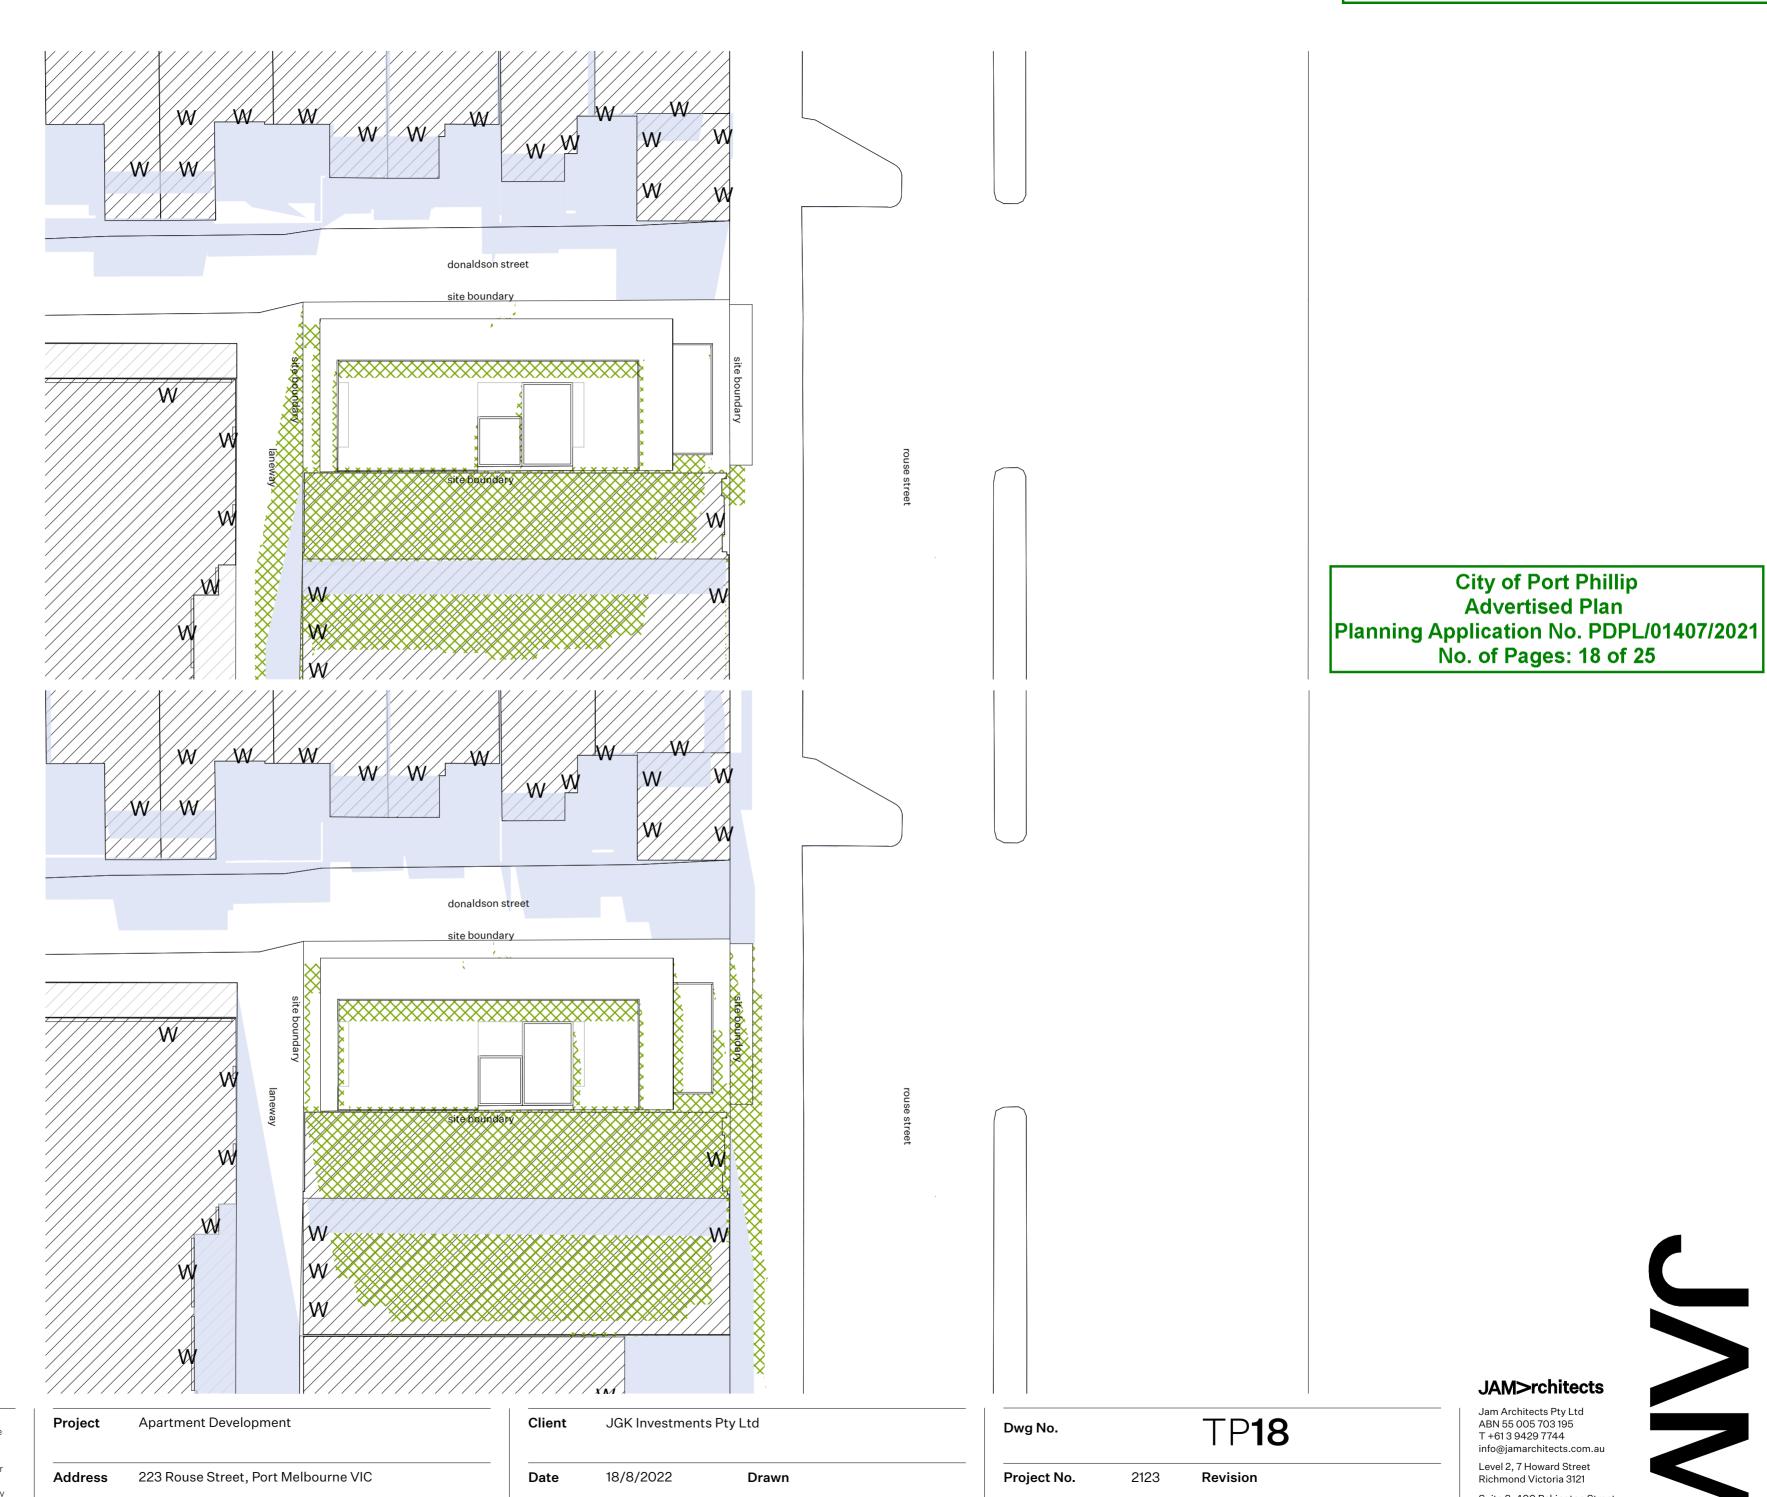
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City of Port Phillip

Advertised Plan

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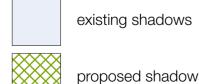


shadow diagram - existing 1pm 22nd september

existing shadows

proposed shadows

shadow diagram - existing 2pm 22nd september



proposed shadows

Notes

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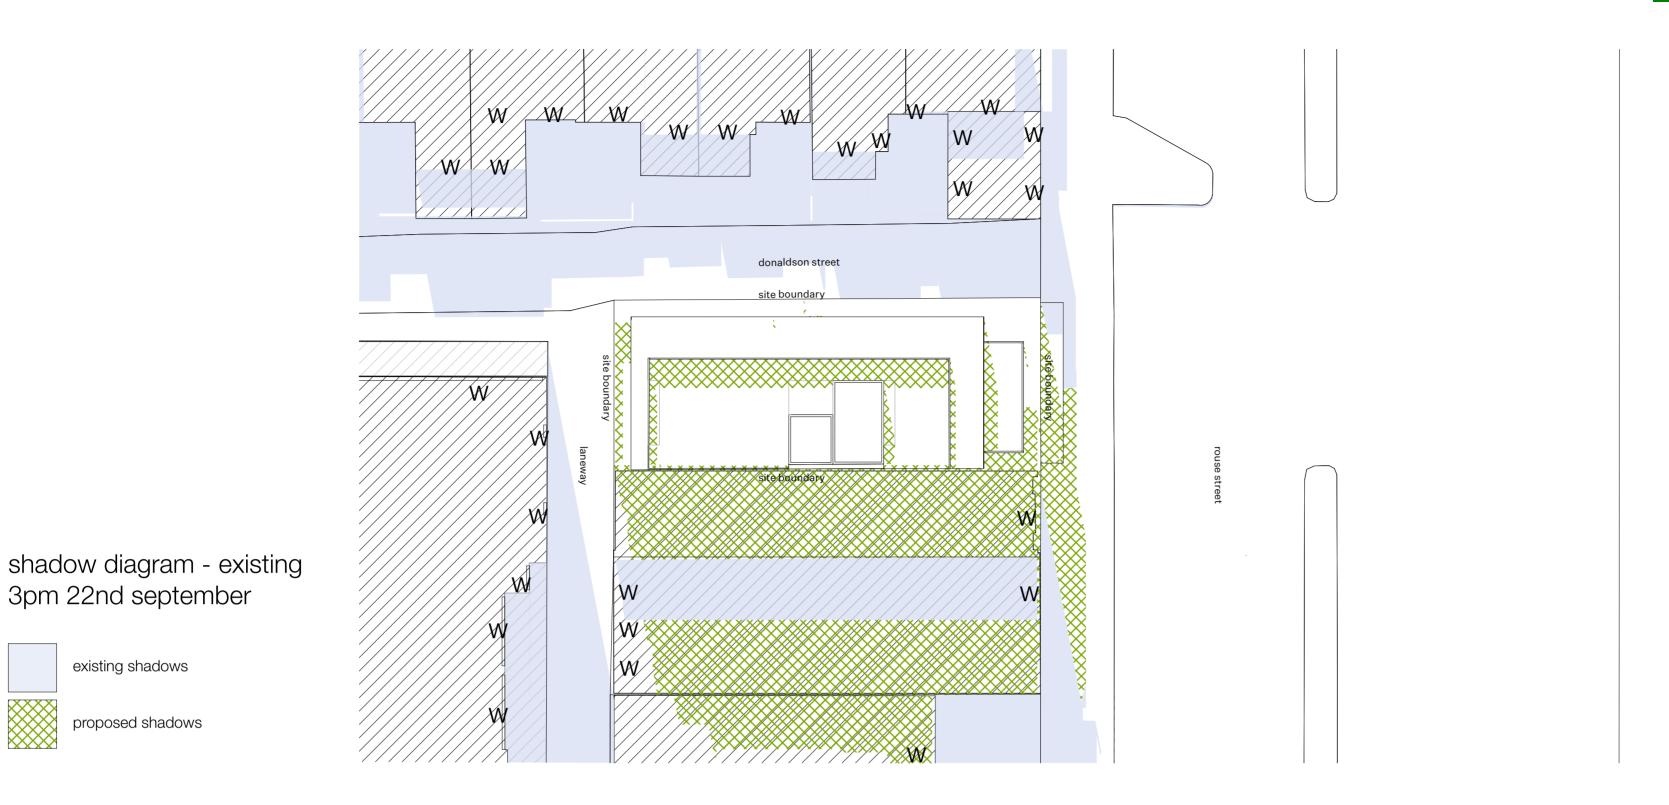
Document Set ID: 6494032 Version: 2, Version Date: 02/09/2022 JAM>rchitects

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**City of Port Phillip** Advertised Plan Planning Application No. PDPL/01407/2021 No. of Pages: 19 of 25

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3pm 22nd september

existing shadows

proposed shadows

Apartment Development Project Address 223 Rouse Street, Port Melbourne VIC

Client	JGK Investments Pty Ltd			
Date	18/8/2022	Drawn		

Dwg No.		TP <b>19</b>	
Project No.	2123	Revision	



City of Port Phillip
Advertised Plan
Planning Application No. PDPL/01407/2021
No. of Pages: 20 of 25



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Address Apartment Development

223 Rouse Street, Port Melbourne VIC

Client JGK Investments Pty Ltd

Date 18/8/2022 Drawn

Dwg No. TP20

Project No. 2123 Revision

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Address Apartment Development

223 Rouse Street, Port Melbourne VIC

Client JGK Investments Pty Ltd

Date 18/8/2022 Drawn

Dwg No. TP21

Project No. 2123 Revision

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Address Apartment Development

223 Rouse Street, Port Melbourne VIC

Client JGK Investments Pty Ltd

Date 18/8/2022 Drawn

Dwg No. TP22

Project No. 2123 Revision

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Address Apartment Development

223 Rouse Street, Port Melbourne VIC

Client JGK Investments Pty Ltd

Date 18/8/2022 Drawn

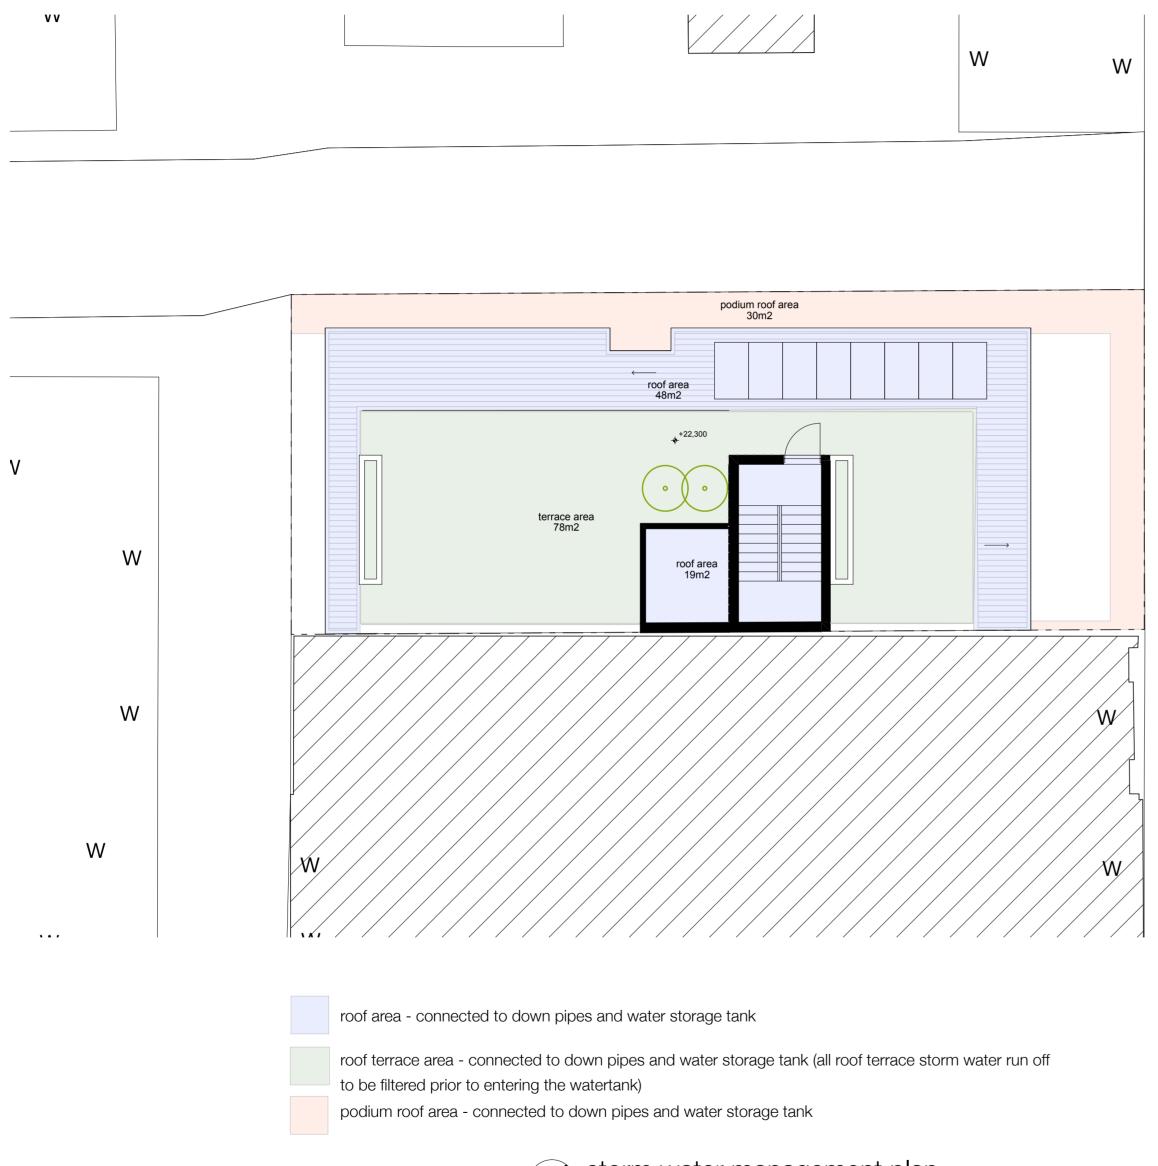
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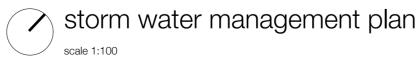
Project No. 2123 Revision

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# City of Port Phillip Advertised Plan Planning Application No. PDPL/01407/2021 No. of Pages: 24 of 25





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Project	Apartment Development
Address	223 Rouse Street, Port Melbourne VIC

Client	JGK Investments	s Pty Ltd	
Date	18/8/2022	Drawn	

### development summary

- site area = 203m2
- 7 apartments 17 bedrooms, 13 toilets (total for development)
- Total roof area = 175m2
- Rainwater tank = 5,000 Litre capacity
- STORM rating = 170

### proposed respons

The proposed development achieves the water sensitive urban design (WSUD) objectives of the Port Phillip City Council by water harvesting and re-use. A Melbourne STORM assessment is included below to demonstrate in-operation compliance with best-practice stormwater treatment objectives as set out in the Urban Stormwater Best Practice Environmental Guidelines. The proposed development achieves a stormwater treatment STORM tool score of 170m2 (100% or greater achieves compliance) with the following parameters

- Rainwater shed from all roofs (175m2) will be collected in rainwater storage tank with a minimum capacity of 5,000L total.
- Filtering system to be installed to rain water tank.

  Leaf diverting rainwater heads and first flush diverters will be incorporated upstream of the water storage tank to divert the initial sediment flow
- when rain events occur from flowing into the tank

  The reinputer took will go to all tailet eight read all externel took. In addition to stormwater handfur this conturn of water provides water.

The rainwater tank will serve all toilet cisterns and all external taps. In addition to stormwater benefits, this capture of water provides water aving benefits

### site management during construction

- Sediment traps or drain filters to be installed to all pit inlets
- Temporary downpipes connected to stormwater mains to be installed as soon as roofing is installed to prevent overland flow
- All vehicle entrances to site to be crushed rock and rumble grates installed
   Provide adequate and appropriate bins for workers, specifically where food is consumed to avoid litter being washed from site
- Locate stockpiled building materials away from drainage paths on site, to avoid stormwater contamination

### maintenance pla

- Filters to water tank inlet to be cleaned every 2 months
- First flush device to water tank inlet to be cleaned every 2 months
- Tank overflow/outlet to be flushed every 2 months
- Roof and gutters to be cleaned every 6 months

5,000 litre water storage tank to be connected to all toilet cisterns for toilet flushing is beneath the ground floor slab of the recreational facility.

### Nelbourne STORM Rating Report

Municipality: PORT PHILLIP
Rainfall Station: PORT PHILLIP
Address: 223 Rouse Street

Port Melbourne
VIC :

Assessor: Brooke Walter

Development Type: Residential - Mixed Use

Allotment Site (m2): 203.00

STORM Rating %: 170

2123

Project No.

Description	Impervious Area (m2)	Treatment Type	Treatment Area/Volume (m2 or L)	Occupants / Number Of Bedrooms	Treatment %	Tank Water Supply Reliability (%)
Roof Area	175.00	Rainwater Tank	5,000.00	17	170.00	82.00

Date Generated: 08-Mar-2022 Program Version:

Dwg No. TP24

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Revision

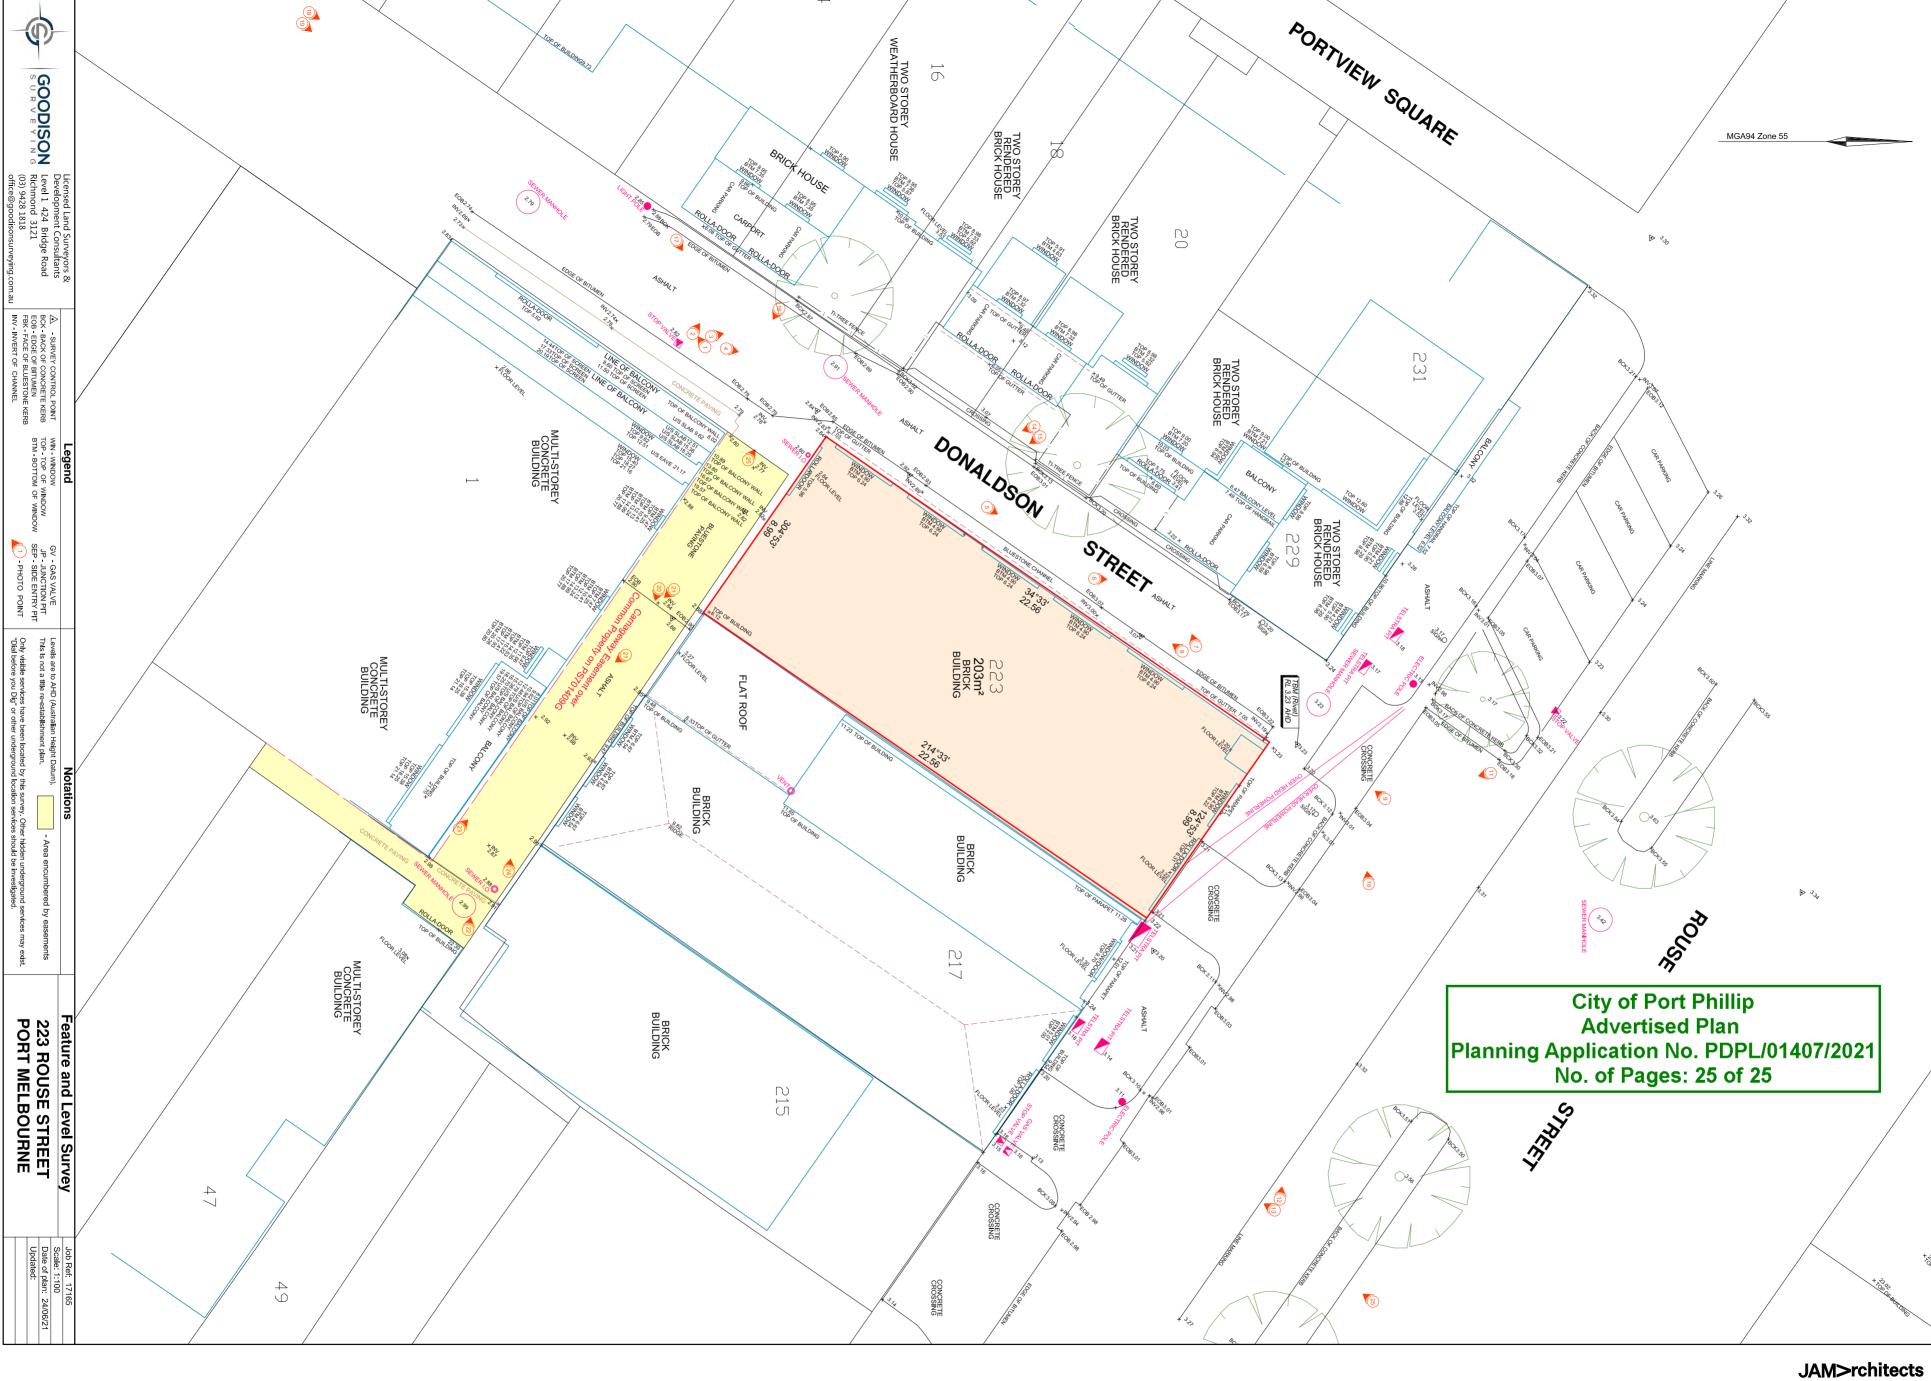
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Apartment Development Project Address 223 Rouse Street, Port Melbourne VIC

Client	JGK Investments Pty Ltd			
Date	18/8/2022	Drawn		

TP**25** Dwg No. 2123 Revision Project No.

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